



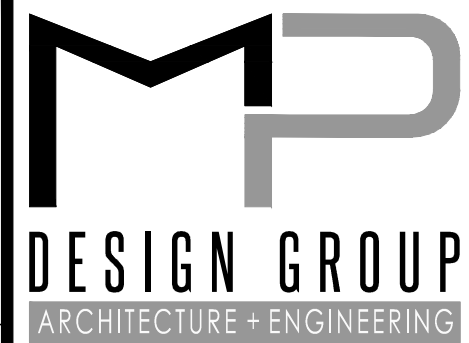
CENTRALBIDDING
FROM CENTRAL AUCTION HOUSE

Elevated Reefer Plugs
Mississippi State Port Authority

Project documents obtained from www.CentralBidding.com

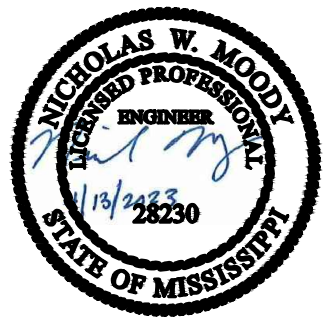
11-May-2023 12:13:53 PM

PORT OF GULFPORT MISSISSIPPI STATE PORT AUTHORITY ELEVATED REEFER PLUGS



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ELEVATED REEFER PLUGS
PORT OF GULFPORT MISSISSIPPI
STATE PORT AUTHORITY
30TH AVENUE
GULFPORT, MS 39501

SCALE: AS INDICATED
PROJECT NO: 0297.22.002
DRAWN BY: NWM
CHECKED BY: NWM

TITLE SHEET

NO.	DATE	REVISION / SUBMITTAL
REV 0	4/13/2023	ISSUED FOR CONSTRUCTION

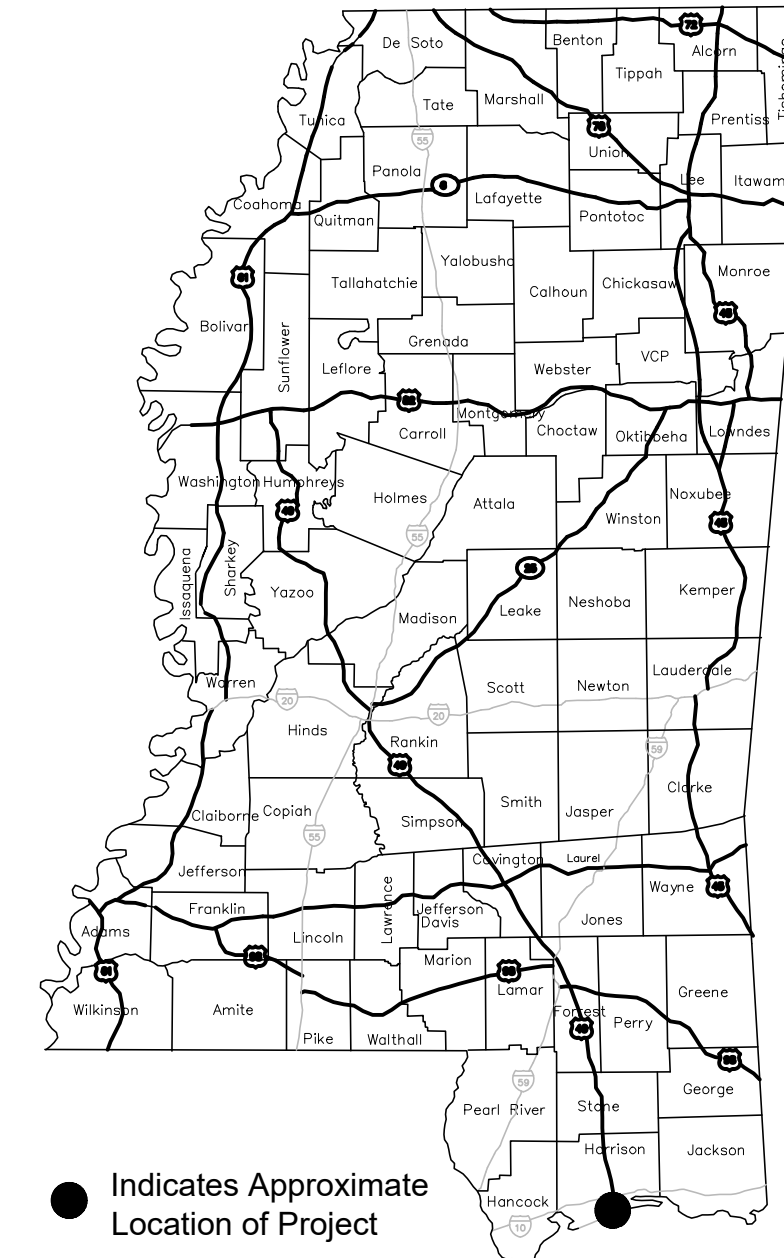
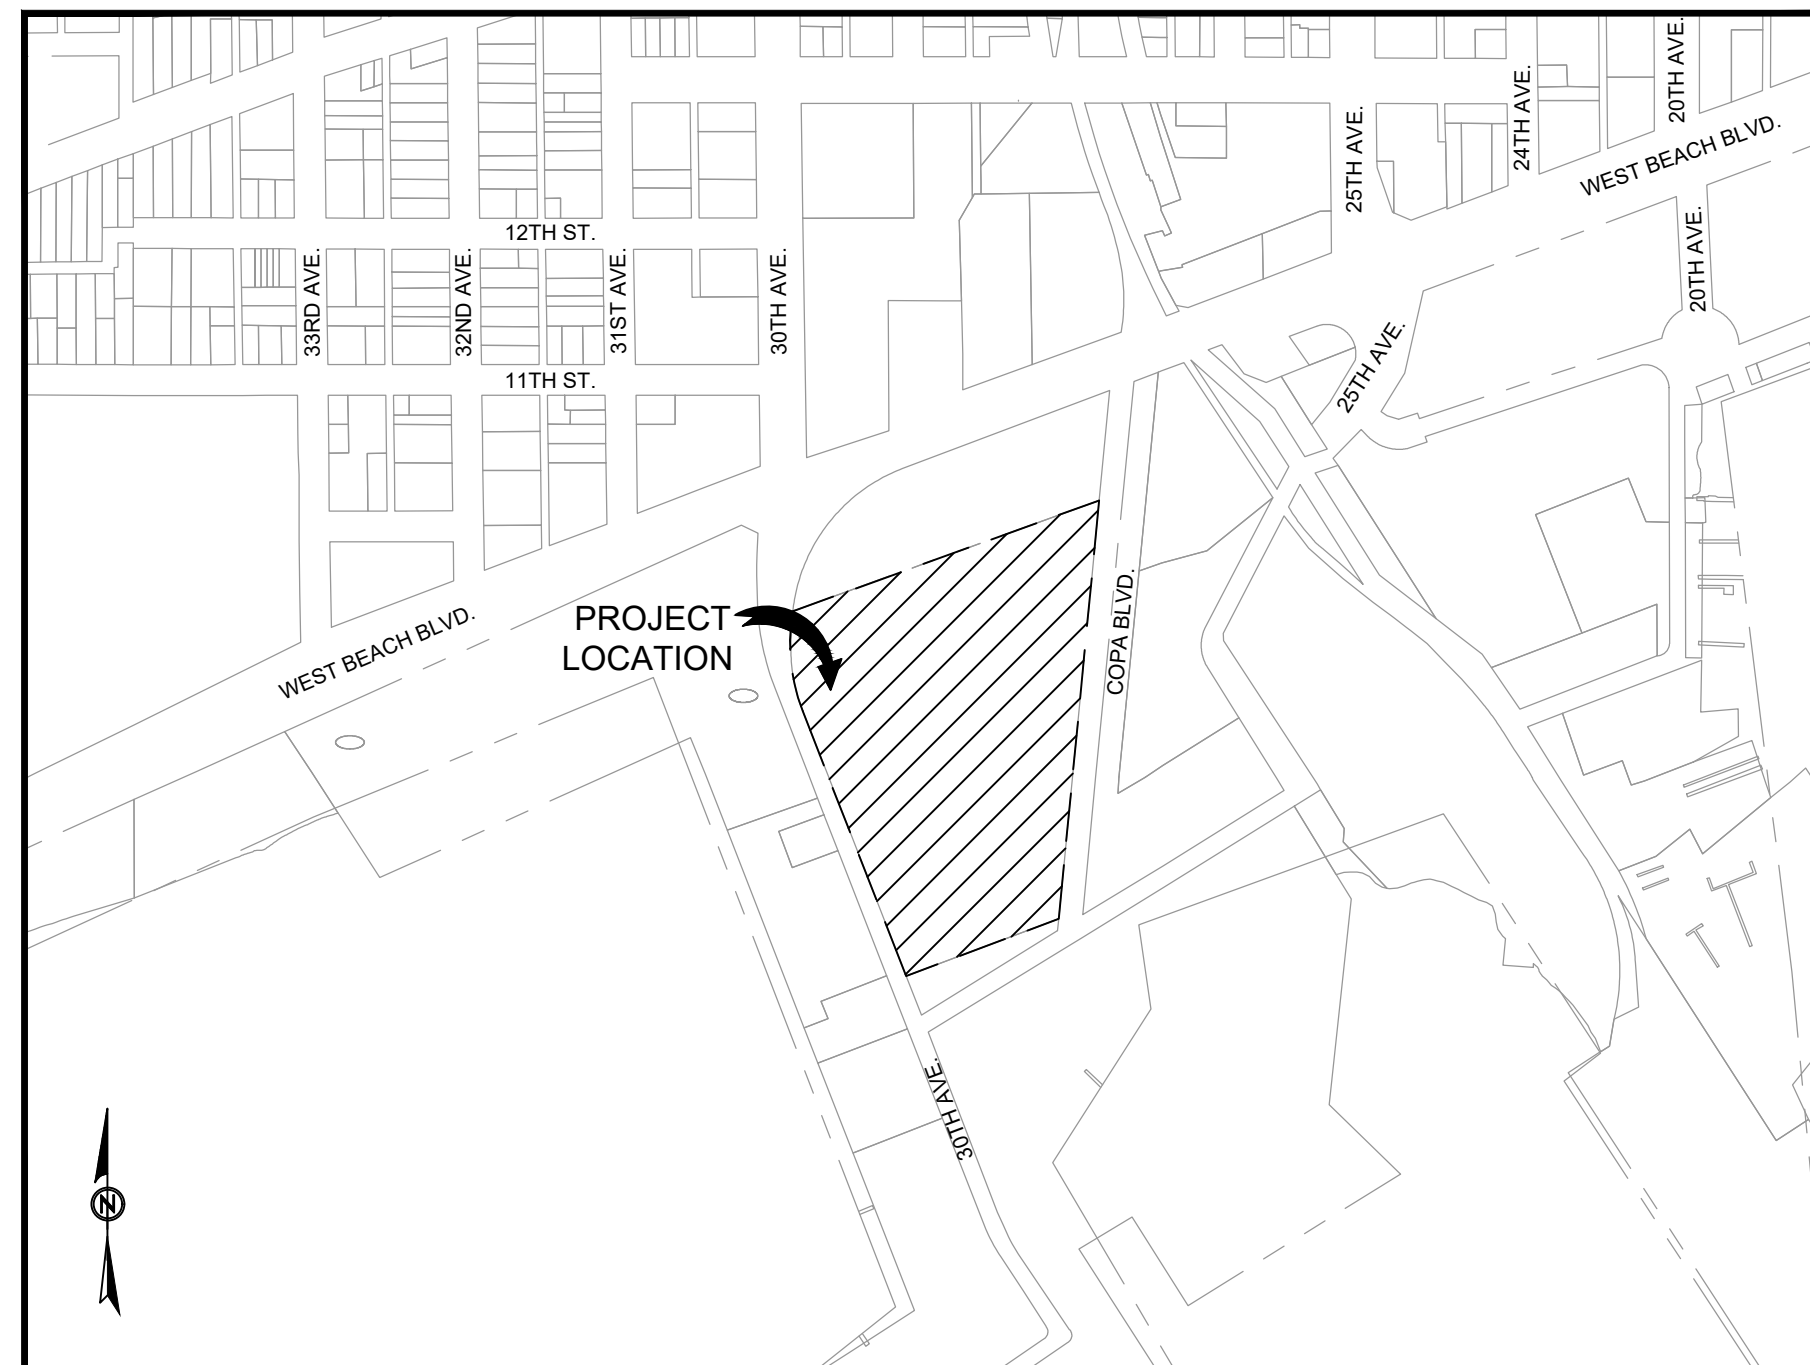
T001

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PORT OF GULFPORT

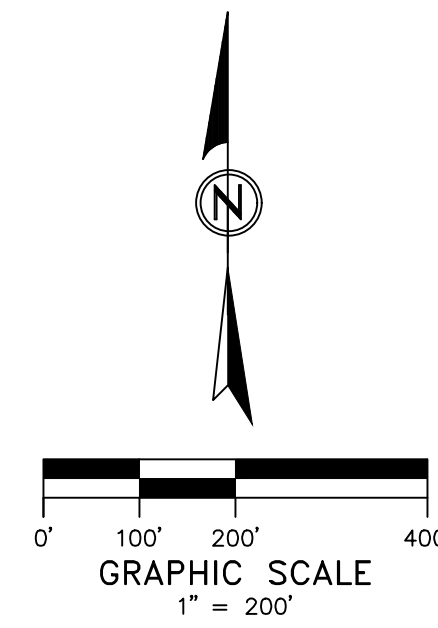
**SHEET NO.
DESCRIPTION**

T001	TITLE SHEET
C200	OVERALL SITE PLAN
C201	NORTH HARBOR SITE PLAN
C202	TERMINAL #1 SITE PLAN
C620	CIVIL SITE DETAILS
E001	ELECTRICAL SYMBOL SCHEDULES & GENERAL NOTES
E002	ELECTRICAL ABBREVIATIONS & SCHEDULES
E011	ELECTRICAL DEMOLITION PLAN
E012	ELECTRICAL DEMOLITION PLAN
E101	ELECTRICAL OVERALL PLAN
E102	ELECTRICAL OVERALL PLAN
E111	ENLARGED ELECTRICAL POWER PLAN
E112	ENLARGED ELECTRICAL POWER PLAN
E113	ENLARGED ELECTRICAL POWER PLAN
E114	ENLARGED ELECTRICAL POWER PLAN
E115	ENLARGED ELECTRICAL POWER PLAN
E116	ENLARGED ELECTRICAL POWER PLAN
E117	ENLARGED ELECTRICAL POWER PLAN
E118	ENLARGED ELECTRICAL POWER PLAN
E501	ELECTRICAL GENERAL DETAILS
E601	ELECTRICAL ONE-LINE DIAGRAM
E602	ELECTRICAL ONE-LINE DIAGRAM
E603	ELECTRICAL ONE-LINE DIAGRAM
E604	ELECTRICAL ONE-LINE DIAGRAM
E605	ELECTRICAL ONE-LINE DIAGRAM

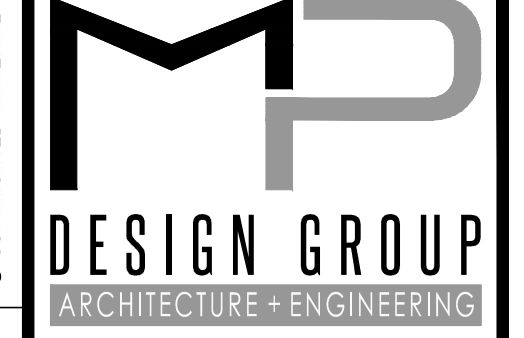


LOCATION MAP

PRINTED: 4/13/2023 1:44 PM BY: Nick Moody LAST SAVED: 4/13/2023 1:08 PM BY: Nimood
 m:\0297_mspa_gulfport\0297.22.003_work order no 2 - reefer plug replacement & mitigation\02-civil\03-production drawings\reefer plugs site.dwg



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 GULFPORT, MS 39501

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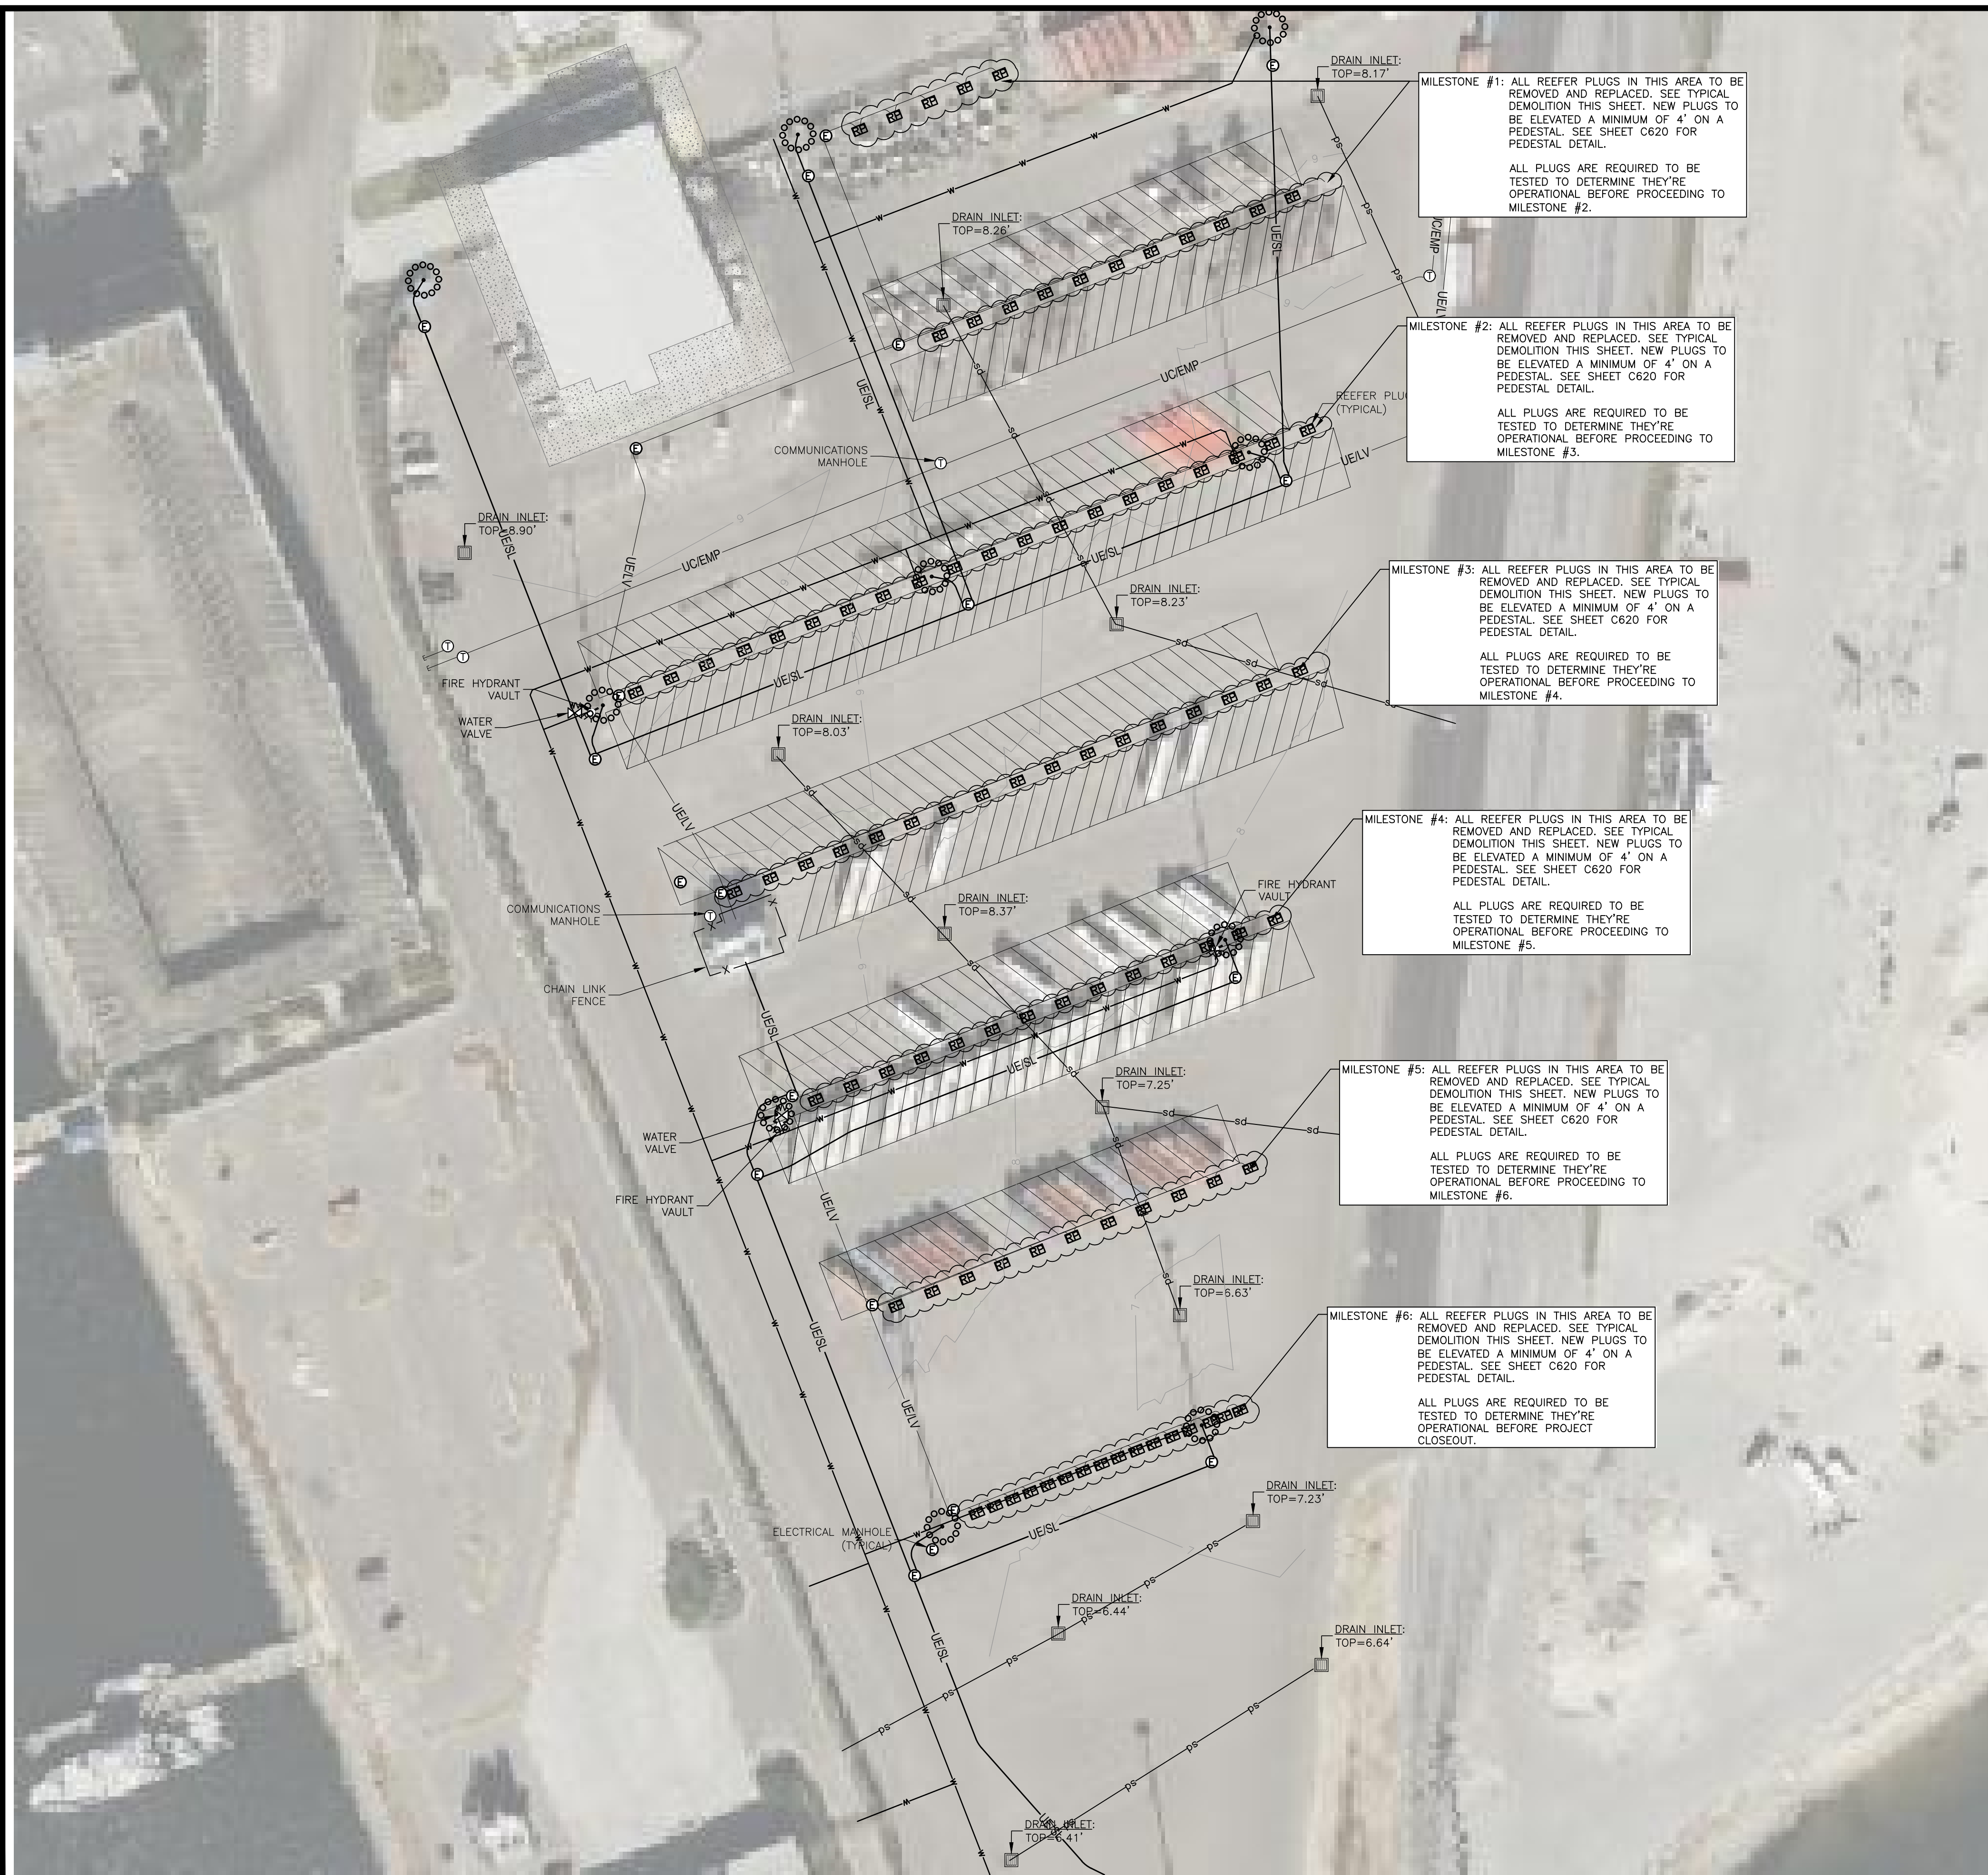
OVERALL SITE PLAN

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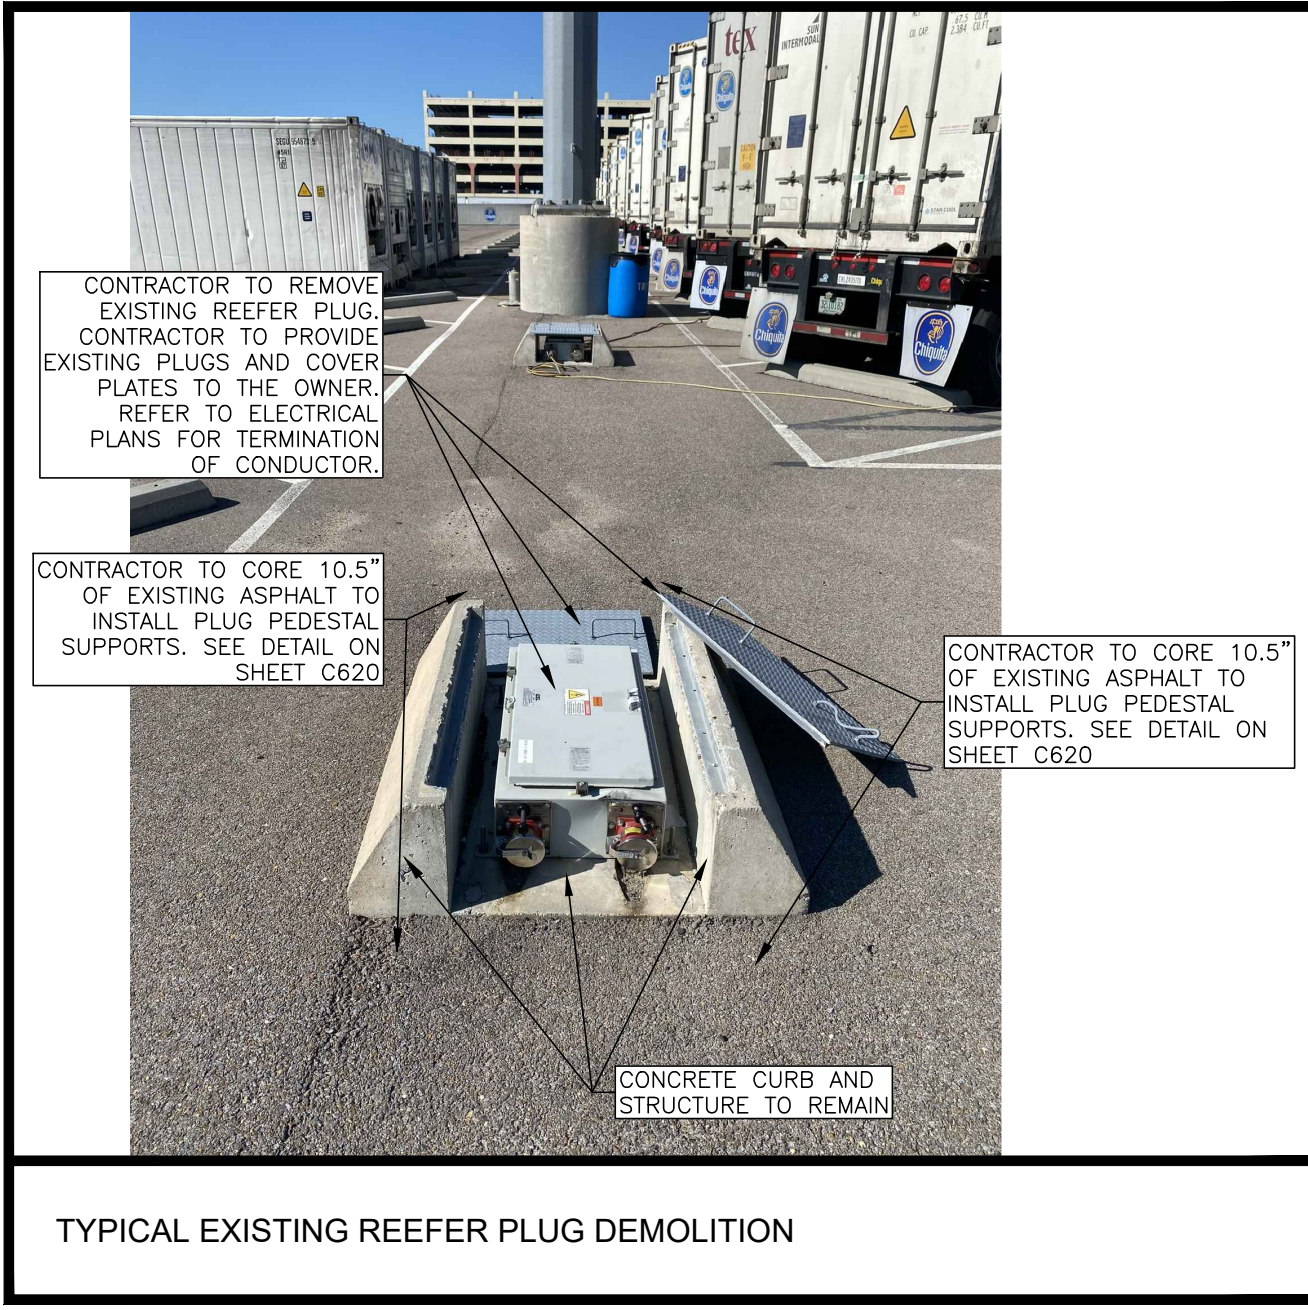
C200

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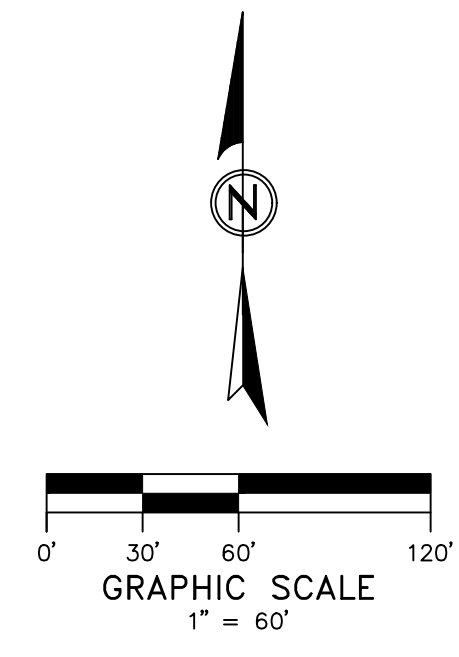
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SURVEY LEGEND	
	DENOTES WATER VALVE
	DENOTES ELECTRICAL MANHOLE
	DENOTES FIRE HYDRANT
	DENOTES DRAIN INLET
	DENOTES COMMUNICATIONS MANHOLE
	DENOTES REEFER PLUG



TYPICAL EXISTING REEFER PLUG DEMOLITION



MILESTONE #1: ALL REEFER PLUGS IN THIS AREA TO BE REMOVED AND REPLACED. SEE TYPICAL DEMOLITION THIS SHEET. NEW PLUGS TO BE ELEVATED A MINIMUM OF 4' ON A PEDESTAL. SEE SHEET C620 FOR PEDESTAL DETAIL.

ALL PLUGS ARE REQUIRED TO BE TESTED TO DETERMINE THEY'RE OPERATIONAL BEFORE PROCEEDING TO MILESTONE #2.

MILESTONE #2: ALL REEFER PLUGS IN THIS AREA TO BE REMOVED AND REPLACED. SEE TYPICAL DEMOLITION THIS SHEET. NEW PLUGS TO BE ELEVATED A MINIMUM OF 4' ON A PEDESTAL. SEE SHEET C620 FOR PEDESTAL DETAIL.

ALL PLUGS ARE REQUIRED TO BE TESTED TO DETERMINE THEY'RE OPERATIONAL BEFORE PROCEEDING TO MILESTONE #3.

MILESTONE #3: ALL REEFER PLUGS IN THIS AREA TO BE REMOVED AND REPLACED. SEE TYPICAL DEMOLITION THIS SHEET. NEW PLUGS TO BE ELEVATED A MINIMUM OF 4' ON A PEDESTAL. SEE SHEET C620 FOR PEDESTAL DETAIL.

ALL PLUGS ARE REQUIRED TO BE TESTED TO DETERMINE THEY'RE OPERATIONAL BEFORE PROCEEDING TO MILESTONE #4.

MILESTONE #4: ALL REEFER PLUGS IN THIS AREA TO BE REMOVED AND REPLACED. SEE TYPICAL DEMOLITION THIS SHEET. NEW PLUGS TO BE ELEVATED A MINIMUM OF 4' ON A PEDESTAL. SEE SHEET C620 FOR PEDESTAL DETAIL.

ALL PLUGS ARE REQUIRED TO BE TESTED TO DETERMINE THEY'RE OPERATIONAL BEFORE PROCEEDING TO MILESTONE #5.

MILESTONE #5: ALL REEFER PLUGS IN THIS AREA TO BE REMOVED AND REPLACED. SEE TYPICAL DEMOLITION THIS SHEET. NEW PLUGS TO BE ELEVATED A MINIMUM OF 4' ON A PEDESTAL. SEE SHEET C620 FOR PEDESTAL DETAIL.

ALL PLUGS ARE REQUIRED TO BE TESTED TO DETERMINE THEY'RE OPERATIONAL BEFORE PROCEEDING TO MILESTONE #6.

MILESTONE #6: ALL REEFER PLUGS IN THIS AREA TO BE REMOVED AND REPLACED. SEE TYPICAL DEMOLITION THIS SHEET. NEW PLUGS TO BE ELEVATED A MINIMUM OF 4' ON A PEDESTAL. SEE SHEET C620 FOR PEDESTAL DETAIL.

ALL PLUGS ARE REQUIRED TO BE TESTED TO DETERMINE THEY'RE OPERATIONAL BEFORE PROJECT CLOSEOUT.



ELEVATED REEFER PLUGS
PORT OF GULFPORT MISSISSIPPI
STATE PORT AUTHORITY
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 GULFPORT, MS 39501

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CHECKED BY:	NWM

NORTH HARBOR SITE PLAN

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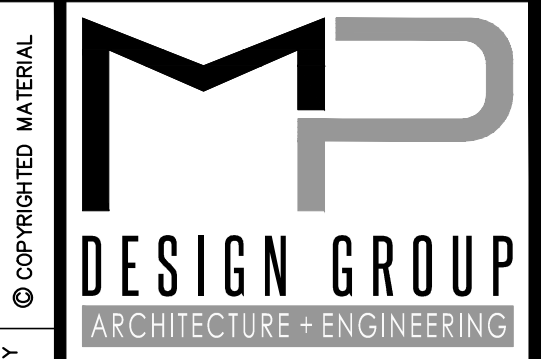
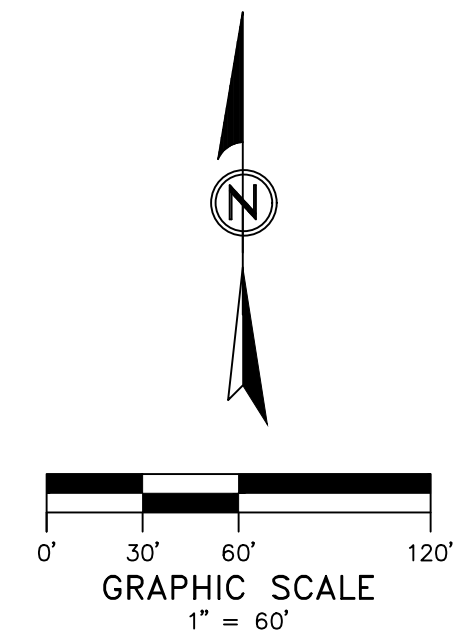
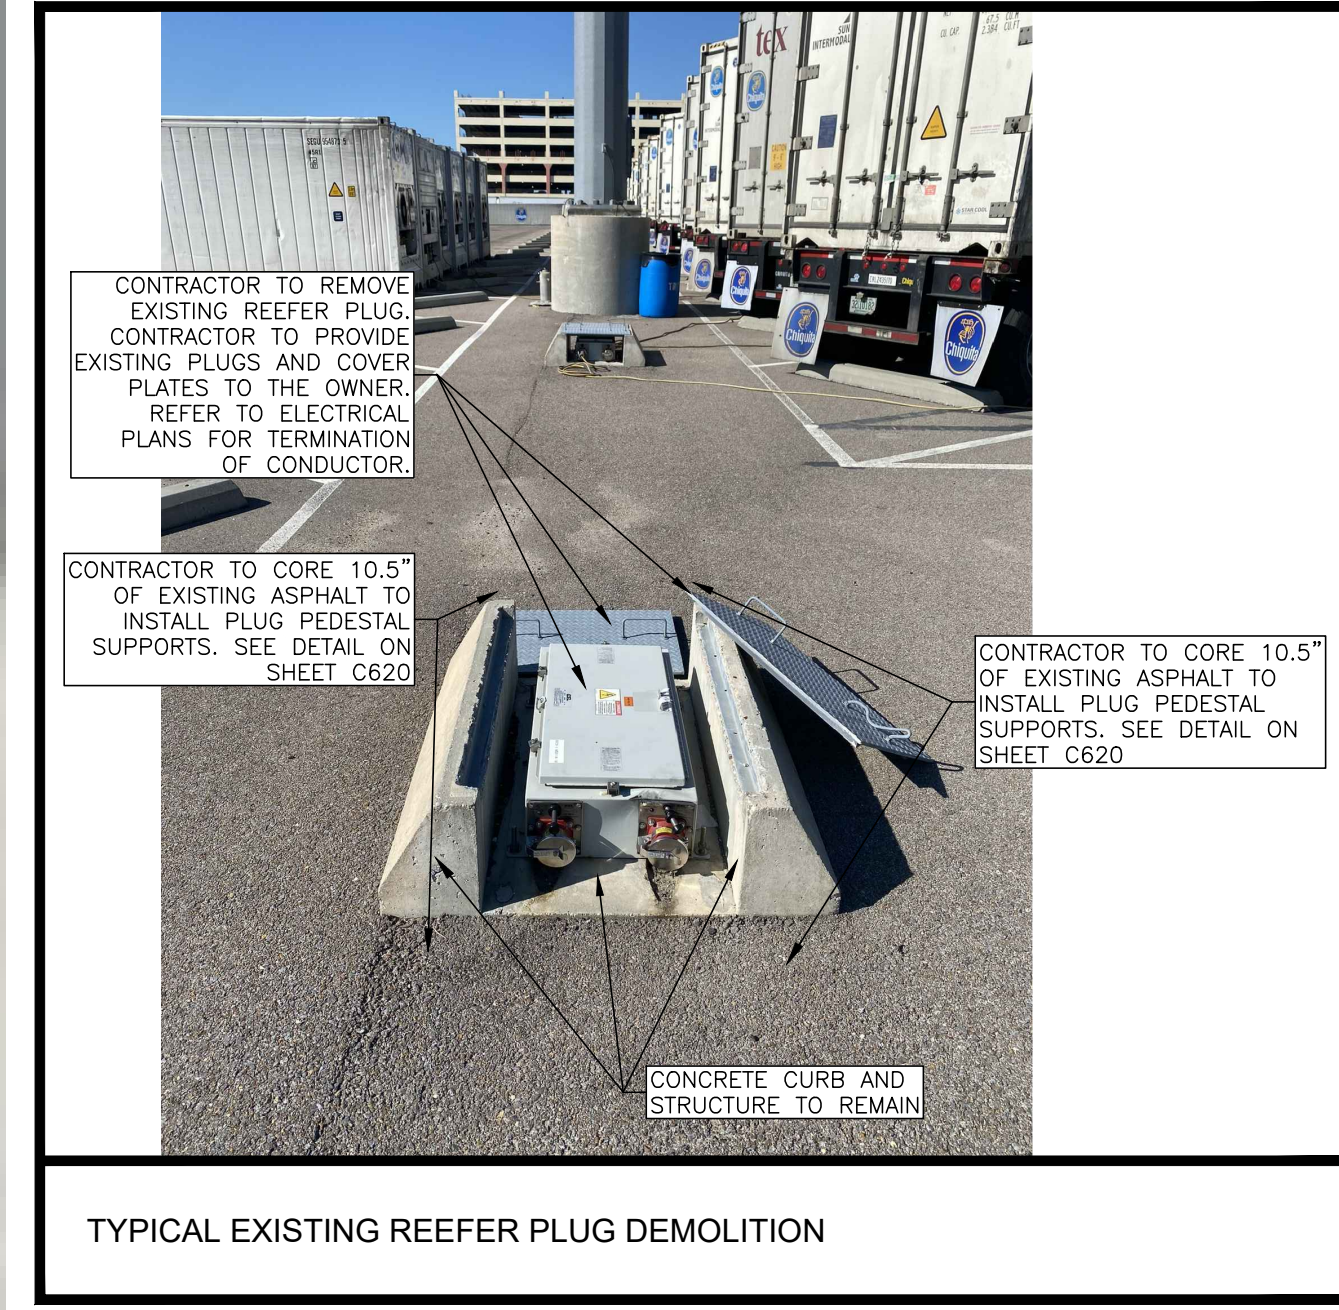
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SURVEY LEGEND	
	DENOTES WATER VALVE
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TERMINAL #1 SITE PLAN

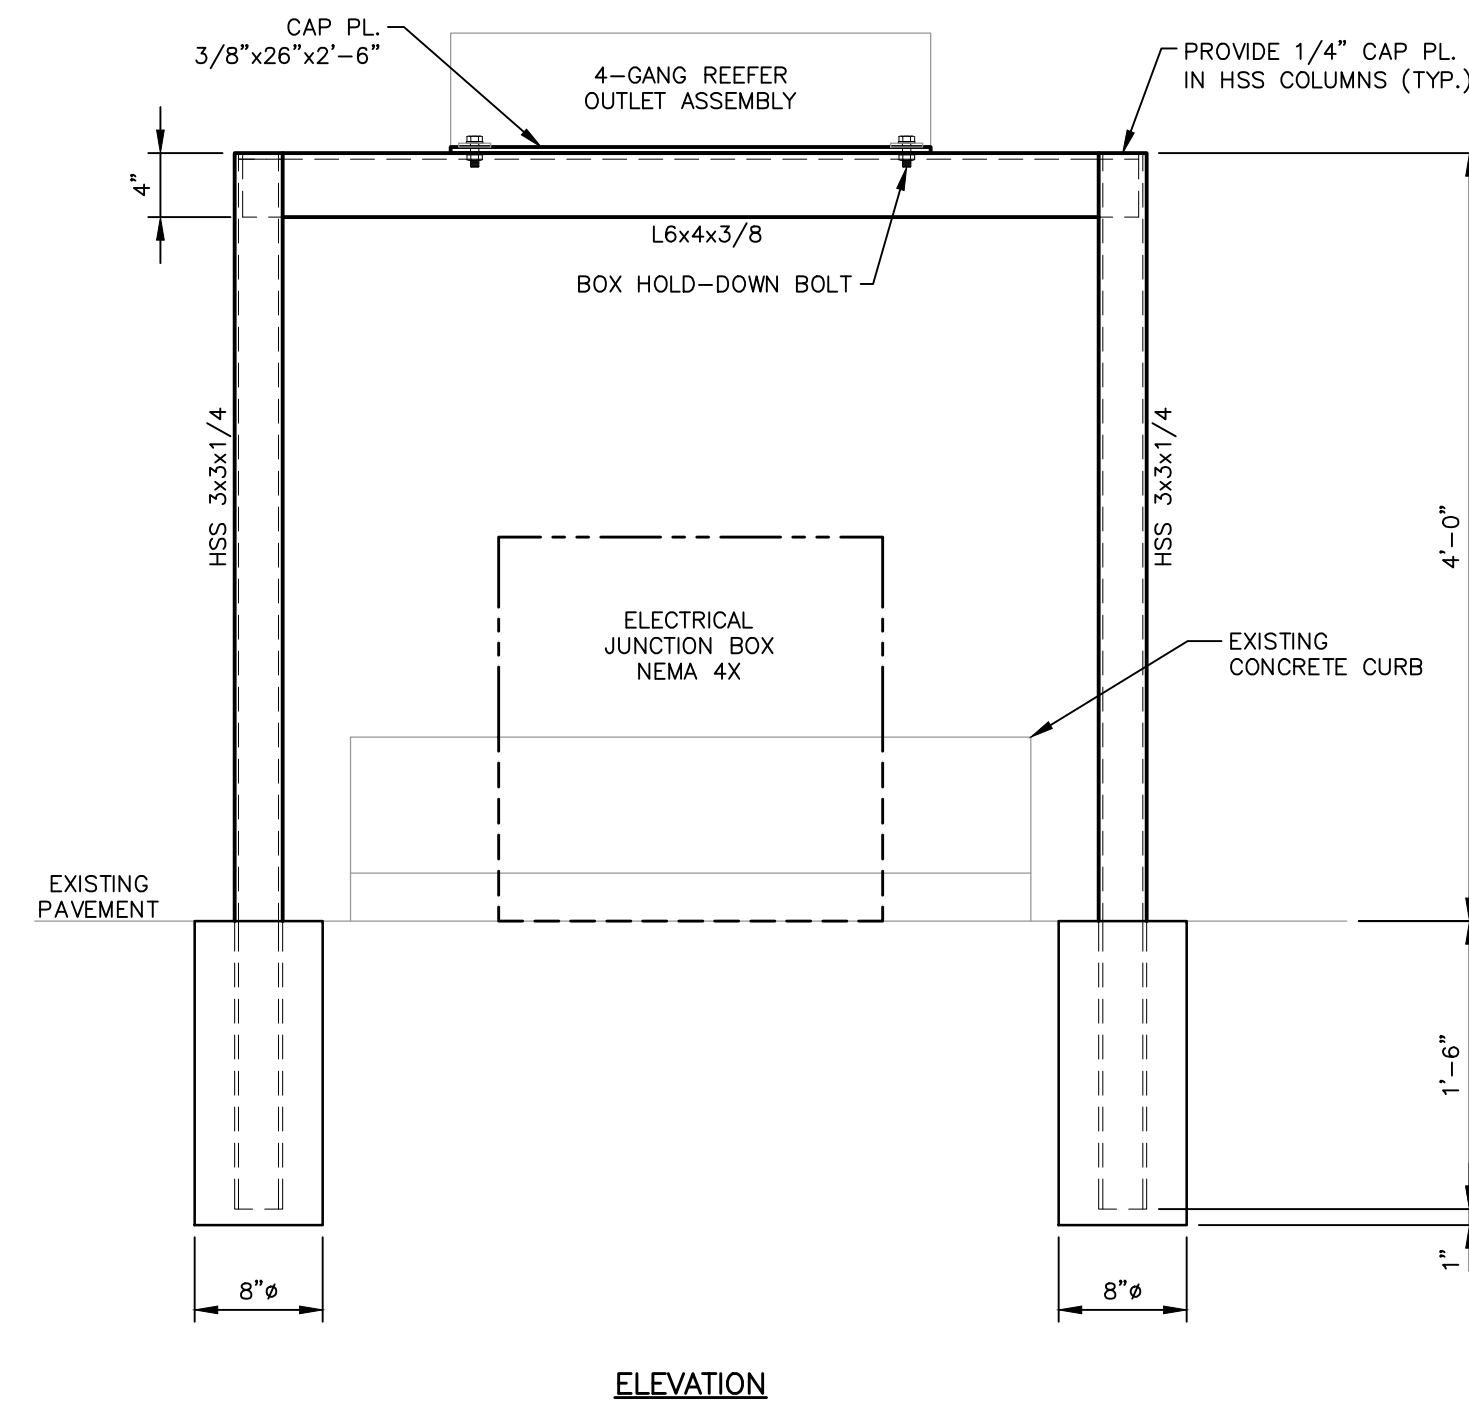
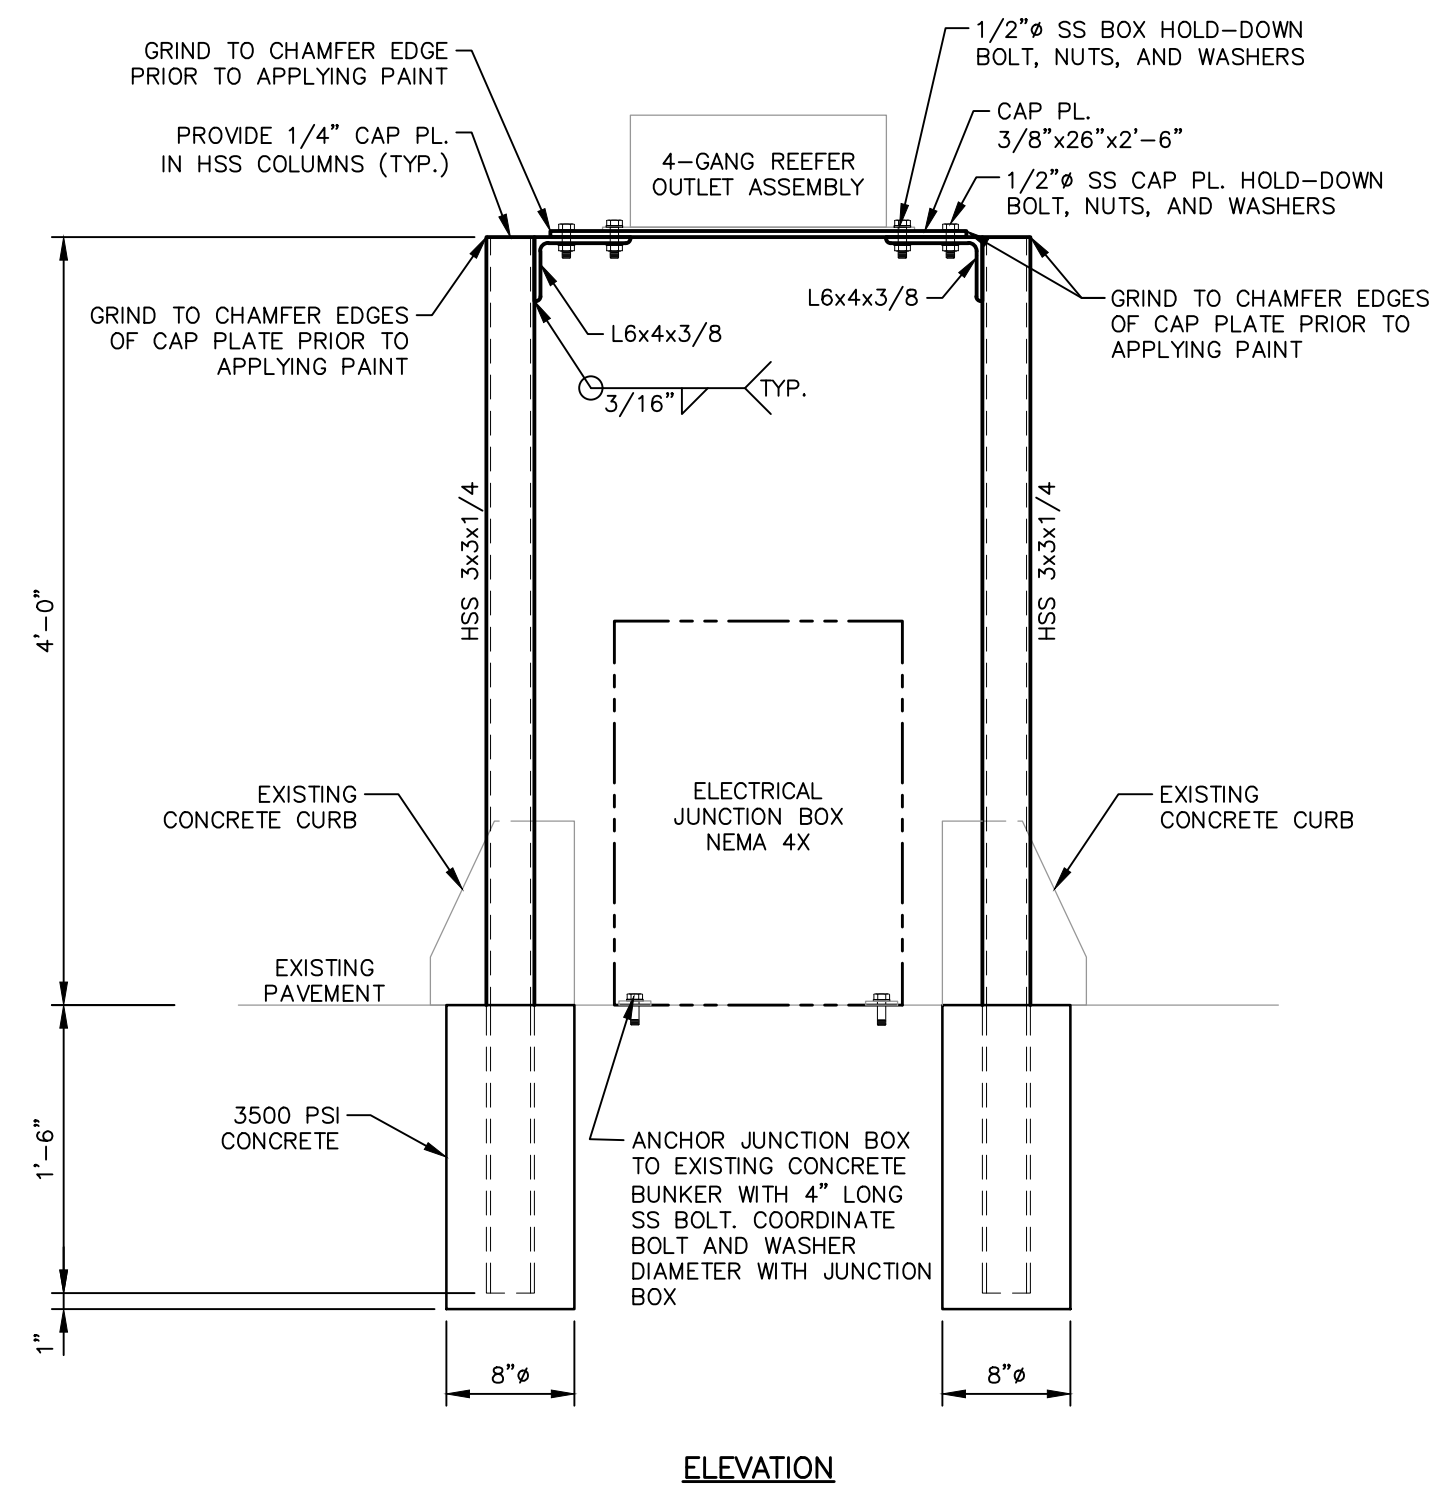
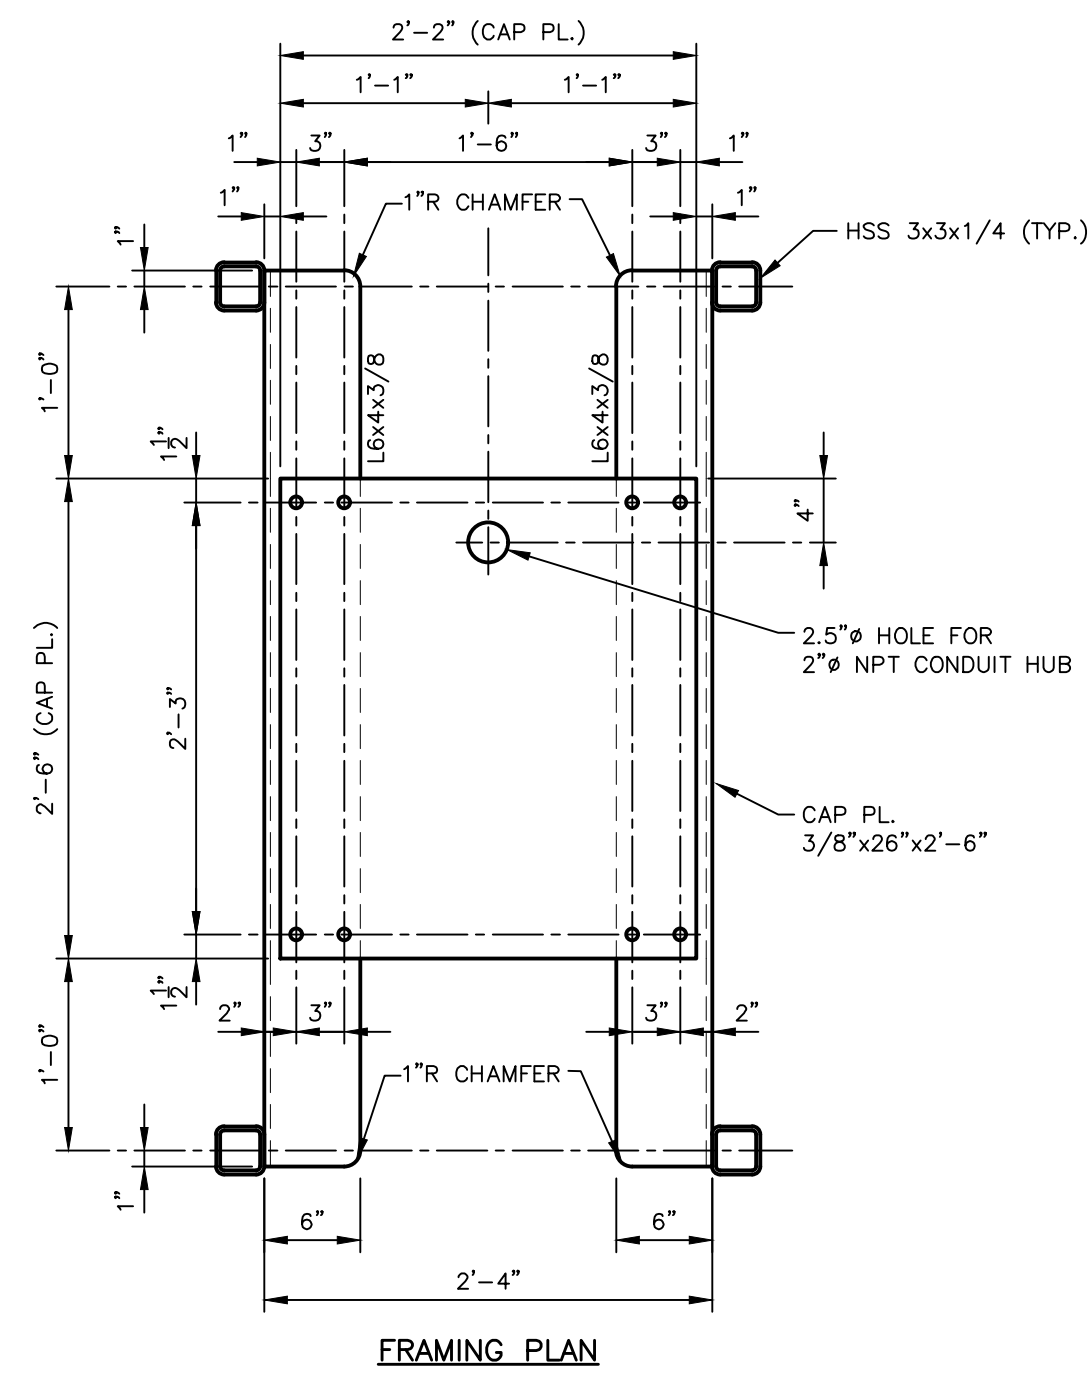
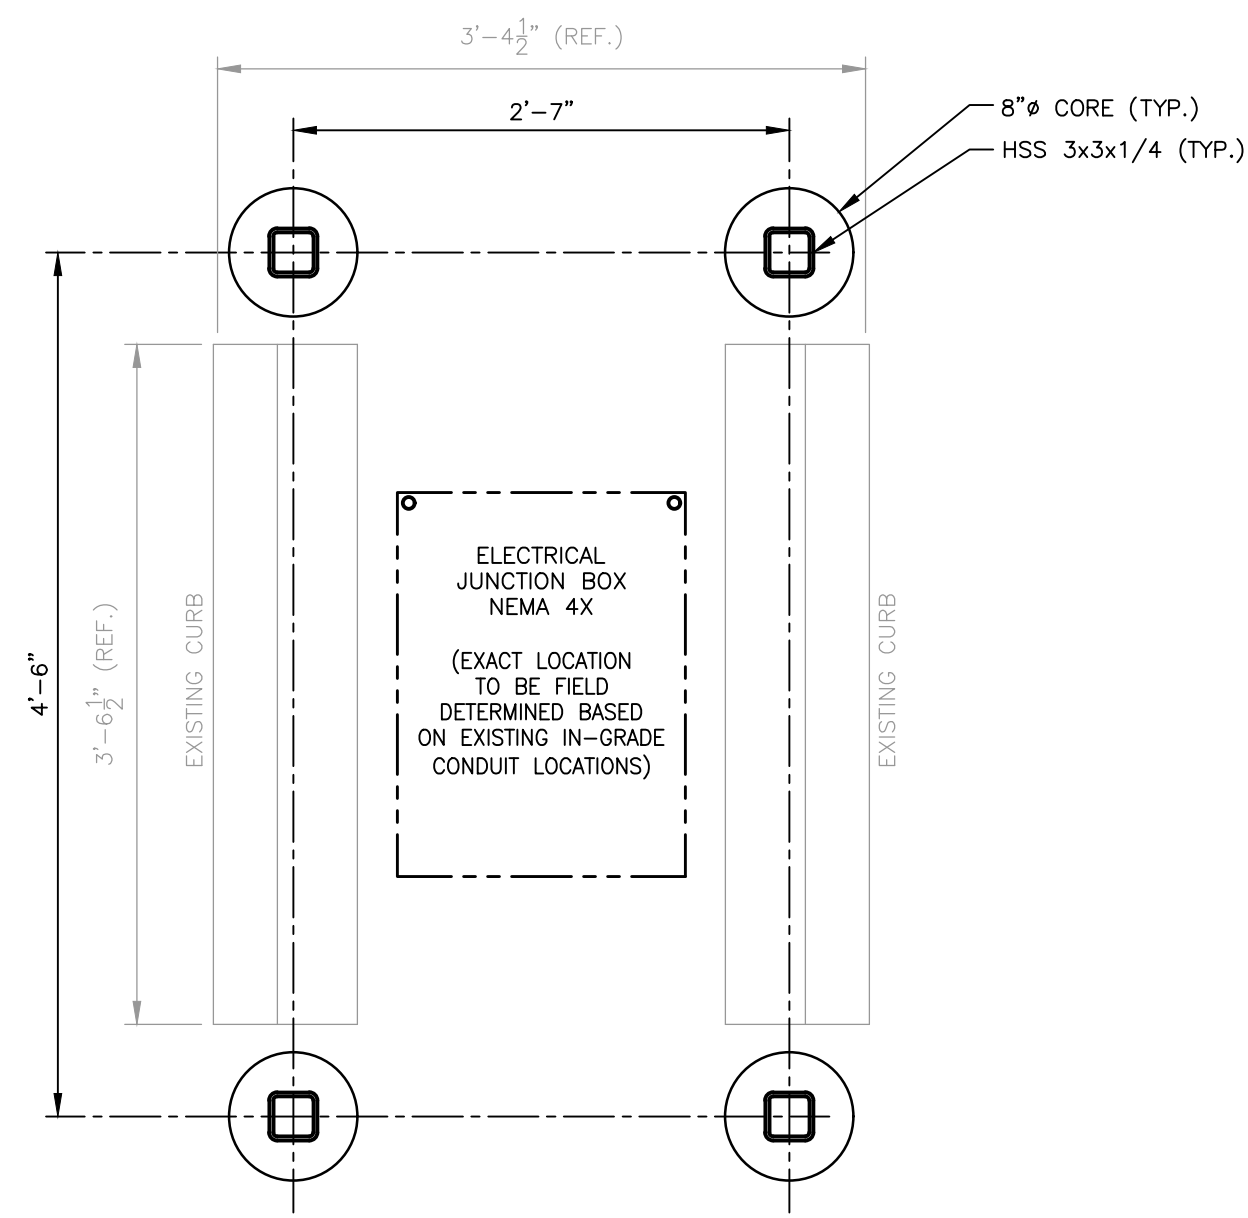
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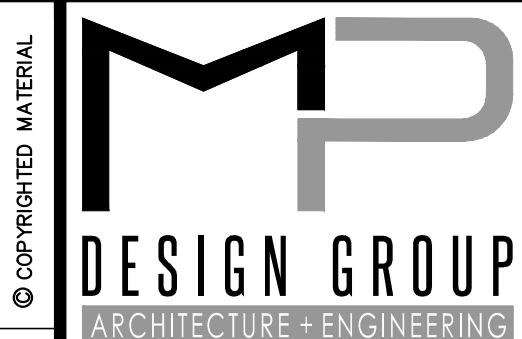
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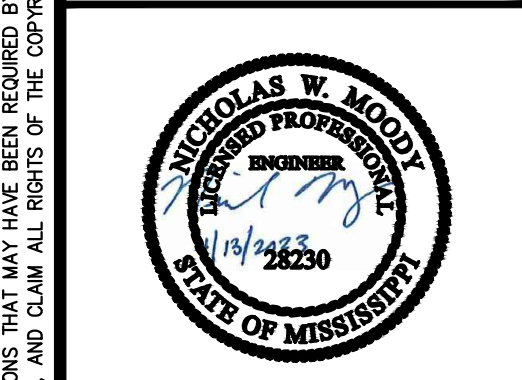


1 REEFER PLUG PEDESTAL DETAIL

SCALE: 1" = 1'-0"



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 30TH AVENUE
 GULFPORT, MS 39501

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CIVIL SITE DETAILS

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LIGHTING SYMBOLS		
CEILING	WALL	DESCRIPTION
		FLUORESCENT, LED OR H.I.D. LIGHT FIXTURE. LETTER DENOTES FIXTURE TYPE. SEE LUMINARE SCHEDULE.
		FLUORESCENT OR LED STRIP LIGHT FIXTURE. LETTER DENOTES FIXTURE TYPE. SEE LUMINARE SCHEDULE.
		FLUORESCENT OR LED LIGHT FIXTURE. LETTER DENOTES FIXTURE TYPE. SEE LUMINARE SCHEDULE.
		"EXIT" LIGHT FIXTURE. DIRECTIONAL ARROWS AS INDICATED. SHADED QUADRANT INDICATE FACE(S). SEE LUMINARE SCHEDULE.
		EMERGENCY BATTERY PACK FIXTURE. LETTER DENOTES FIXTURE TYPE. SEE LUMINARE SCHEDULE.
		H.I.D. OR LED FLOODLIGHT FIXTURE. LETTER DENOTES FIXTURE TYPE. SEE LUMINARE SCHEDULE.

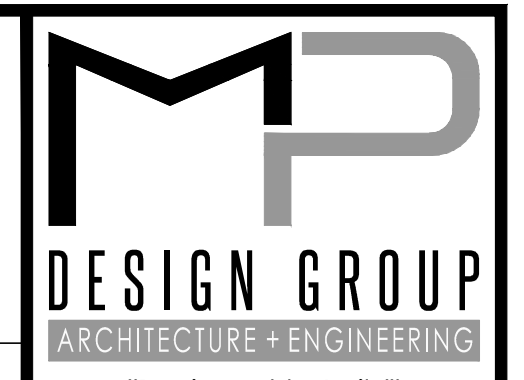
POWER SYMBOLS						DESCRIPTION
FLOOR	WALL	CEIL.	COUNTR	QUAD.		
						DUPLEX 20A OUTLET; GFCI=GFCI PROTECTION, WP=WEATHER PROOF COVER, IG=ISOLATED GROUND.
						SPECIAL OUTLET
						480/277V PANELBOARD
						208/120V PANELBOARD
						DISCONNECT SWITCH, AS=FRAME SIZE, AT=FUSE SETTING (NF=NON FUSED), #P=NUMBER POLES, NR=NEMA ENCLOSURE RATING (NEMA 3R UNLESS OTHERWISE NOTED)
						COMBINATION STARTER/CIRCUIT BREAKER, MP=MAX PROTECTION RATING, SS=STARTER SIZE, #P=NUMBER POLES, NR=NEMA ENCLOSURE RATING (NEMA 3R UNLESS OTHERWISE NOTED).
						MAGNETIC MOTOR STARTER. SS=STARTER SIZE, NR=NEMA ENCLOSURE RATING (NEMA 3R UNLESS OTHERWISE NOTED)
						MOTOR, SINGLE-PHASE. HP=DENOTES HORSEPOWER
						MOTOR, THREE-PHASE. HP=DENOTES HORSEPOWER
						JUNCTION BOX, HOFFMAN A8086CHNF
						ELECTRICAL CONNECTION
						TRANSFORMER

WIRING SYMBOLS	
	DESCRIPTION
	WIRING (IN CONDUIT) CONCEALED IN CEILING OR WALL
	WIRING (IN CONDUIT) RUN EXPOSED
	WIRING UNDERGROUND (SITE WORK)
	TELECOMMUNICATION RACEWAY (SITE WORK)
	HOMERUN TO PANELBOARD WITH NOMENCLATURE (LETTERS), CIRCUIT NUMBERS (NUMBERS), NUMBER OF CIRCUITS (NUMBER OF ARROWS), EACH CIRCUIT TO HAVE GROUND.
	ELECTRICAL MANHOLE
	TELECOMMUNICATION MANHOLE
	GROUND CONNECTION
	SINGLE-POLE TOGGLE SWITCH.
	DOUBLE-POLE TOGGLE SWITCH.
	THREE-WAY TOGGLE SWITCH.
	SLIDE DIMMER FLUORESCENT.
	SWITCH, MOTOR RATED
	SWITCH, MOTION SENSOR
	PHOTO CELL
	CONDUIT TURNED UP
	POWER POLE
	GROUNDING CONNECTION BAR
	10' X 3/4" STAINLESS STEEL GROUND ROD.

REFERENCE SYMBOLS	
	DESCRIPTION
	SPECIFIC NOTE REFERENCE.
	FEEDER REFERENCE.
	DETAIL/SECTION REFERENCE: "1" DENOTES DETAIL "A" DENOTES SECTION "E2" DENOTES DRAWING NUMBER WHERE DETAIL/SECTION IS DRAWN

ONE-LINE SYMBOLS	
	DESCRIPTION
	METER ENCLOSURE
	METER
	CIRCUIT BREAKER
	SWITCH, SINGLE POLE-SINGLE THROW
	FUSE
	FUSED SWITCH
	FUSED SWITCH
	DRY TYPE TRANSFORMER
	PANELBOARD
	CURRENT TRANSFORMER
	POTENTIAL TRANSFORMER
	LIGHTING CONTACTOR
	GROUND FAULT MONITORING
	KIRK-KEY MECHANICAL INTER-LOCK
	GROUND SYSTEM TEST WELL WITH GROUND ROD CONNECTION
	EXOTHERMIC WELD GROUND ROD CONNECTION
	EXOTHERMIC WELD CONNECTION
	4-WAY SF ₆ SWITCH
	6-WAY SF ₆ SWITCH
	TYPICAL DUAL CIRCUIT AIR BREAK TRANSFORMER DESIGN
	TRANSFORMER STATION NUMBER BUILDING NUMBER OR LOCATION
	LOAD BREAK SWITCH
	MOTOR STARTER (NUMBER INDICATES NEMA SIZE)
	UNDERVOLTAGE RELAY
	VOLT METER
	AMMETER
	TRANSIENT VOLTAGE SURGE SUPPRESSION

GENERAL NOTES	
1.	EQUIPMENT SHALL BE MOUNTED ON MATERIALS SUITABLE FOR THE ENVIRONMENT WHICH IT IS INSTALLED WITH THE APPROPRIATE NEMA ENCLOSURE RATING.
2.	WORKING CLEARANCES FOR ELECTRICAL EQUIPMENT SHALL BE IN COMPLIANCE WITH ARTICLE 110 AND 408.
3.	THE DEDICATED ELECTRICAL SPACE EXTENDED FROM THE FLOOR TO THE STRUCTURAL CEILING WITH THE WIDTH AND DEPTH OF THE PANEL-BOARD OR SWITCHBOARD, MUST BE CLEAR OF ALL PIPING, DUCTS, EQUIPMENT FOREIGN TO THE ELECTRICAL OR ARCHITECTURAL APURTENANCES IN ACCORDANCE WITH THE NEC 110 & 408. COORDINATE INSTALLATION OF ELECTRICAL EQUIPMENT WITH OTHER TRADES PRIOR TO ROUGHING IN EQUIPMENT.
4.	ALL ELECTRICAL EQUIPMENT AND THE RESULTANT INSTALLATION OF SUCH EQUIPMENT, DEVICES, ETC., SHALL BE IN STRICT COMPLIANCE WITH THE NATIONAL ELECTRIC CODE, NFPA 70, ALL APPLICABLE LOCAL, STATE AND FEDERAL CODES AND THE STANDARD FOR ELECTRICAL SAFETY IN THE WORKPLACE NFPA 70E.
5.	DRAWINGS AND SPECIFICATIONS FORM A COMPLETE SET OF DOCUMENTS FOR THE WORK IN THIS PROJECT. NEITHER IS COMPLETE WITHOUT THE OTHER. ANY ITEM MENTIONED IN ONE SHALL BE BINDING AS MENTIONED IN BOTH.
6.	CONTRACTOR SHALL TAKE RESPONSIBILITY FOR FIELD VERIFICATION OF ALL DIMENSIONS AND LOCATIONS OF EXISTING, RELOCATED AND NEW EQUIPMENT AND SHALL BE RESPONSIBLE FOR COORDINATION WITH THE WORK OF OTHER TRADES NECESSARY TO THE PROJECT.
7.	THESE DRAWINGS ARE INTENDED TO OUTLINE THE SCOPE OF WORK REQUIRED TO PROVIDE A COMPLETE AND OPERABLE PROJECT CONCLUSION. ALL MISCELLANEOUS COMPONENTS, PARTS, FASTENERS, SPLICES AND OTHER INCIDENTAL ITEMS NECESSARY TO PROVIDE A COMPLETED PROJECT SHALL BE PROVIDED WHETHER OR NOT SPECIFICALLY NOTED.
8.	CONTRACTOR SHALL NOTIFY THE ENGINEER IMMEDIATELY OF ANY CONFLICTS ARISING FROM DISCOVERED CONDITIONS AT ANY PHASE OF THE PROJECT.
9.	CONTRACTOR SHALL ELICIT HELP FROM, AND ASSIST, CONSTRUCTION MANAGER IN DETERMINING, AS CLOSELY AS POSSIBLE, LOCATION AND DEPTH OF UNDERGROUND ELECTRIC UTILITIES PRIOR TO EXCAVATION.
10.	PORT OF GULFPORT FACILITIES MAINTENANCE DEPARTMENT SHALL SUPPLY ALL AVAILABLE UNDERGROUND UTILITY PLAN LOCATION INFORMATION TO THE GENERAL CONTRACTOR AT THE START OF THE PROJECT. GENERAL CONTRACTOR SHALL BE RESPONSIBLE FOR HAND DIGGING, PROBING AND VISUALLY LOCATING AND MARKING ALL UNDERGROUND UTILITIES. GENERAL CONTRACTOR SHALL EXERCISE EXTREME DUE DILIGENCE AND CAUTION DURING ALL EXCAVATION TO AVOID ANY DAMAGE TO UNDERGROUND UTILITIES. GENERAL CONTRACTOR SHALL BE RESPONSIBLE FOR REPAIRING ANY SUCH DAMAGE IN A TIMELY MANNER. GENERAL CONTRACTOR SHALL BE AWARE THAT THERE MAY EXIST UNKNOWN UNDERGROUND UTILITIES ON THE SITE. IN AREAS WHERE EXISTING UTILITIES ARE KNOWN TO BE LOCATED, ALL TRENCHING FOR UTILITY SUPPLY SERVICES SHALL BE HAND DUG A MINIMUM OF 2'-0" BELOW GRADE AND THEN THOROUGHLY PROBED WITH THIN RODS A MINIMUM OF AN ADDITIONAL 6'-0" AND/OR THE MAXIMUM PLANNED DEPTH OF THE TRENCH, PRIOR TO DIGGING TO FULL DEPTH. IN EITHER CASE, WHERE PROBING LOCATES UNKNOWN OBJECTS, FURTHER HAND DIGGING TO VISUALLY EXPOSE AND IDENTIFY THESE OBJECTS SHALL BE ACCOMPLISHED PRIOR TO ANY OTHER WORK IN THESE AREAS.
11.	AT ANY LOCATION WHERE EXCAVATION OR ASSOCIATED WORK CAUSES DAMAGE TO EXISTING UNDERGROUND UTILITIES, CONTRACTOR SHALL RESTORE THE DAMAGED SYSTEM TO LIKE-NEW STATE.
12.	ALL BRANCH CIRCUITS SHALL HAVE A SEPARATE NEUTRAL AND GROUND.
13.	ALL ABOVE GROUND EXPOSED CONDUIT SHALL BE RIGID GALVANIZED STEEL.
14.	LOCATIONS OF OTHER EQUIPMENT SPECIFIED BY OTHER TRADES OR PROVIDED BY OWNER ARE APPROXIMATE. COORDINATE EXACT LOCATION IN FIELD PRIOR TO ROUGHING IN AND ROUTING CONDUIT.
15.	CONDUITS ARE NOT NECESSARILY SHOWN ON PLAN DRAWINGS FOR SAKE OF CLARITY. PROVIDE CONDUITS BETWEEN DEVICES AND TO PANELS PER REQUIREMENTS LISTED IN DIVISION 26 SPECIFICATIONS. INDICATE EXACT ROUTING OF CONDUIT ON PLAN DRAWINGS AS PART OF AS BUILD DOCUMENTATION TO BE SUBMITTED AFTER FINAL COMPLETION.
16.	FINAL CONNECTION TO ALL MOTORS SHALL BE WITH SEALTITE FLEXIBLE CONDUIT CONNECTION.
17.	GENERAL CONTRACTOR SHALL FIELD-VERIFY ALL EXISTING CONDITIONS PRIOR TO BEGINNING ANY WORK AND SHALL IMMEDIATELY NOTIFY THE ARCHITECT/ENGINEER OF ANY DISCREPANCIES. FAILURE TO DO SO INDICATES THAT THE CONTRACTOR ACCEPTS THE CONDITIONS AS THEY EXIST, AND SHALL PERFORM THE WORK REQUIRED AS SHOWN AND SPECIFIED.
18.	ALL CONNECTIONS TO THE EXISTING POWER, AND ALL TESTING SHALL BE DONE WITH THE ASSISTANCE AND GUIDANCE OF THE CONSTRUCTION MANAGER AND PORT OF GULFPORT MAINTENANCE PERSONNEL.
19.	IT MAY BE NECESSARY FOR PORT OF GULFPORT MAINTENANCE PERSONNEL TO MODIFY ITEMS SUCH AS SUBSTATION CABINETS, BUSHINGS, ETC. WHILE SUCH EQUIPMENT ITEMS ARE OUT OF SERVICE. CONTRACTOR SHALL COORDINATE WITH THE CONSTRUCTION MANAGER AND SHALL PROVIDE SCHEDULE NOTIFICATIONS DENOTING WHEN VARIOUS PIECES OF EQUIPMENT SHALL BE AVAILABLE FOR MODIFICATION.
20.	CONTRACTOR SHALL NOTIFY THE CONSTRUCTION MANAGER AT LEAST 2 WEEKS IN ADVANCE OF ANY WORK WHICH SHALL OR REASONABLY COULD, RESULT IN OUTAGE OF POWER OR COMMUNICATIONS.
21.	CONTRACTOR SHALL TURN OVER ALL COPPER CABLE REMOVED DURING THE DEMOLITION PHASE TO PORT OF GULFPORT MAINTENANCE PERSONNEL.
22.	ALL DRAWINGS ARE DIAGRAMMATIC AND ARE INTENDED TO QUANTIFY THE MATERIALS SPECIFIED AND INDICATED THEIR INTENDED RELATIONSHIP TO EACH OTHER. THE DRAWINGS ARE NOT TO BE SCALED. THE VARIOUS SCALES USED ON THE DRAWINGS MAY NOT ALLOW FOR ALL FITTINGS, OFFSETS, AND ACCESSORIES THAT MAY BE REQUIRED TO COMPLETE THE WORK. THE CONTRACTOR SHALL CAREFULLY INVESTIGATE THE CONDITIONS THAT WOULD AFFECT THE WORK TO BE PERFORMED AND SHALL ARRANGE SUCH WORK AS NECESSARY TO COMPLY WITH THE INTENT OF THE CONSTRUCTION DOCUMENTS.



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ELEVATED REEFER PLUGS
 PORT OF GULFPORT MISSISSIPPI
 STATE PORT AUTHORITY
 30TH AVENUE
 GULFPORT, MS 39501

SCALE: NOT TO SCALE
 PROJECT NO: 0297.22.002
 DRAWN BY: KDB
 CHECKED BY: KDB

ELECTRICAL SYMBOL SCHEDULE &
 GENERAL NOTES

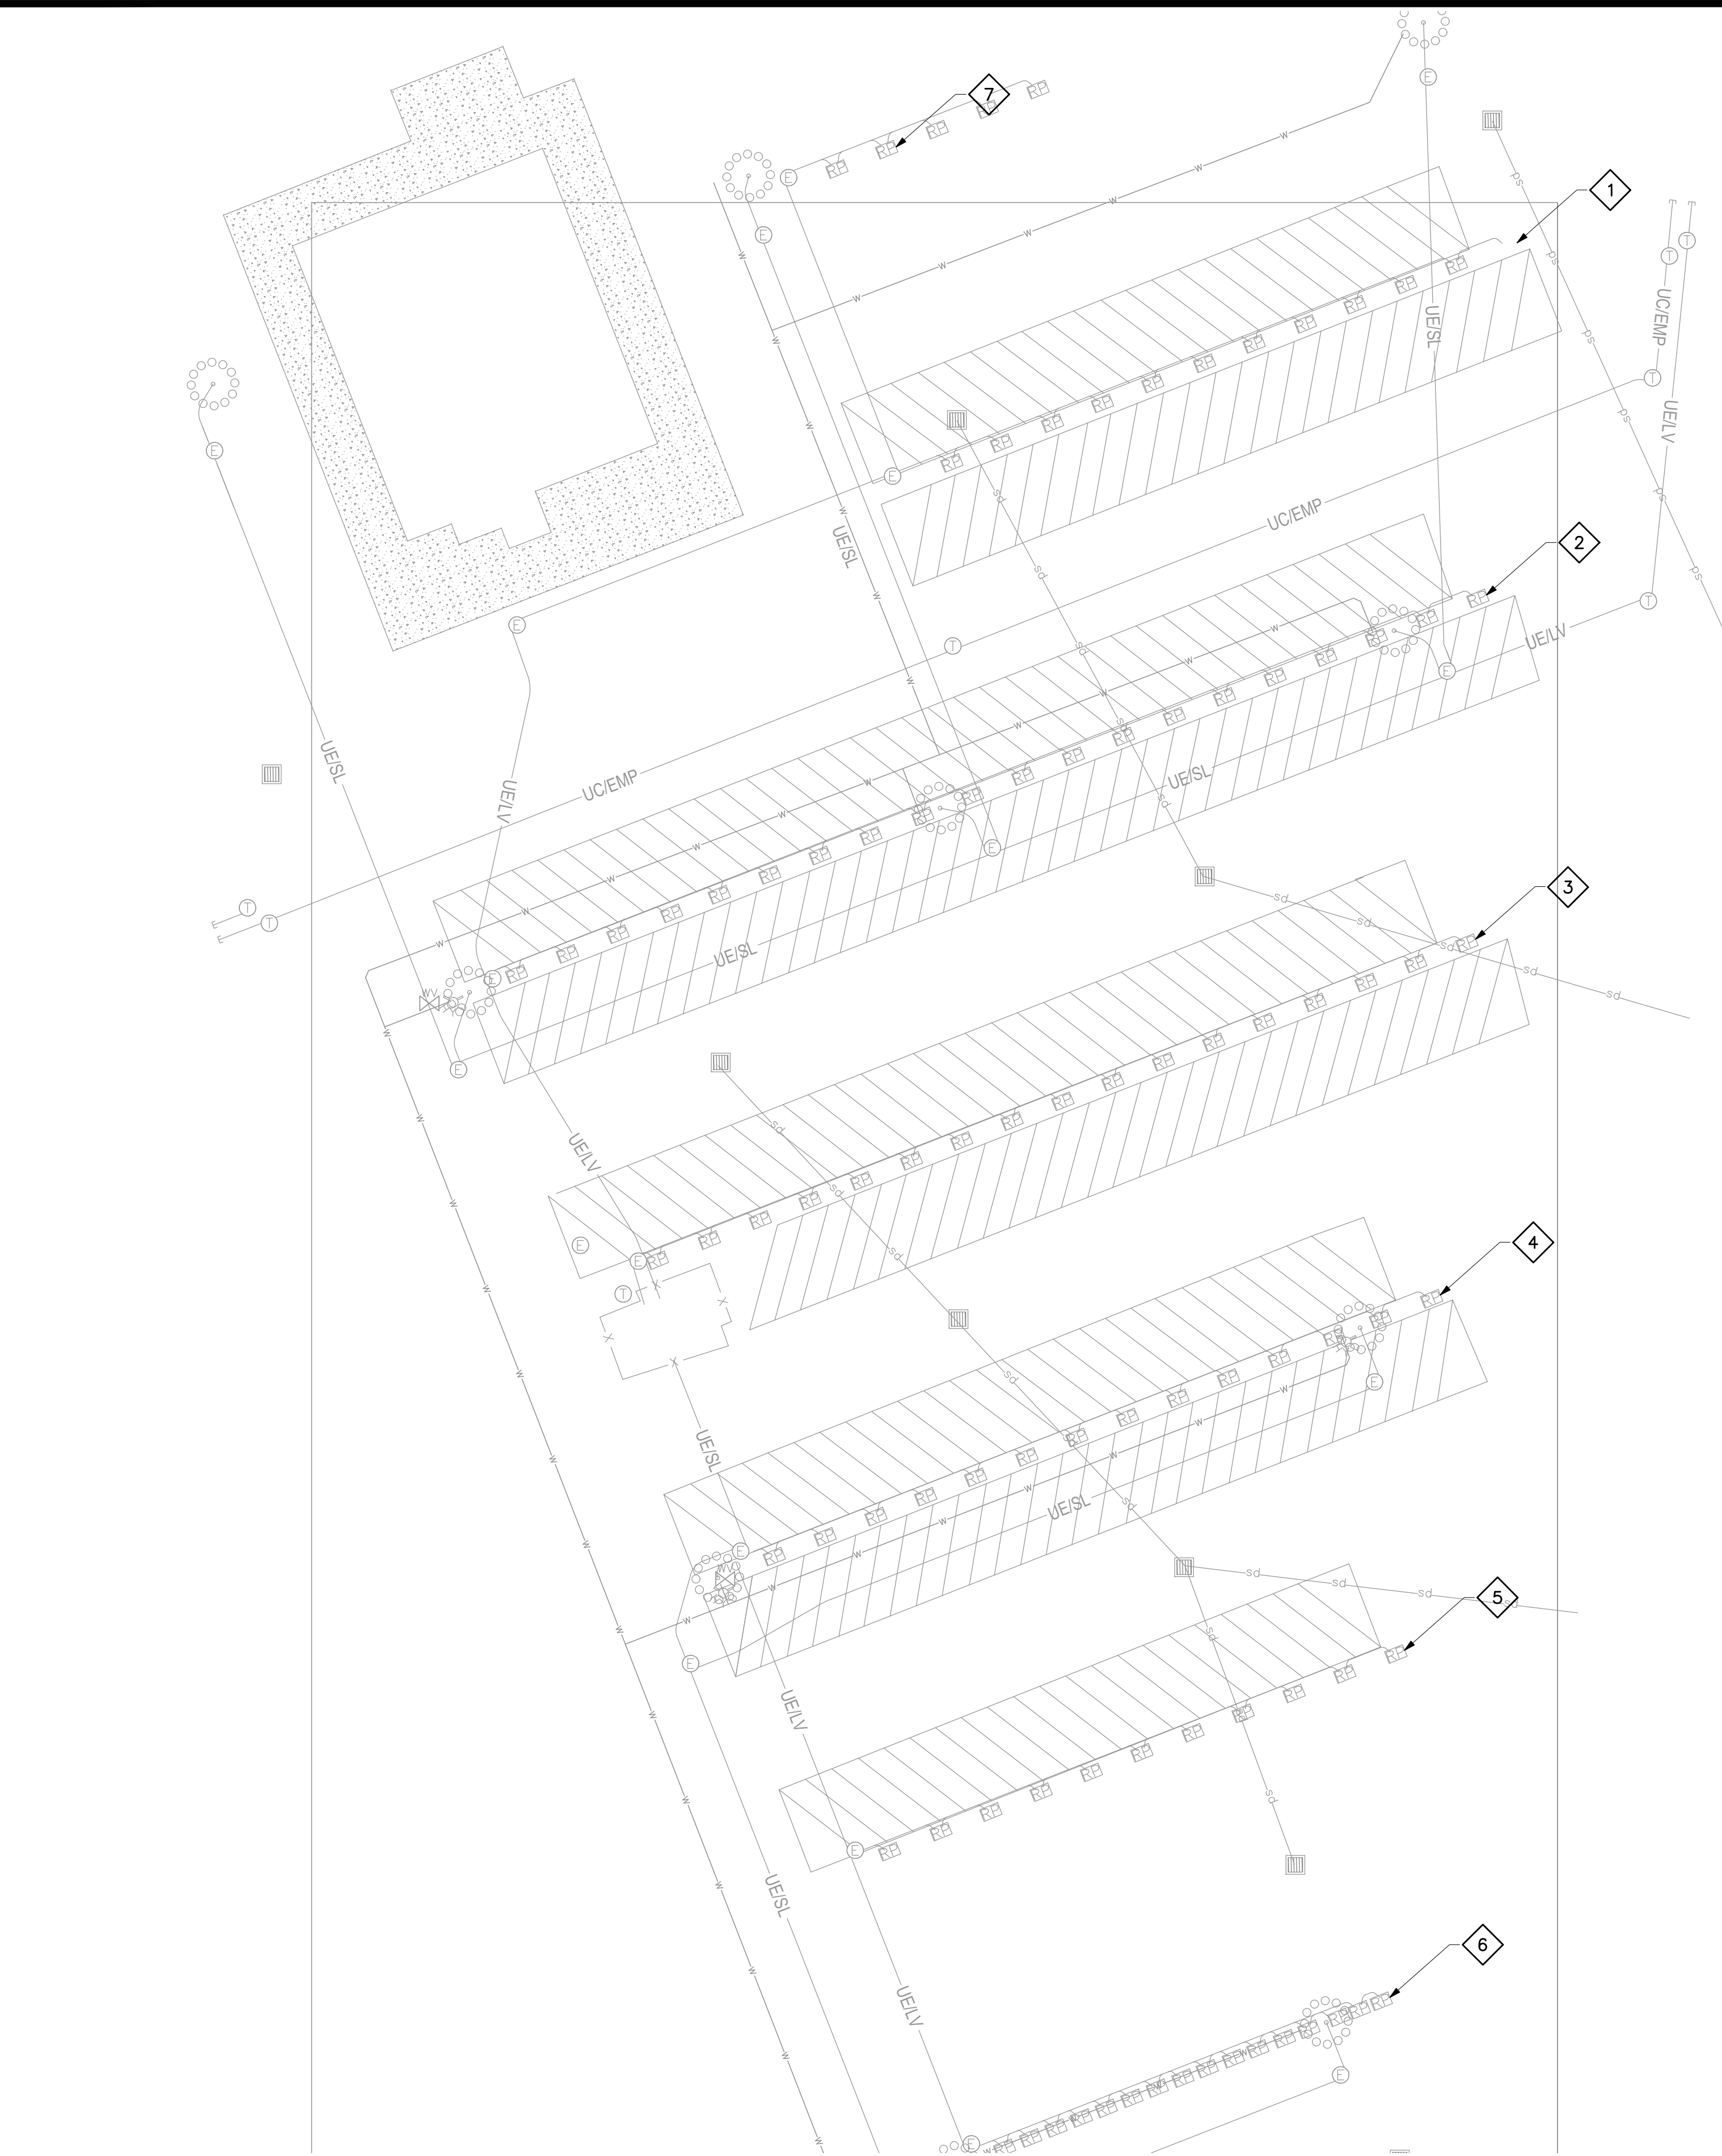
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E001

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1 ELECTRICAL DEMOLITION PLAN
SCALE: 1" = 50'-0"

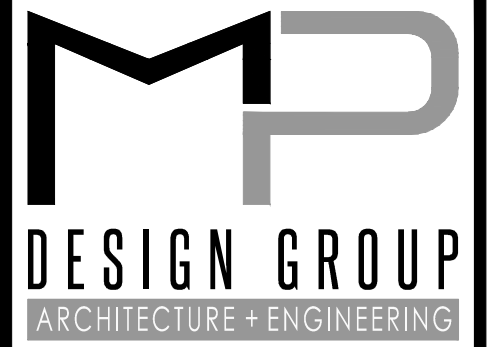


DRAWING E011 NOTES

1. CONTRACTOR SHALL REMOVE EXISTING REEFER OUTLET ASSEMBLIES AND METAL LIDS. CONTRACTOR SHALL TURN OVER THIS EQUIPMENT TO THE OWNER. CONTRACTOR SHALL DEMOLISH AND HAUL OFF ALL OTHER EQUIPMENT.
2. CONTRACTOR SHALL NOTIFY PORT OF GULFPORT AT LEAST 2 WEEKS IN ADVANCE OF ANY WORK WHICH SHALL RESULT IN OUTAGE OF POWER OR COMMUNICATIONS.
3. CONTRACTOR SHALL RESTORE SURFACE GRADE MATERIALS TO LIKE NEW CONDITION.
4. DEMOLITION DRAWING SHOWS TYPICAL EQUIPMENT TO BE DEMOLISHED, ALL ITEMS MAY NOT BE SHOWN. CONTRACTOR SHALL COORDINATE IN THE FIELD AND WITH THE CONSTRUCTION MANAGER FOR COMPLETE DEMOLITION SCOPE OF WORK.

DRAWING E011 SPECIFIC NOTES

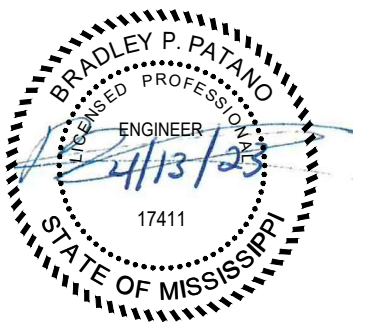
- 1 CONTRACTOR SHALL DEMOLISH REEFER OUTLET ASSEMBLIES (TYPICAL FOR 12 IN THIS ROW). CONTRACTOR SHALL RESERVE FEEDER CONDUCTOR FOR NEW REEFER OUTLET ASSEMBLIES.
- 2 CONTRACTOR SHALL DEMOLISH REEFER OUTLET ASSEMBLIES (TYPICAL FOR 20 IN THIS ROW). CONTRACTOR SHALL RESERVE FEEDER CONDUCTOR FOR NEW REEFER OUTLET ASSEMBLIES.
- 3 CONTRACTOR SHALL DEMOLISH REEFER OUTLET ASSEMBLIES (TYPICAL FOR 17 IN THIS ROW). CONTRACTOR SHALL RESERVE FEEDER CONDUCTOR FOR NEW REEFER OUTLET ASSEMBLIES.
- 4 CONTRACTOR SHALL DEMOLISH REEFER OUTLET ASSEMBLIES (TYPICAL FOR 14 IN THIS ROW). CONTRACTOR SHALL RESERVE FEEDER CONDUCTOR FOR NEW REEFER OUTLET ASSEMBLIES.
- 5 CONTRACTOR SHALL DEMOLISH REEFER OUTLET ASSEMBLIES (TYPICAL FOR 11 IN THIS ROW). CONTRACTOR SHALL RESERVE FEEDER CONDUCTOR FOR NEW REEFER OUTLET ASSEMBLIES.
- 6 CONTRACTOR SHALL DEMOLISH REEFER OUTLET ASSEMBLIES (TYPICAL FOR 16 IN THIS ROW). CONTRACTOR SHALL RESERVE FEEDER CONDUCTOR FOR NEW REEFER OUTLET ASSEMBLIES.
- 7 CONTRACTOR SHALL DEMOLISH REEFER OUTLET ASSEMBLIES (TYPICAL FOR 5 IN THIS ROW). CONTRACTOR SHALL RESERVE FEEDER CONDUCTOR FOR NEW REEFER OUTLET ASSEMBLIES.



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ELEVATED REEFER PLUGS
PORT OF GULFPORT MISSISSIPPI
STATE PORT AUTHORITY
30TH AVENUE
GULFPORT, MS 39501

SCALE: AS INDICATED
PROJECT NO: 0297.22.002
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ELECTRICAL DEMOLITION PLAN

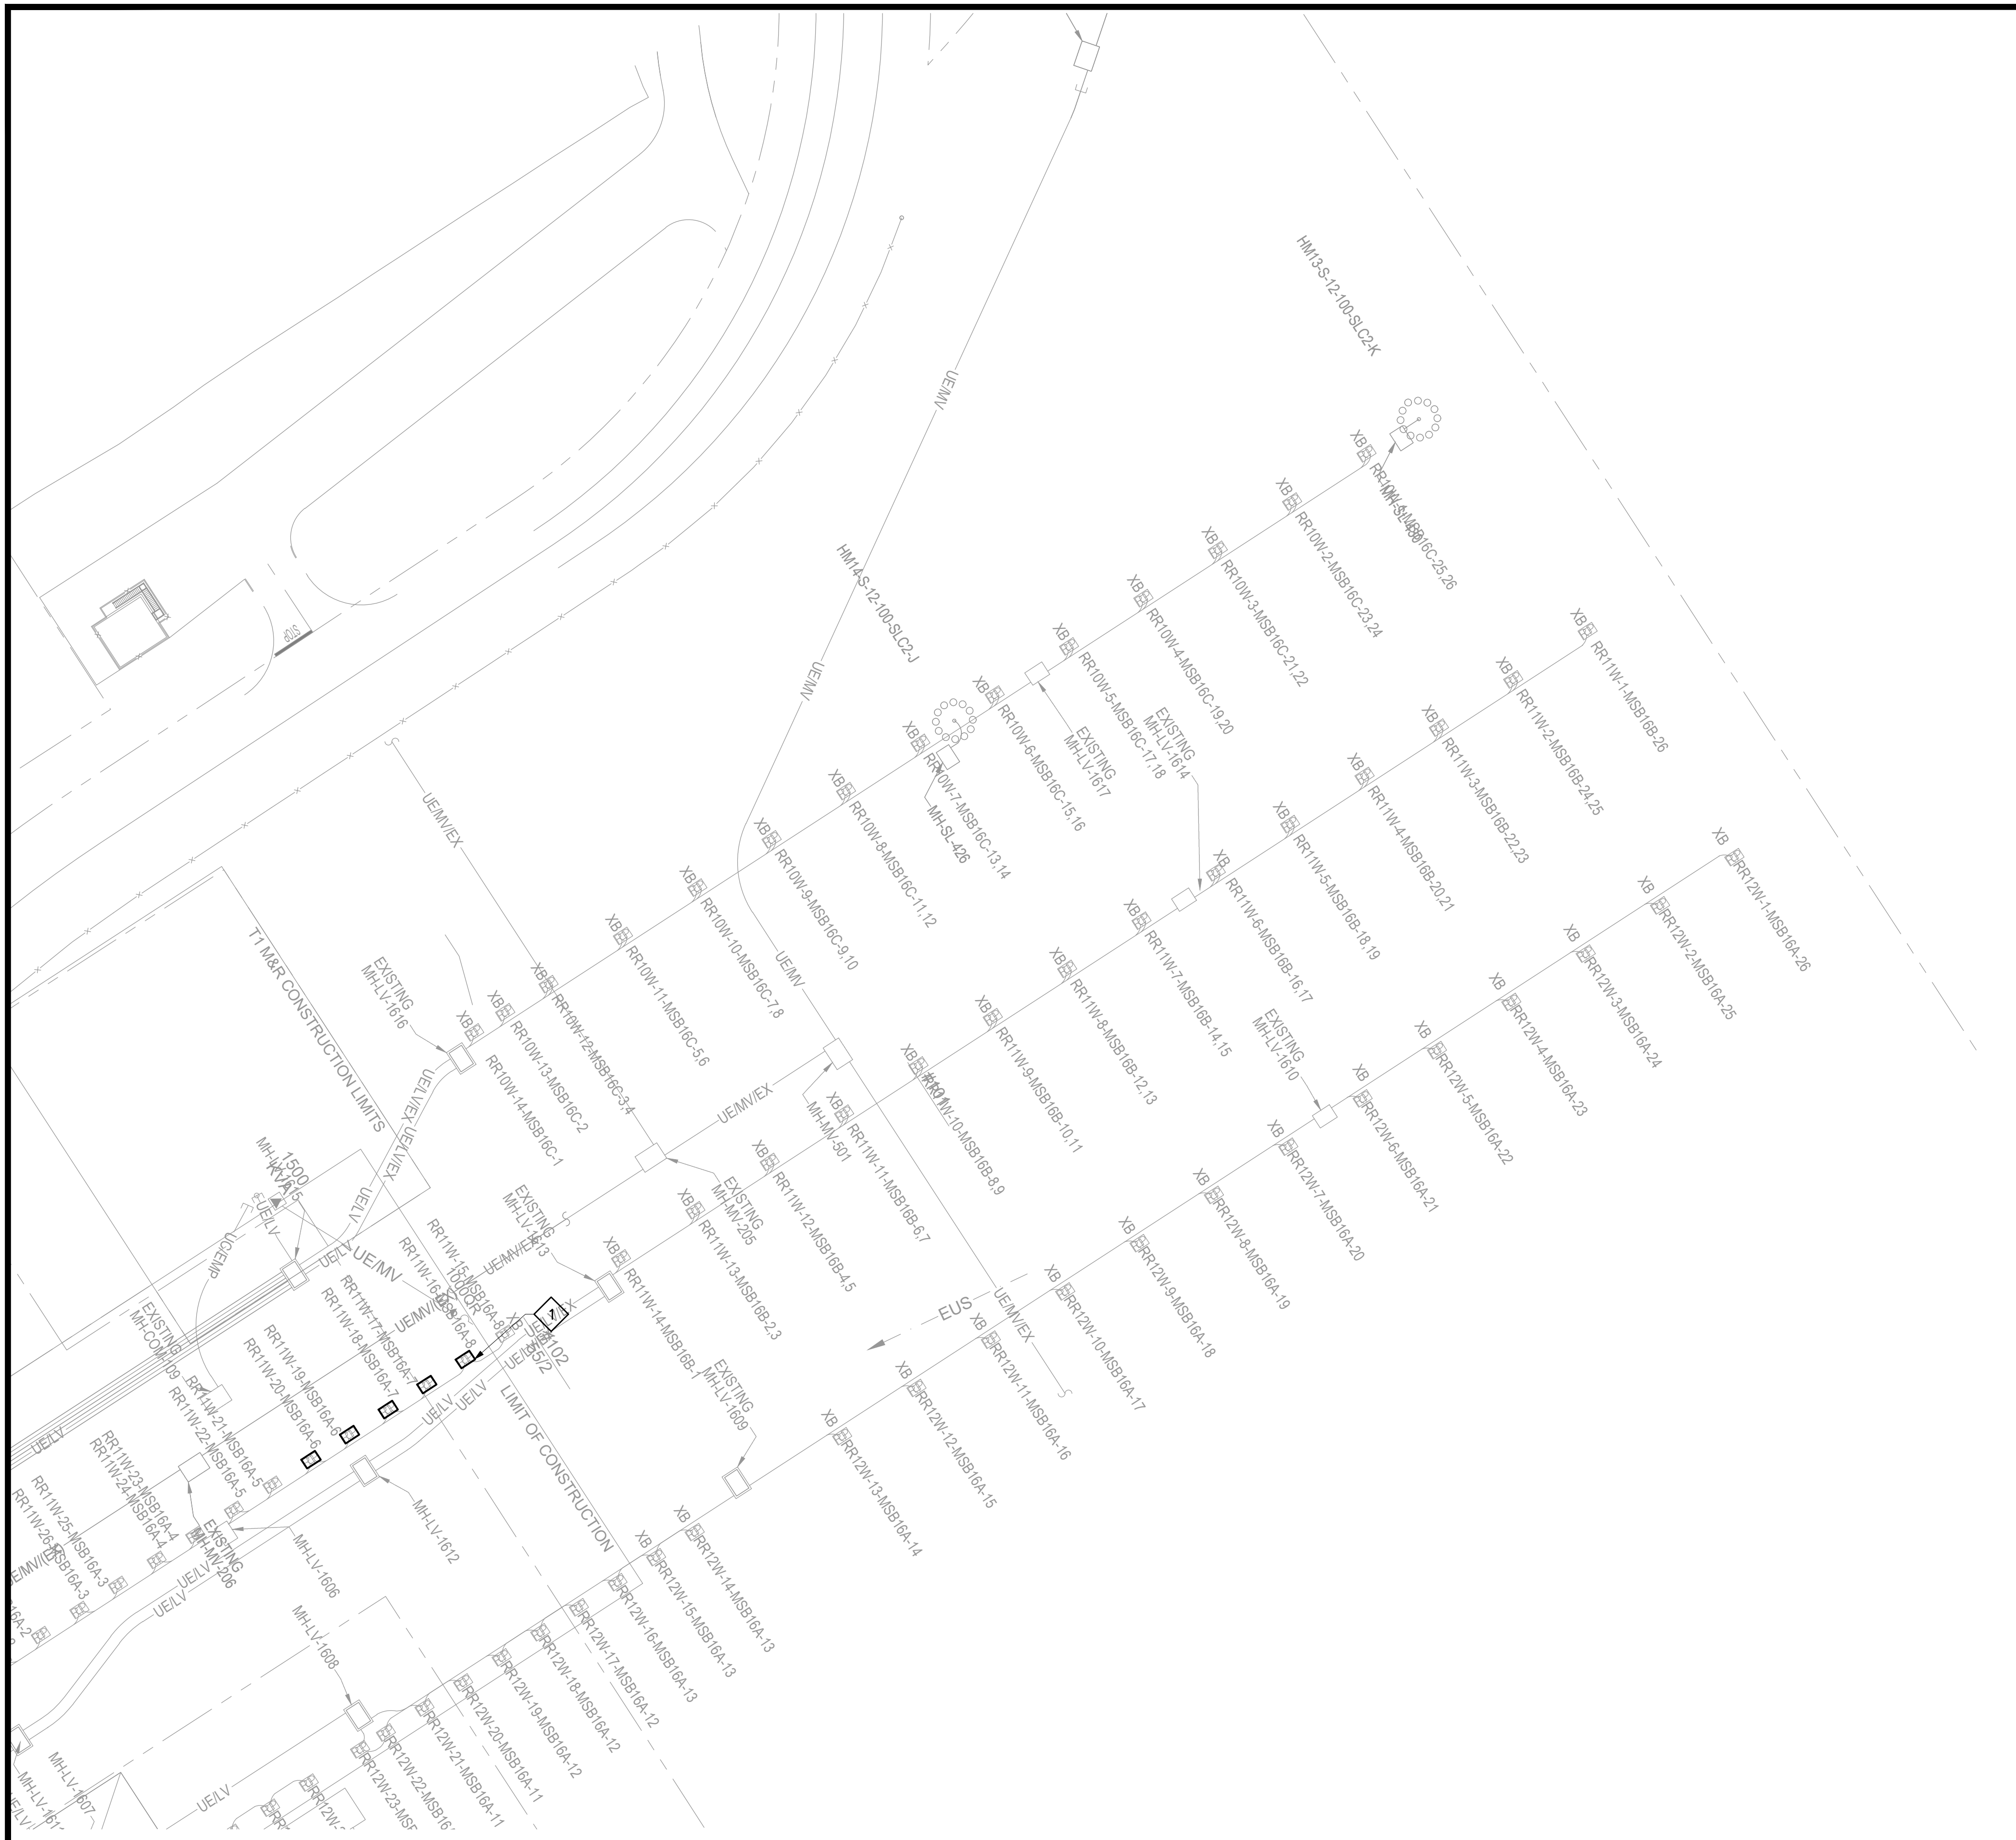
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E011

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DRAWING E012 NOTES

- CONTRACTOR SHALL REMOVE EXISTING REEFER OUTLET ASSEMBLIES AND METAL LIDS. CONTRACTOR SHALL TURN OVER THIS EQUIPMENT TO THE OWNER. CONTRACTOR SHALL DEMOLISH AND HAUL OFF ALL OTHER EQUIPMENT.
- CONTRACTOR SHALL NOTIFY PORT OF GULFPORT AT LEAST 2 WEEKS IN ADVANCE OF ANY WORK WHICH SHALL RESULT IN OUTAGE OF POWER OR COMMUNICATIONS.
- CONTRACTOR SHALL RESTORE SURFACE GRADE MATERIALS TO LIKE NEW CONDITION.
- DEMOLITION DRAWING SHOWS TYPICAL EQUIPMENT TO BE DEMOLISHED, ALL ITEMS MAY NOT BE SHOWN. CONTRACTOR SHALL COORDINATE IN THE FIELD AND WITH THE CONSTRUCTION MANAGER FOR COMPLETE DEMOLITION SCOPE OF WORK.

DRAWING E012 SPECIFIC NOTES

1 CONTRACTOR SHALL DEMOLISH REEFER OUTLET ASSEMBLIES (TYPICAL FOR 5 IN THIS ROW). CONTRACTOR SHALL RESERVE FEEDER CONDUCTOR FOR NEW REEFER OUTLET ASSEMBLIES. REEFER OUTLET ASSEMBLIES RR-11W-16, RR-11W-17, RR-11W-18, RR-11W-19 AND RR-11W-20.

1 ELECTRICAL DEMOLITION PLAN
 SCALE: 1" = 50'-0"

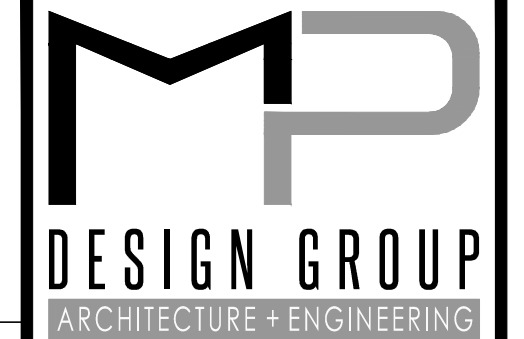


DRAWING E012 NOTES

- CONTRACTOR SHALL REMOVE EXISTING REEFER OUTLET ASSEMBLIES AND METAL LIDS. CONTRACTOR SHALL TURN OVER THIS EQUIPMENT TO THE OWNER. CONTRACTOR SHALL DEMOLISH AND HAUL OFF ALL OTHER EQUIPMENT.
- CONTRACTOR SHALL NOTIFY PORT OF GULFPORT AT LEAST 2 WEEKS IN ADVANCE OF ANY WORK WHICH SHALL RESULT IN OUTAGE OF POWER OR COMMUNICATIONS.
- CONTRACTOR SHALL RESTORE SURFACE GRADE MATERIALS TO LIKE NEW CONDITION.
- DEMOLITION DRAWING SHOWS TYPICAL EQUIPMENT TO BE DEMOLISHED, ALL ITEMS MAY NOT BE SHOWN. CONTRACTOR SHALL COORDINATE IN THE FIELD AND WITH THE CONSTRUCTION MANAGER FOR COMPLETE DEMOLITION SCOPE OF WORK.

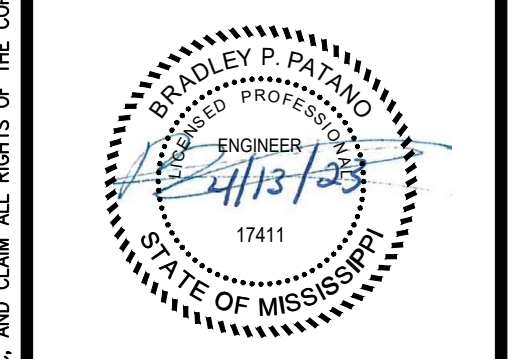
DRAWING E012 SPECIFIC NOTES

1 CONTRACTOR SHALL DEMOLISH REEFER OUTLET ASSEMBLIES (TYPICAL FOR 5 IN THIS ROW). CONTRACTOR SHALL RESERVE FEEDER CONDUCTOR FOR NEW REEFER OUTLET ASSEMBLIES. REEFER OUTLET ASSEMBLIES RR-11W-16, RR-11W-17, RR-11W-18, RR-11W-19 AND RR-11W-20.



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ELEVATED REEFER PLUGS
PORT OF GULFPORT MISSISSIPPI
STATE PORT AUTHORITY
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ELECTRICAL DEMOLITION PLAN

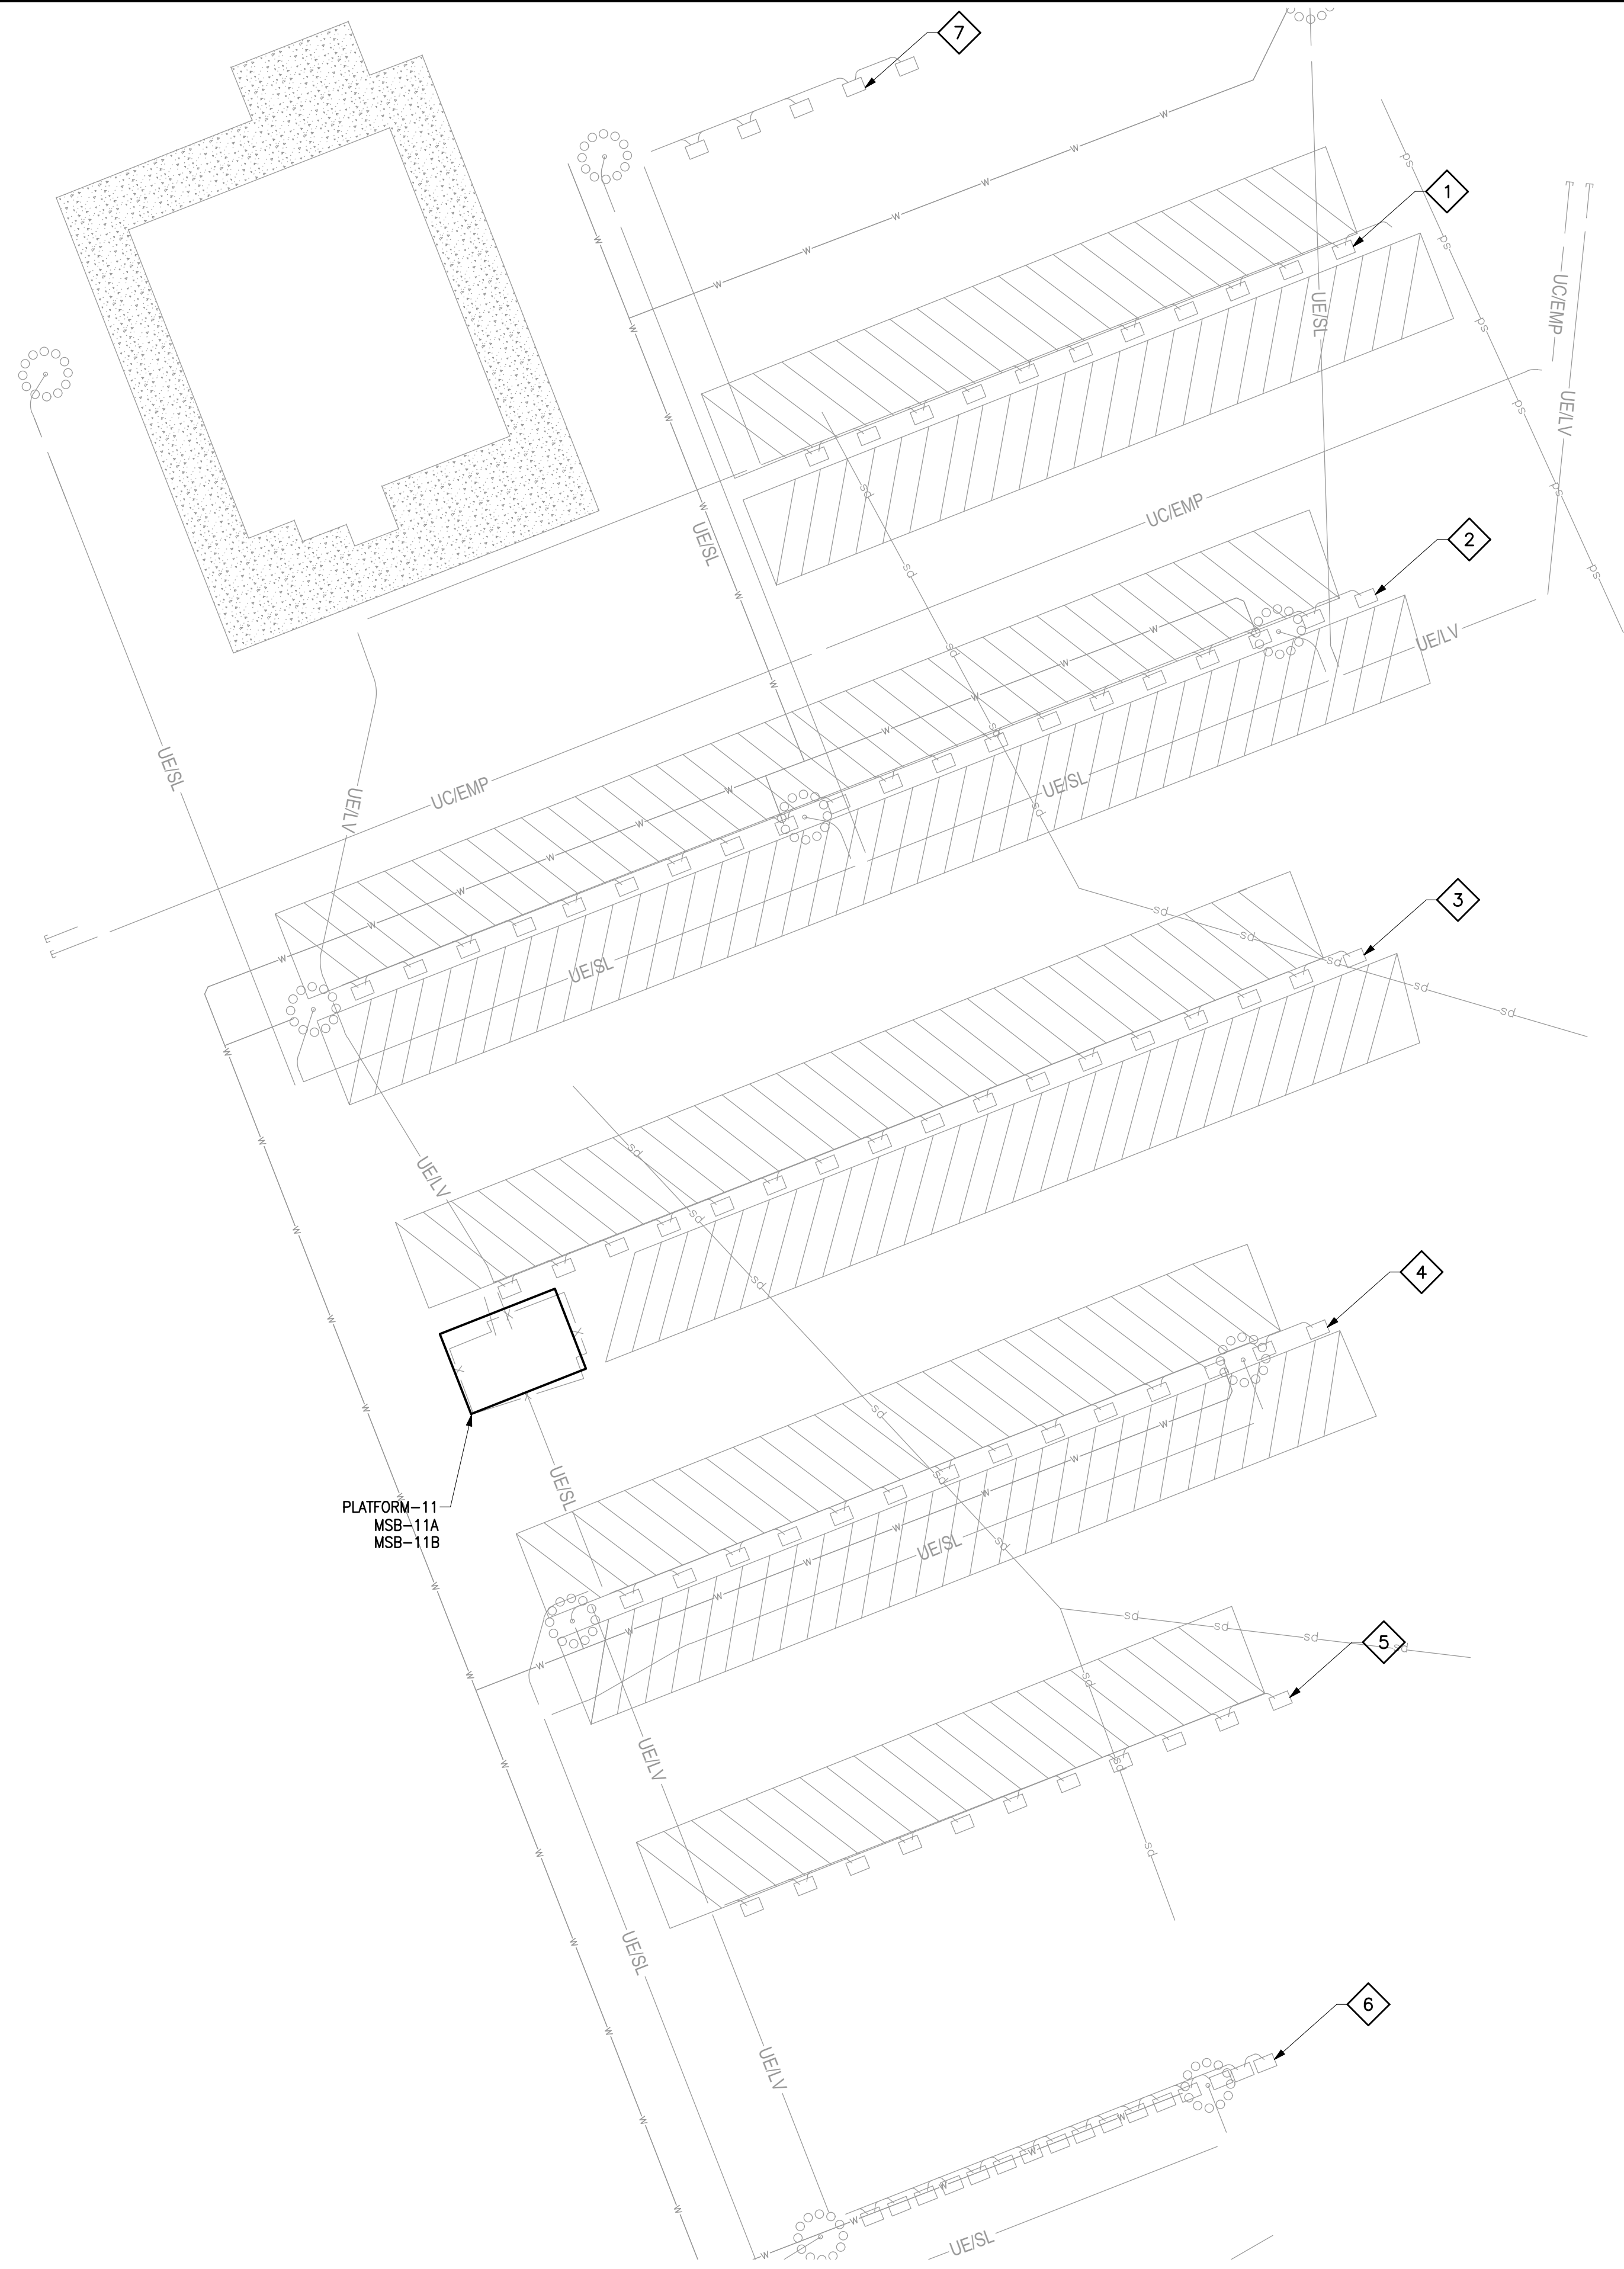
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1 ELECTRICAL OVERALL PLAN
 SCALE: 1" = 50'-0"



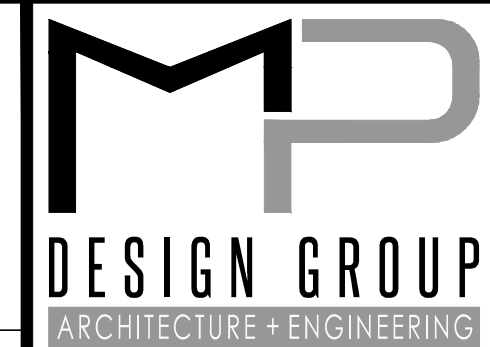
DRAWING E101 NOTES

1. ALL EXTERIOR CONDUIT ABOVE GRADE SHALL BE RIGID GALVANIZED STEEL.
2. ALL REEFER OUTLET ASSEMBLIES ARE OWNER FURNISHED EQUIPMENT. SEE SHEET E002 FOR DETAILS.

DRAWING E101 SPECIFIC NOTES

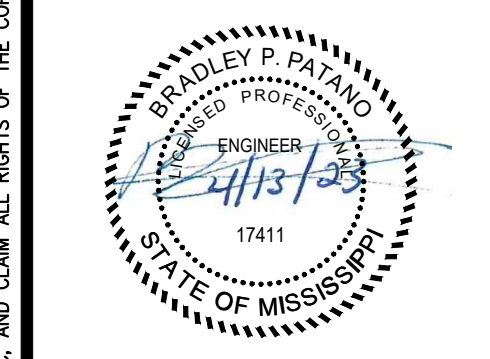
1. CONTRACTOR SHALL INSTALL REEFER OUTLET ASSEMBLIES (TYPICAL FOR 12 IN THIS ROW, PROVIDED BY OWNER, INSTALLED BY CONTRACTOR). REEFER OUTLET ASSEMBLY SHALL BE ELEVATED, SEE CIVIL SHEET C620 FOR DETAILS. CONTRACTOR SHALL RE-USE AND EXTEND EXISTING FEEDER CONDUCTOR. SEE SHEET E501 FOR DETAILS.
2. CONTRACTOR SHALL INSTALL REEFER OUTLET ASSEMBLIES (TYPICAL FOR 20 IN THIS ROW, PROVIDED BY OWNER, INSTALLED BY CONTRACTOR). REEFER OUTLET ASSEMBLY SHALL BE ELEVATED, SEE CIVIL SHEET C620 FOR DETAILS. CONTRACTOR SHALL RE-USE AND EXTEND EXISTING FEEDER CONDUCTOR. SEE SHEET E501 FOR DETAILS.
3. CONTRACTOR SHALL INSTALL REEFER OUTLET ASSEMBLIES (TYPICAL FOR 17 IN THIS ROW, PROVIDED BY OWNER, INSTALLED BY CONTRACTOR). REEFER OUTLET ASSEMBLY SHALL BE ELEVATED, SEE CIVIL SHEET C620 FOR DETAILS. CONTRACTOR SHALL RE-USE AND EXTEND EXISTING FEEDER CONDUCTOR. SEE SHEET E501 FOR DETAILS.
4. CONTRACTOR SHALL INSTALL REEFER OUTLET ASSEMBLIES (TYPICAL FOR 14 IN THIS ROW, PROVIDED BY OWNER, INSTALLED BY CONTRACTOR). REEFER OUTLET ASSEMBLY SHALL BE ELEVATED, SEE CIVIL SHEET C620 FOR DETAILS. CONTRACTOR SHALL RE-USE AND EXTEND EXISTING FEEDER CONDUCTOR. SEE SHEET E501 FOR DETAILS.
5. CONTRACTOR SHALL INSTALL REEFER OUTLET ASSEMBLIES (TYPICAL FOR 11 IN THIS ROW, PROVIDED BY OWNER, INSTALLED BY CONTRACTOR). REEFER OUTLET ASSEMBLY SHALL BE ELEVATED, SEE CIVIL SHEET C620 FOR DETAILS. CONTRACTOR SHALL RE-USE AND EXTEND EXISTING FEEDER CONDUCTOR. SEE SHEET E501 FOR DETAILS.
6. CONTRACTOR SHALL INSTALL REEFER OUTLET ASSEMBLIES (TYPICAL FOR 16 IN THIS ROW, PROVIDED BY OWNER, INSTALLED BY CONTRACTOR). REEFER OUTLET ASSEMBLY SHALL BE ELEVATED, SEE CIVIL SHEET C620 FOR DETAILS. CONTRACTOR SHALL RE-USE AND EXTEND EXISTING FEEDER CONDUCTOR. SEE SHEET E501 FOR DETAILS.
7. CONTRACTOR SHALL INSTALL REEFER OUTLET ASSEMBLIES (TYPICAL FOR 5 IN THIS ROW, PROVIDED BY OWNER, INSTALLED BY CONTRACTOR). REEFER OUTLET ASSEMBLY SHALL BE ELEVATED, SEE CIVIL SHEET C620 FOR DETAILS. CONTRACTOR SHALL RE-USE AND EXTEND EXISTING FEEDER CONDUCTOR. SEE SHEET E501 FOR DETAILS.

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ELEVATED REEFER PLUGS
PORT OF GULFPORT MISSISSIPPI
STATE PORT AUTHORITY
 30TH AVENUE
 GULFPORT, MS 39501

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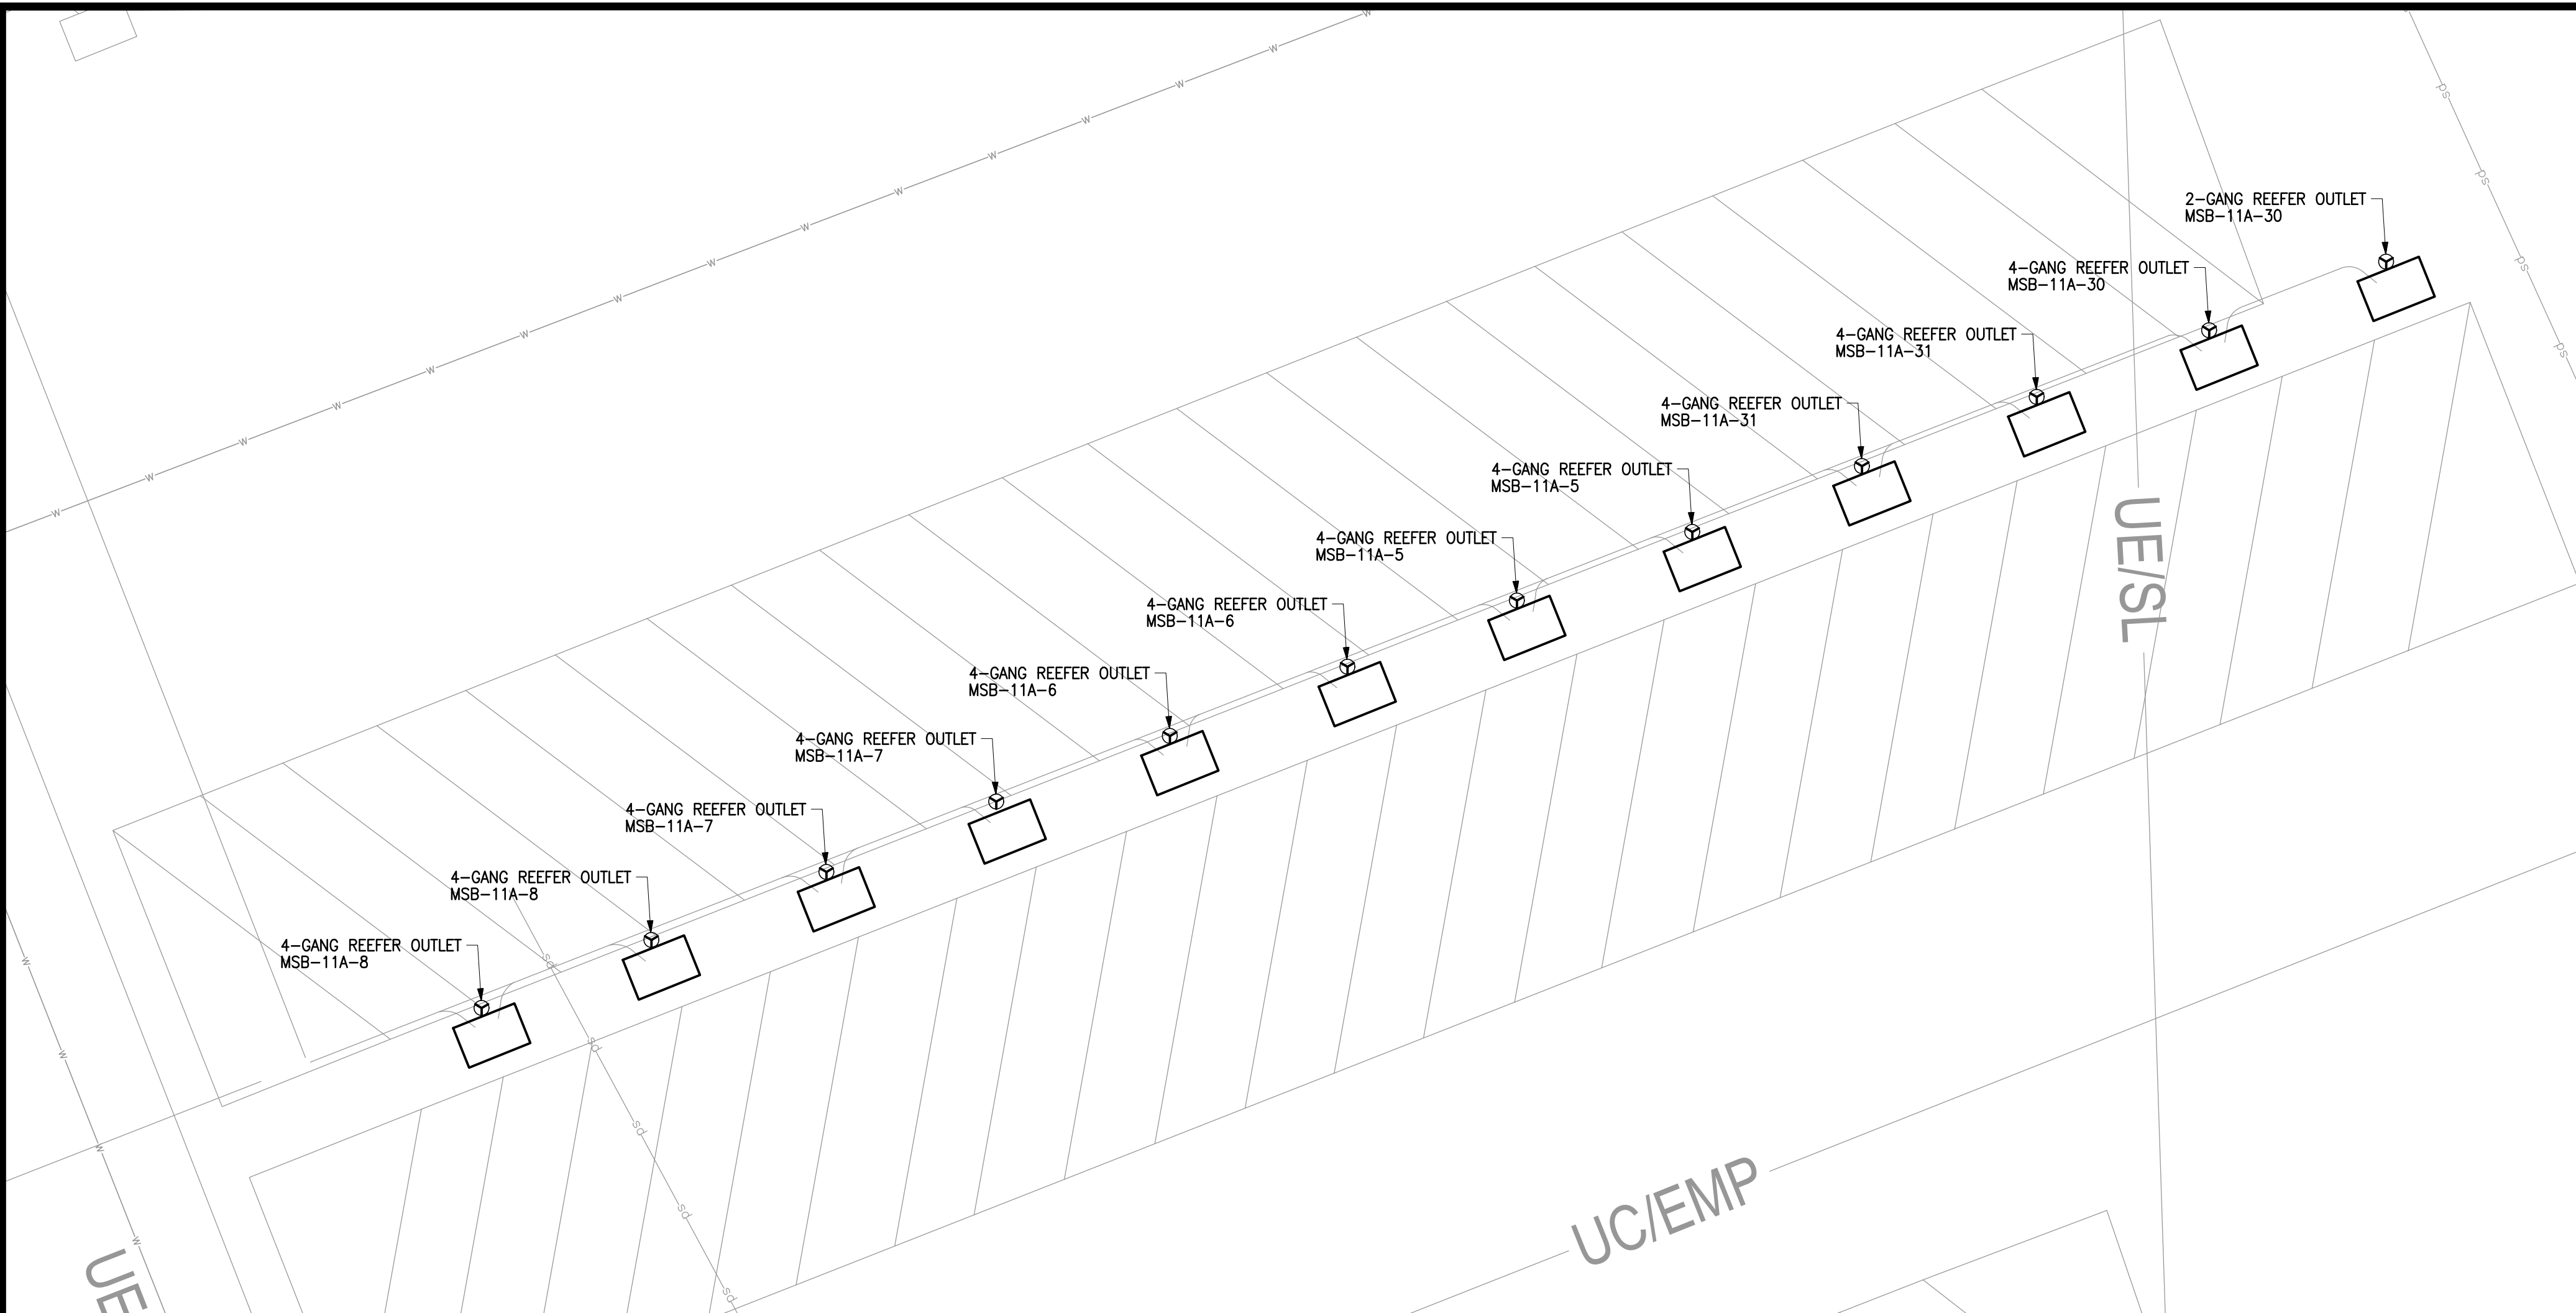
ELECTRICAL OVERALL PLAN

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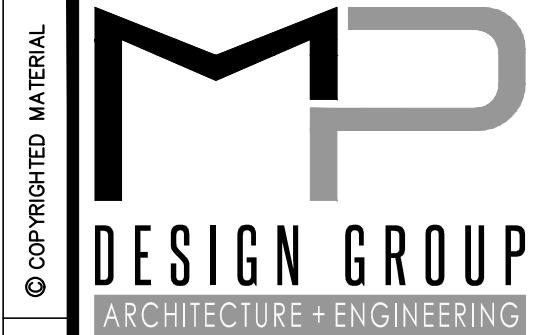
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1 ENLARGED ELECTRICAL POWER PLAN (REEFER OUTLETS RR1N)
 SCALE: 1/16" = 1'-0"

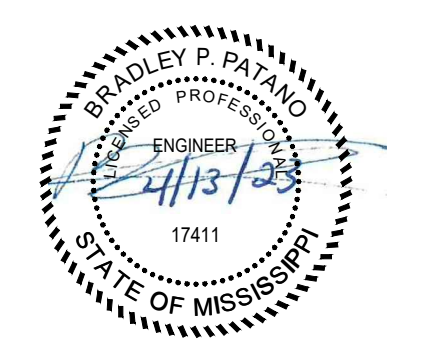
DRAWING E111 NOTES

1. ALL EXTERIOR CONDUIT ABOVE GRADE SHALL BE RIGID GALVANIZED STEEL.
2. ALL REEFER OUTLET ASSEMBLIES ARE OWNER FURNISHED EQUIPMENT. SEE SHEET E002 FOR DETAILS.



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ENLARGED ELECTRICAL POWER PLAN

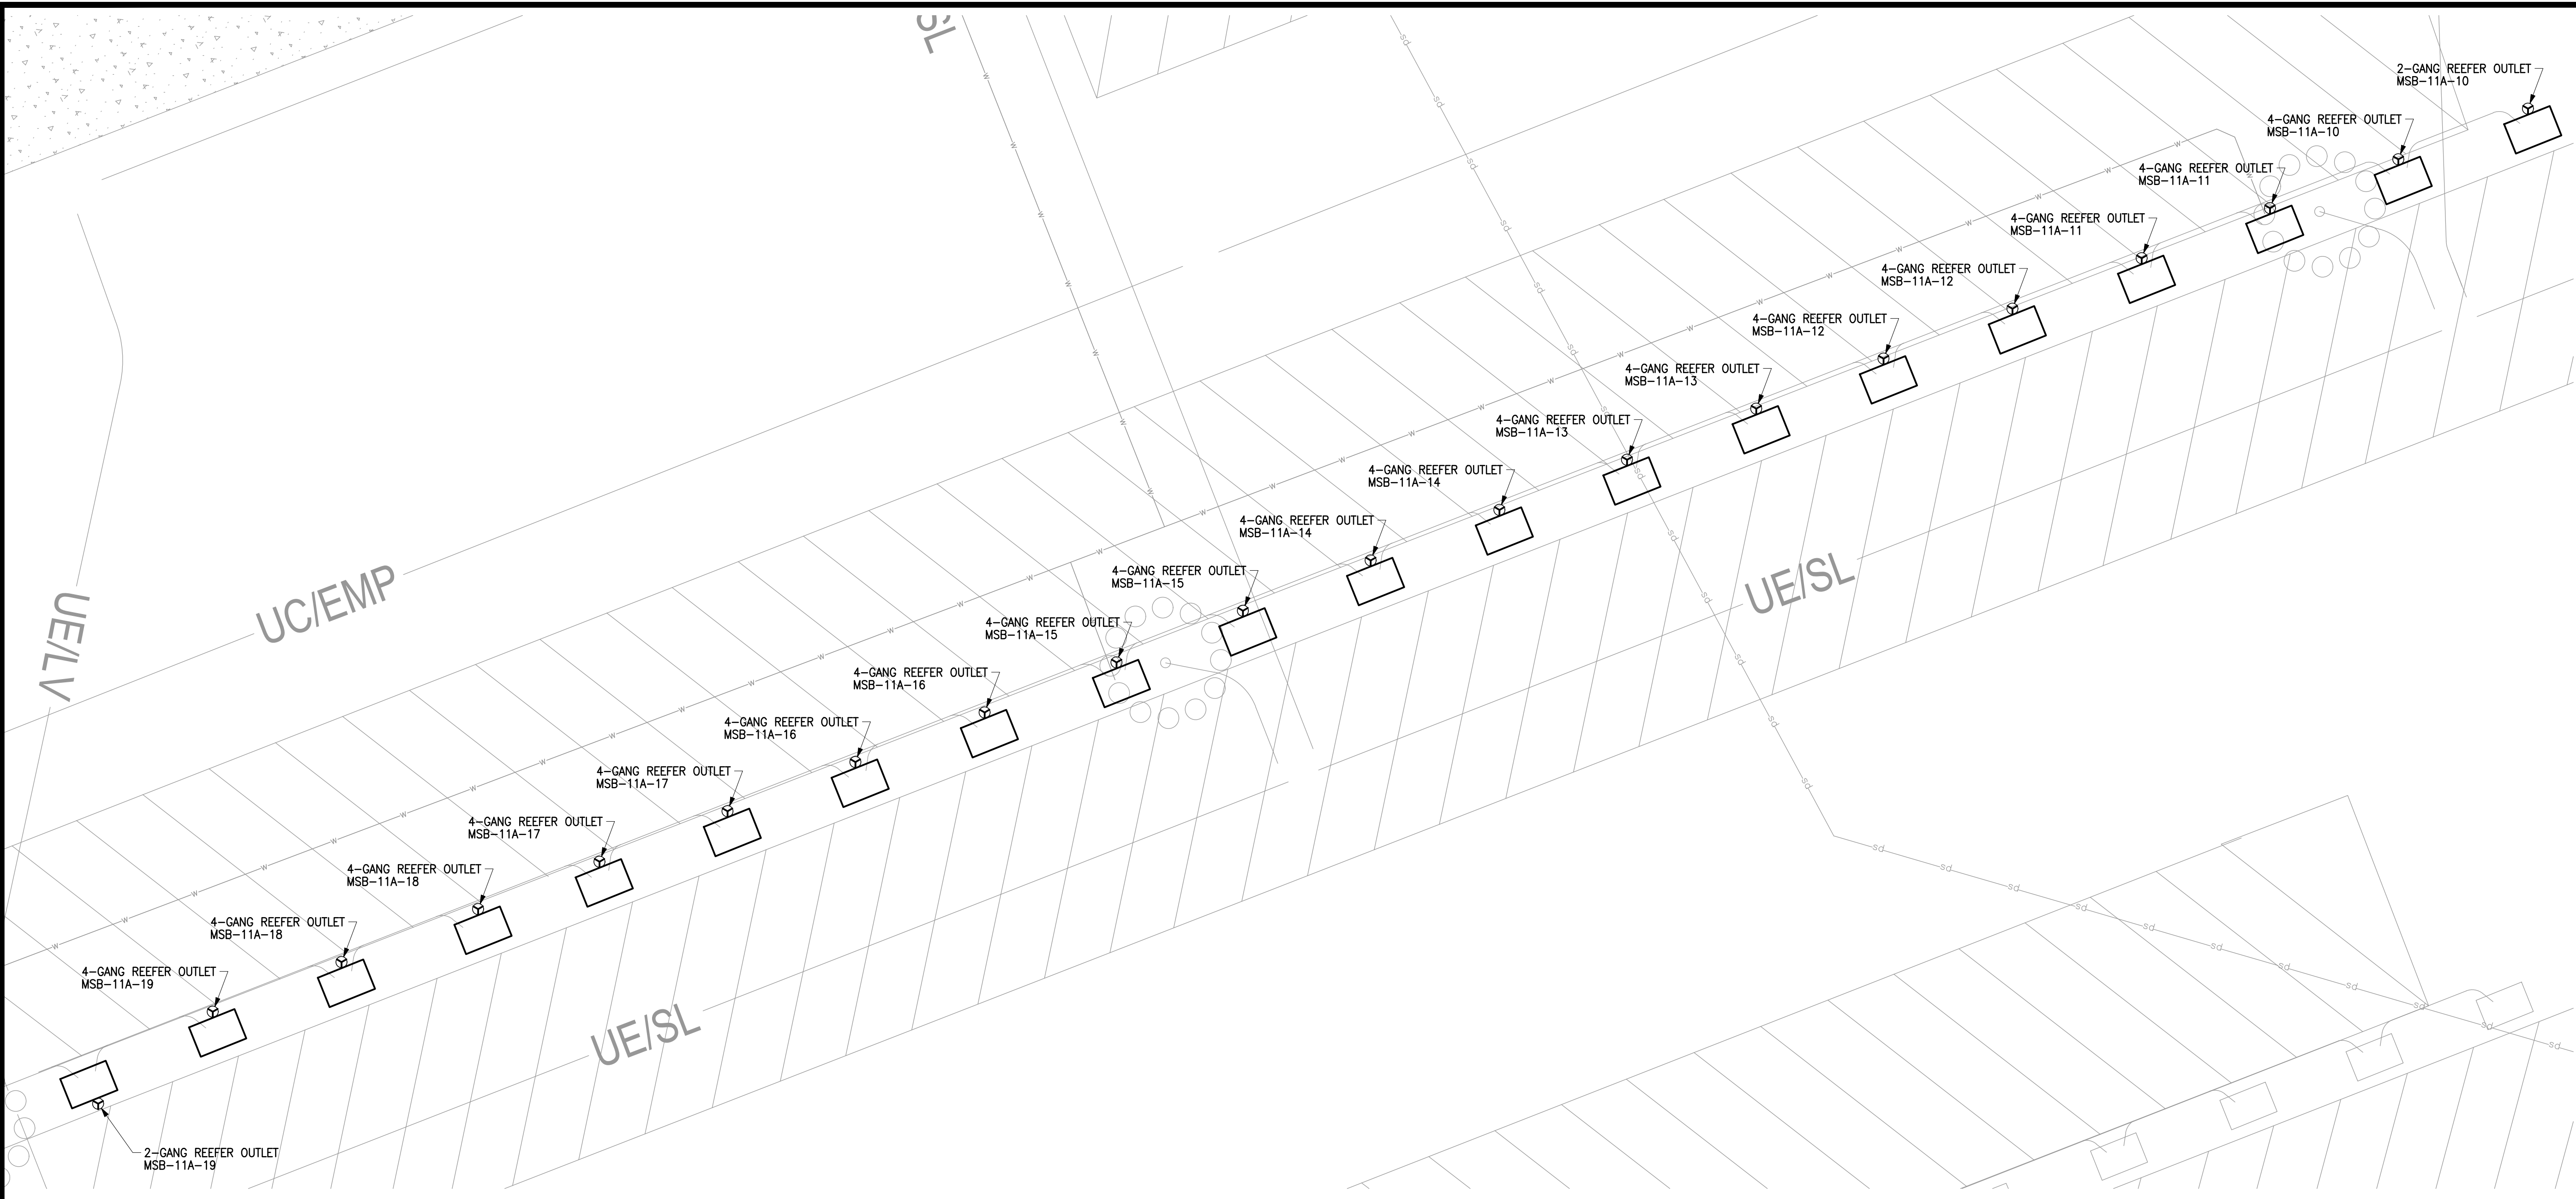
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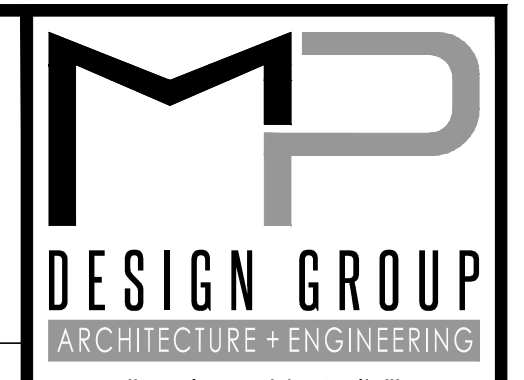
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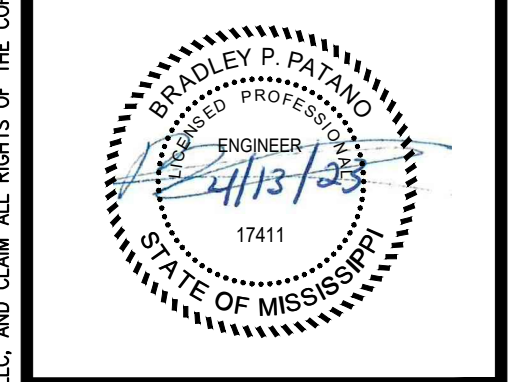
1 ENLARGED ELECTRICAL POWER PLAN (REEFER OUTLETS RR2N)
SCALE: 1/16" = 1'-0"

- DRAWING E112 NOTES**
1. ALL EXTERIOR CONDUIT ABOVE GRADE SHALL BE RIGID GALVANIZED STEEL.
 2. ALL REEFER OUTLET ASSEMBLIES ARE OWNER FURNISHED EQUIPMENT. SEE SHEET E002 FOR DETAILS.

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ELEVATED REEFER PLUGS
PORT OF GULFPORT MISSISSIPPI
STATE PORT AUTHORITY
30TH AVENUE
GULFPORT, MS 39501

SCALE: AS INDICATED
PROJECT NO: 0297.22.002
DRAWN BY: KDB
CHECKED BY: KDB

ENLARGED ELECTRICAL POWER PLAN

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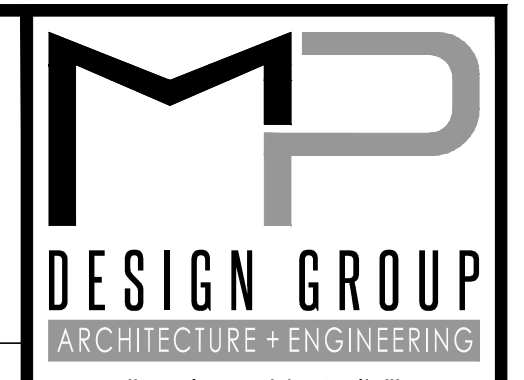
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1 ENLARGED ELECTRICAL POWER PLAN (REEFER OUTLETS RR3N)
 SCALE: 1/16" = 1'-0"

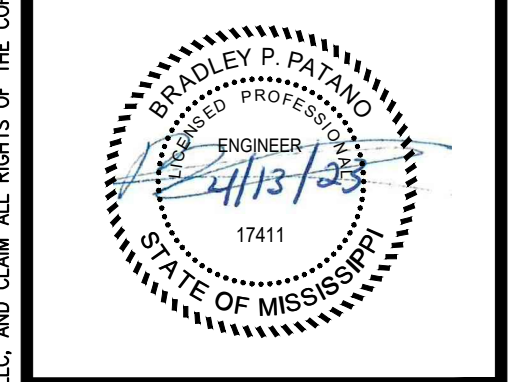
- DRAWING E113 NOTES**
1. ALL EXTERIOR CONDUIT ABOVE GRADE SHALL BE RIGID GALVANIZED STEEL.
 2. ALL REEFER OUTLET ASSEMBLIES ARE OWNER FURNISHED EQUIPMENT. SEE SHEET E002 FOR DETAILS.

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ELEVATED REEFER PLUGS
PORT OF GULFPORT MISSISSIPPI
STATE PORT AUTHORITY
 30TH AVENUE
 GULFPORT, MS 39501

SCALE: AS INDICATED
 PROJECT NO: 0297.22.002
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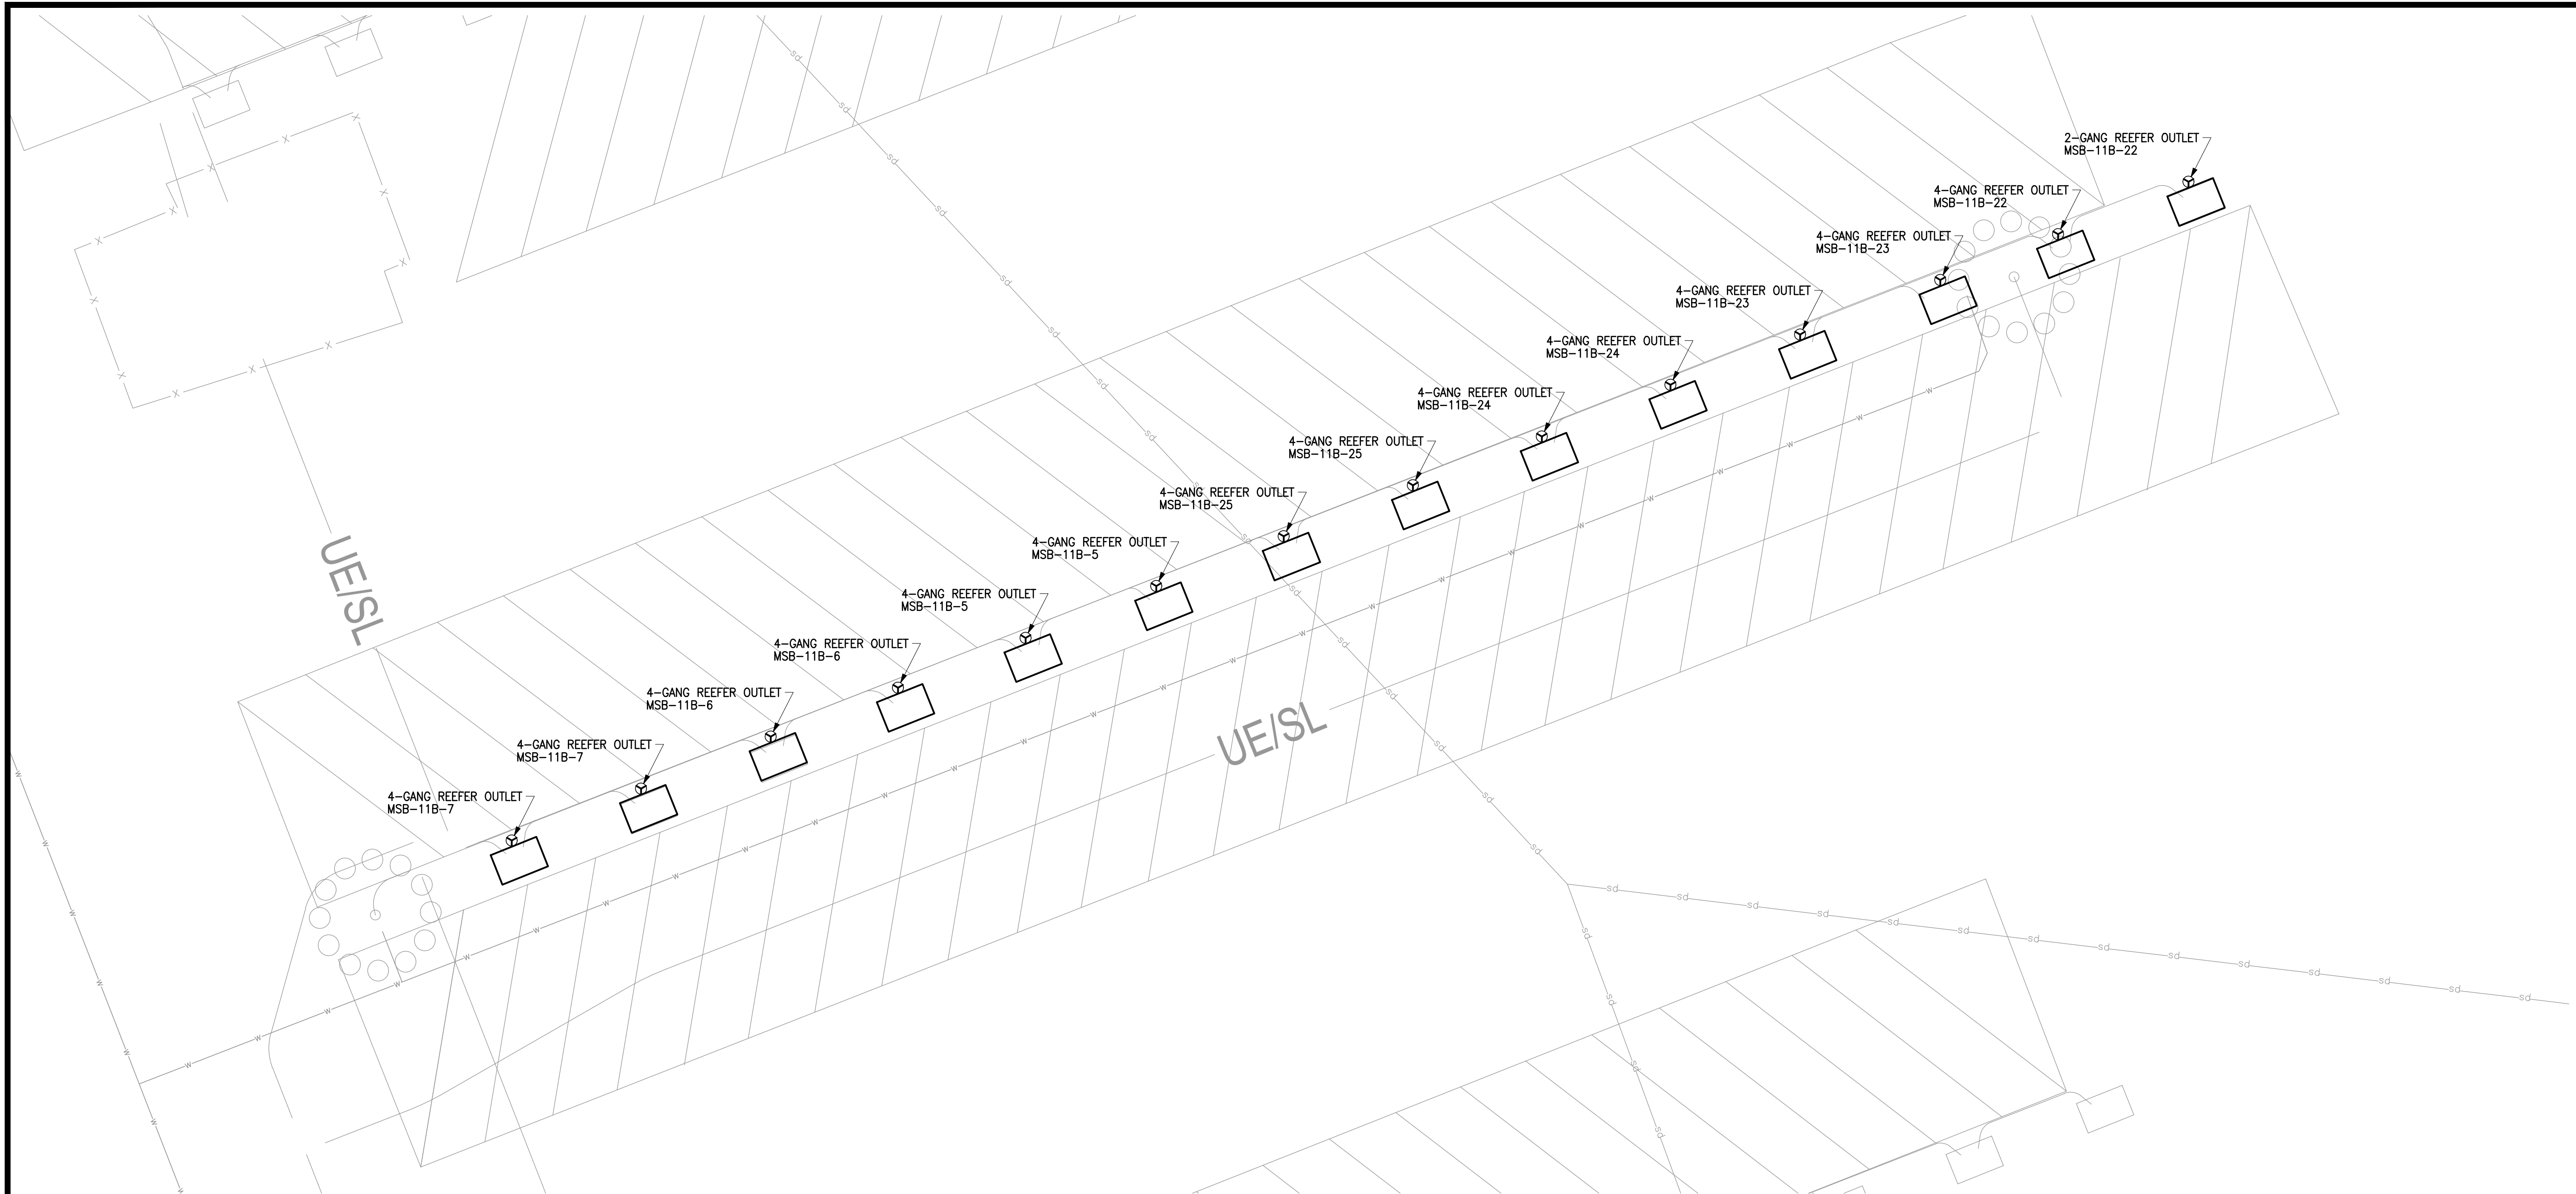
ENLARGED ELECTRICAL POWER PLAN

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1		4/13/2023	ISSUED FOR CONSTRUCTION

E113

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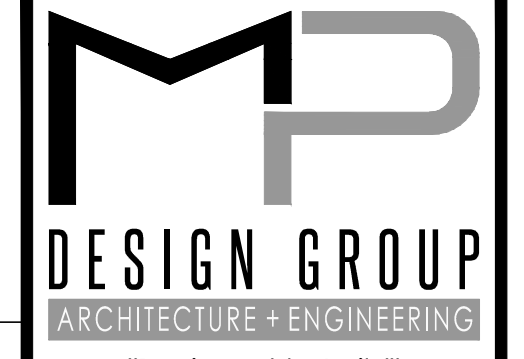
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 m:\0297_mspa_gulport\0297.22.003_work_order no 2 - reefer plug replacement & mitigation\06-electrical\02-production drawings\port of gulport reefer plugs electrical.dwg



1 ENLARGED ELECTRICAL POWER PLAN (REEFER OUTLETS RR4N)
 SCALE: 1/16" = 1'-0"

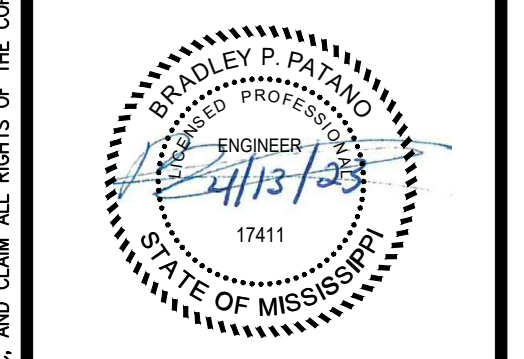
DRAWING E114 NOTES

1. ALL EXTERIOR CONDUIT ABOVE GRADE SHALL BE RIGID GALVANIZED STEEL.
2. ALL REEFER OUTLET ASSEMBLIES ARE OWNER FURNISHED EQUIPMENT. SEE SHEET E002 FOR DETAILS.



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ELEVATED REEFER PLUGS
PORT OF GULFPORT MISSISSIPPI
STATE PORT AUTHORITY
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ENLARGED ELECTRICAL POWER PLAN

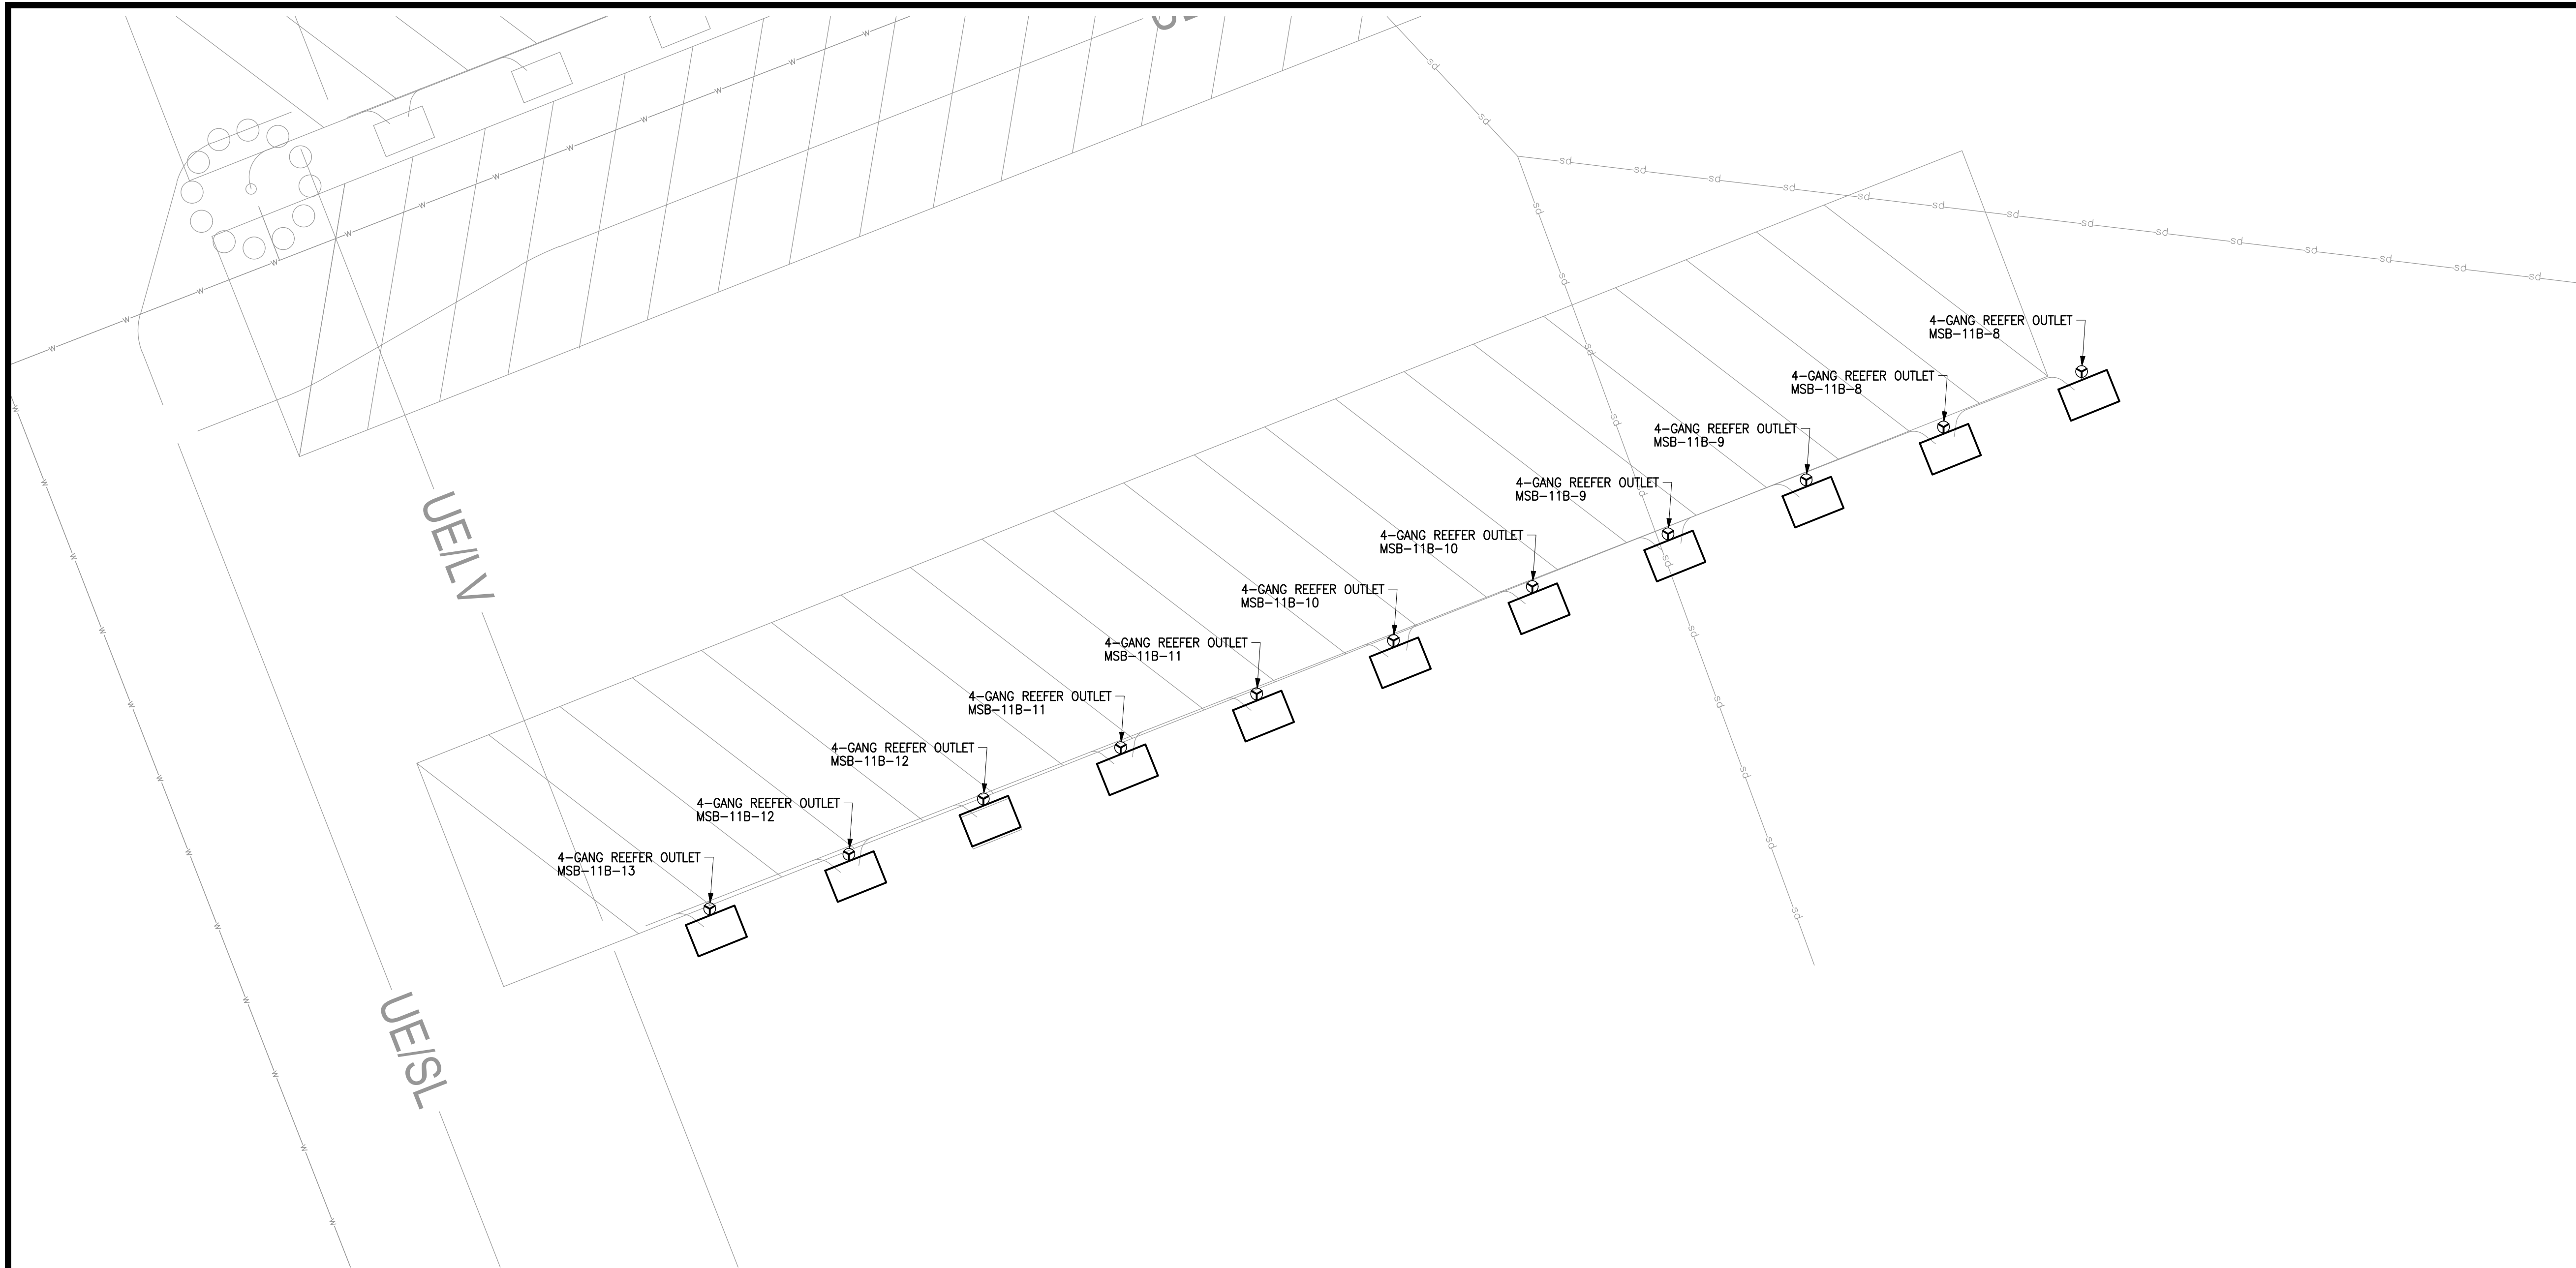
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E114

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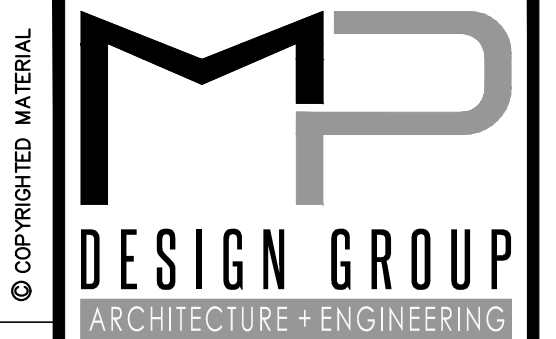
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1 ENLARGED ELECTRICAL POWER PLAN (REEFER OUTLETS RR5N)
 SCALE: 1/16" = 1'-0"

DRAWING E115 NOTES

1. ALL EXTERIOR CONDUIT ABOVE GRADE SHALL BE RIGID GALVANIZED STEEL.
2. ALL REEFER OUTLET ASSEMBLIES ARE OWNER FURNISHED EQUIPMENT. SEE SHEET E002 FOR DETAILS.



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ELEVATED REEFER PLUGS
PORT OF GULFPORT MISSISSIPPI
STATE PORT AUTHORITY
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 GULFPORT, MS 39501

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E115

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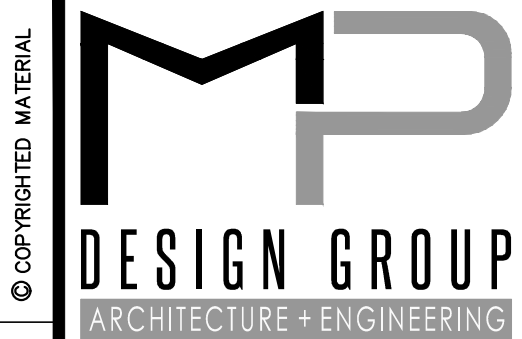
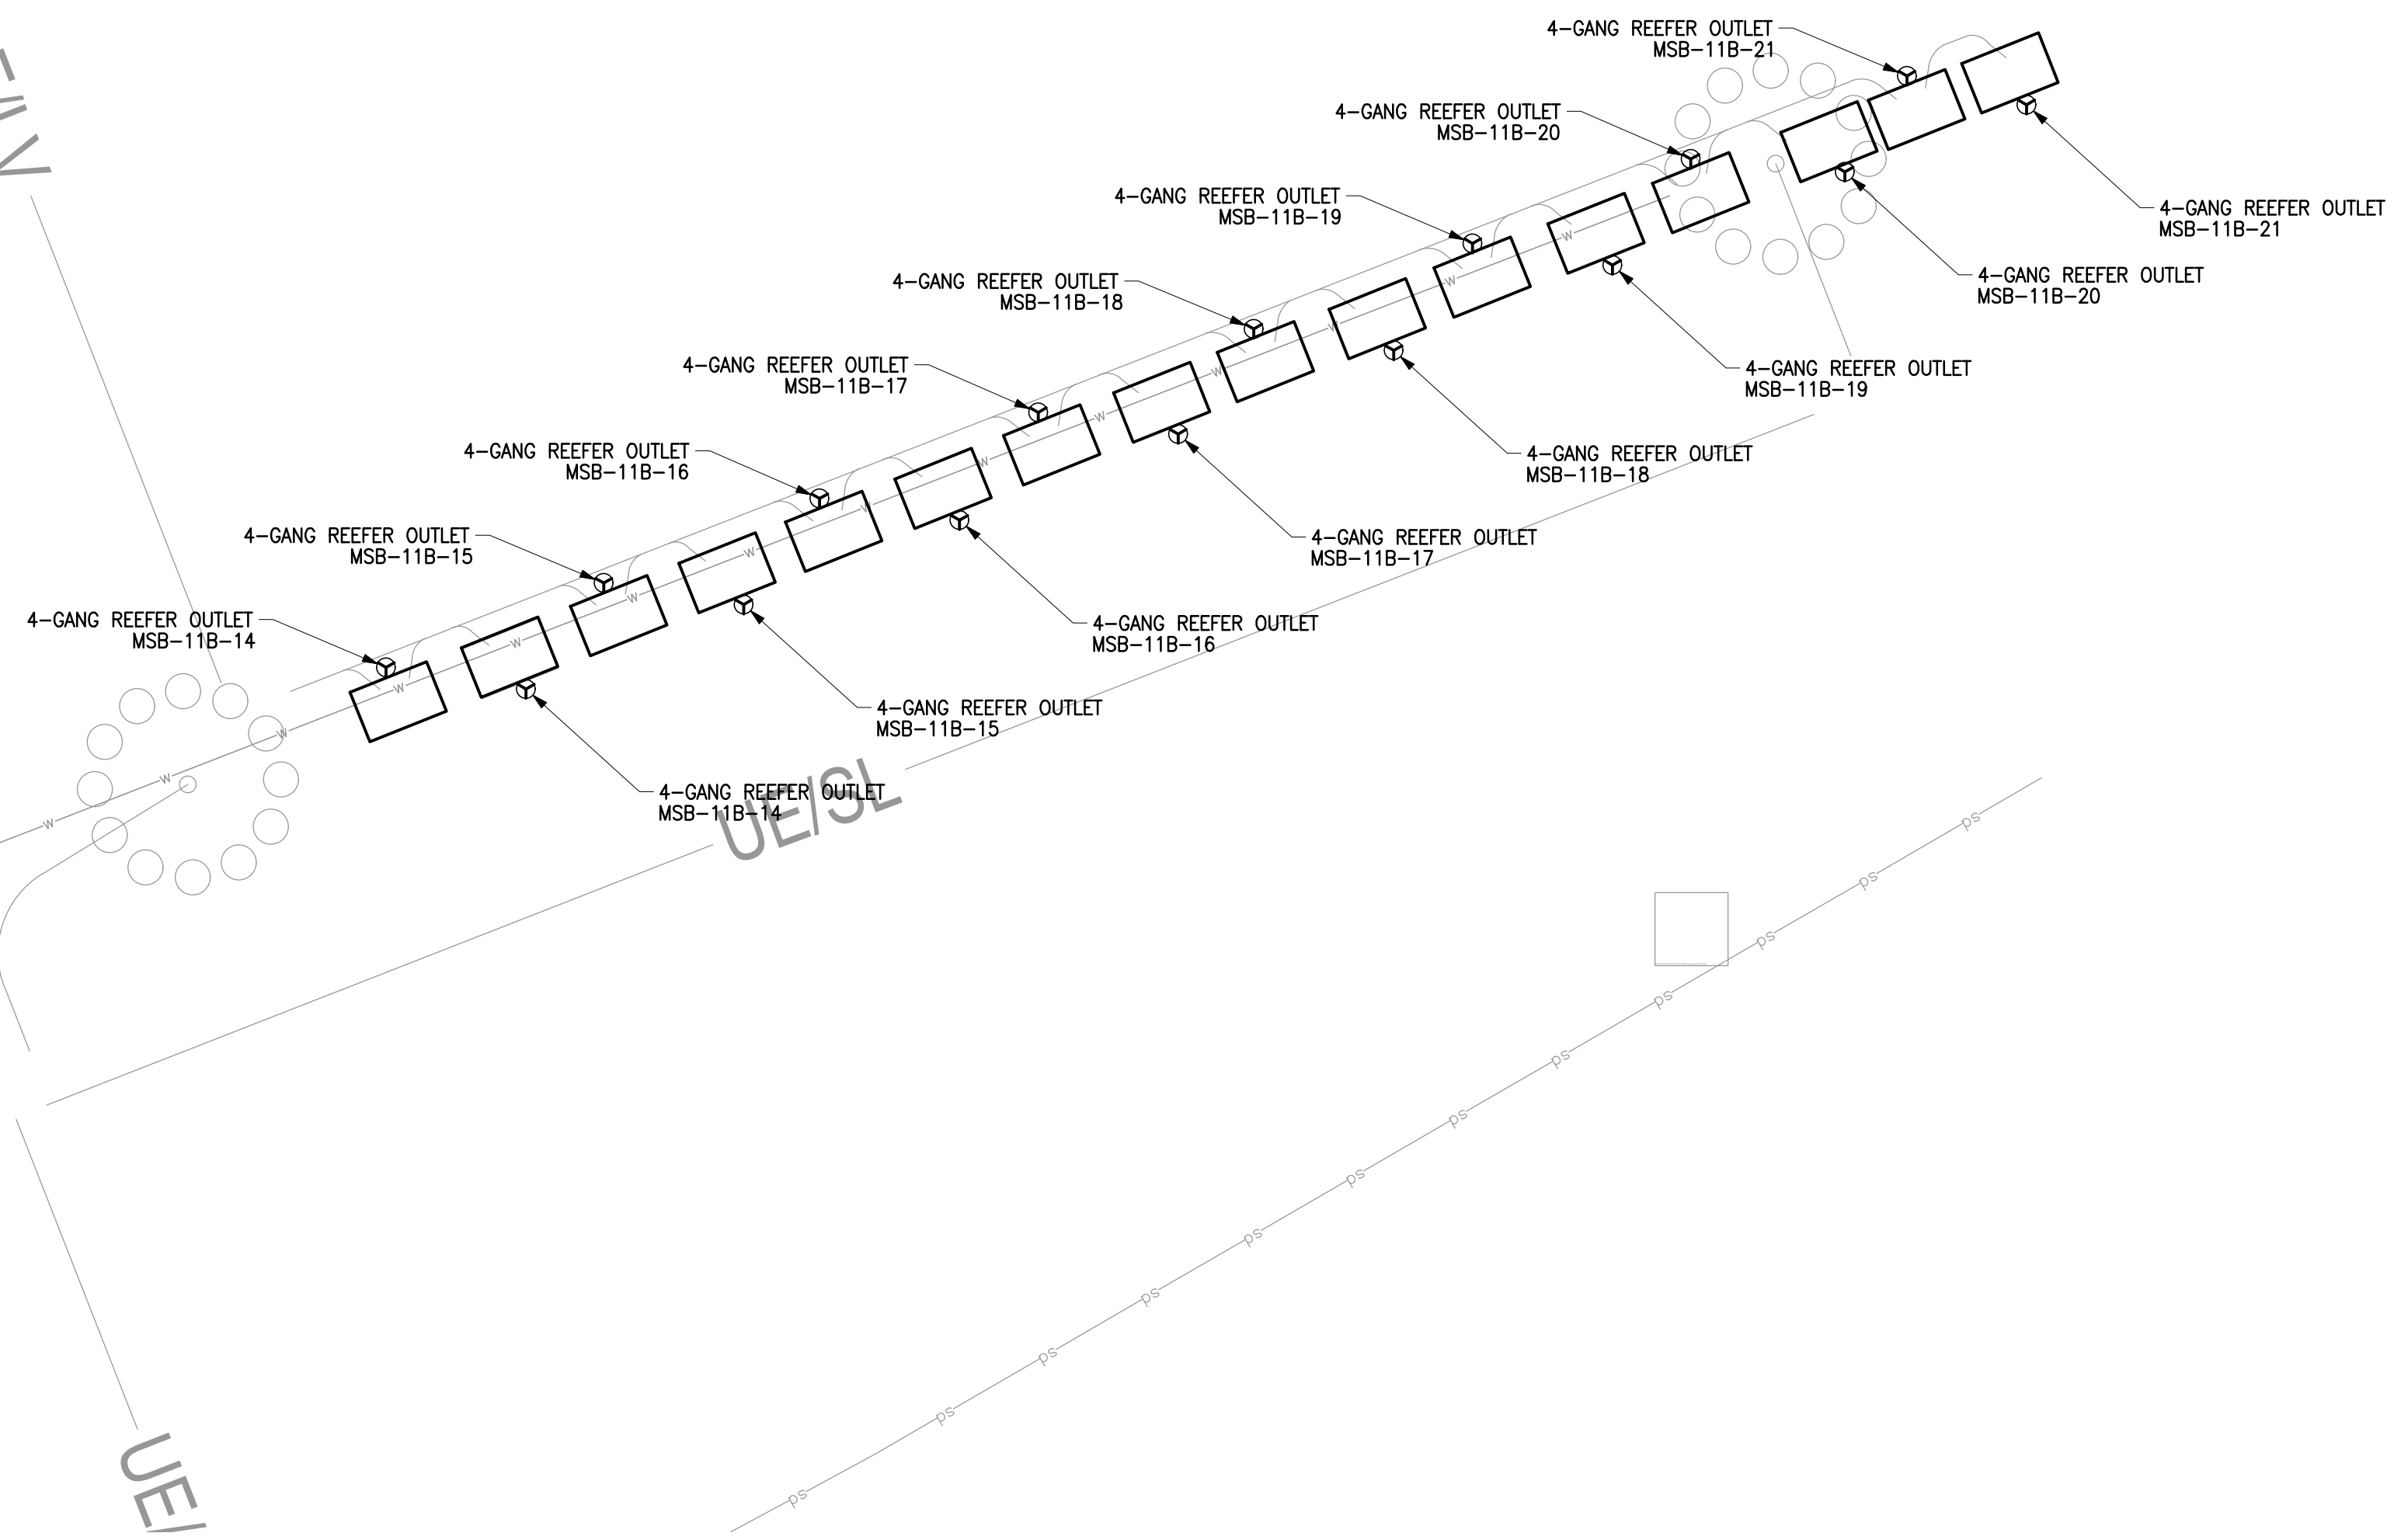
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1 ENLARGED ELECTRICAL POWER PLAN (REEFER OUTLETS RR6N)
 SCALE: 1/16" = 1'-0"

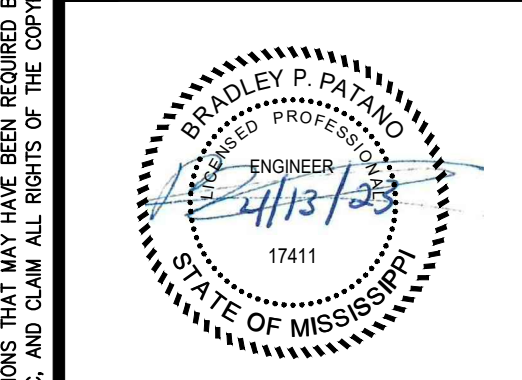
DRAWING E116 NOTES

1. ALL EXTERIOR CONDUIT ABOVE GRADE SHALL BE RIGID GALVANIZED STEEL.
2. ALL REEFER OUTLET ASSEMBLIES ARE OWNER FURNISHED EQUIPMENT. SEE SHEET E002 FOR DETAILS.



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ELEVATED REEFER PLUGS
PORT OF GULFPORT MISSISSIPPI
STATE PORT AUTHORITY
 30TH AVENUE
 GULFPORT, MS 39501

SCALE: AS INDICATED
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ENLARGED ELECTRICAL POWER PLAN

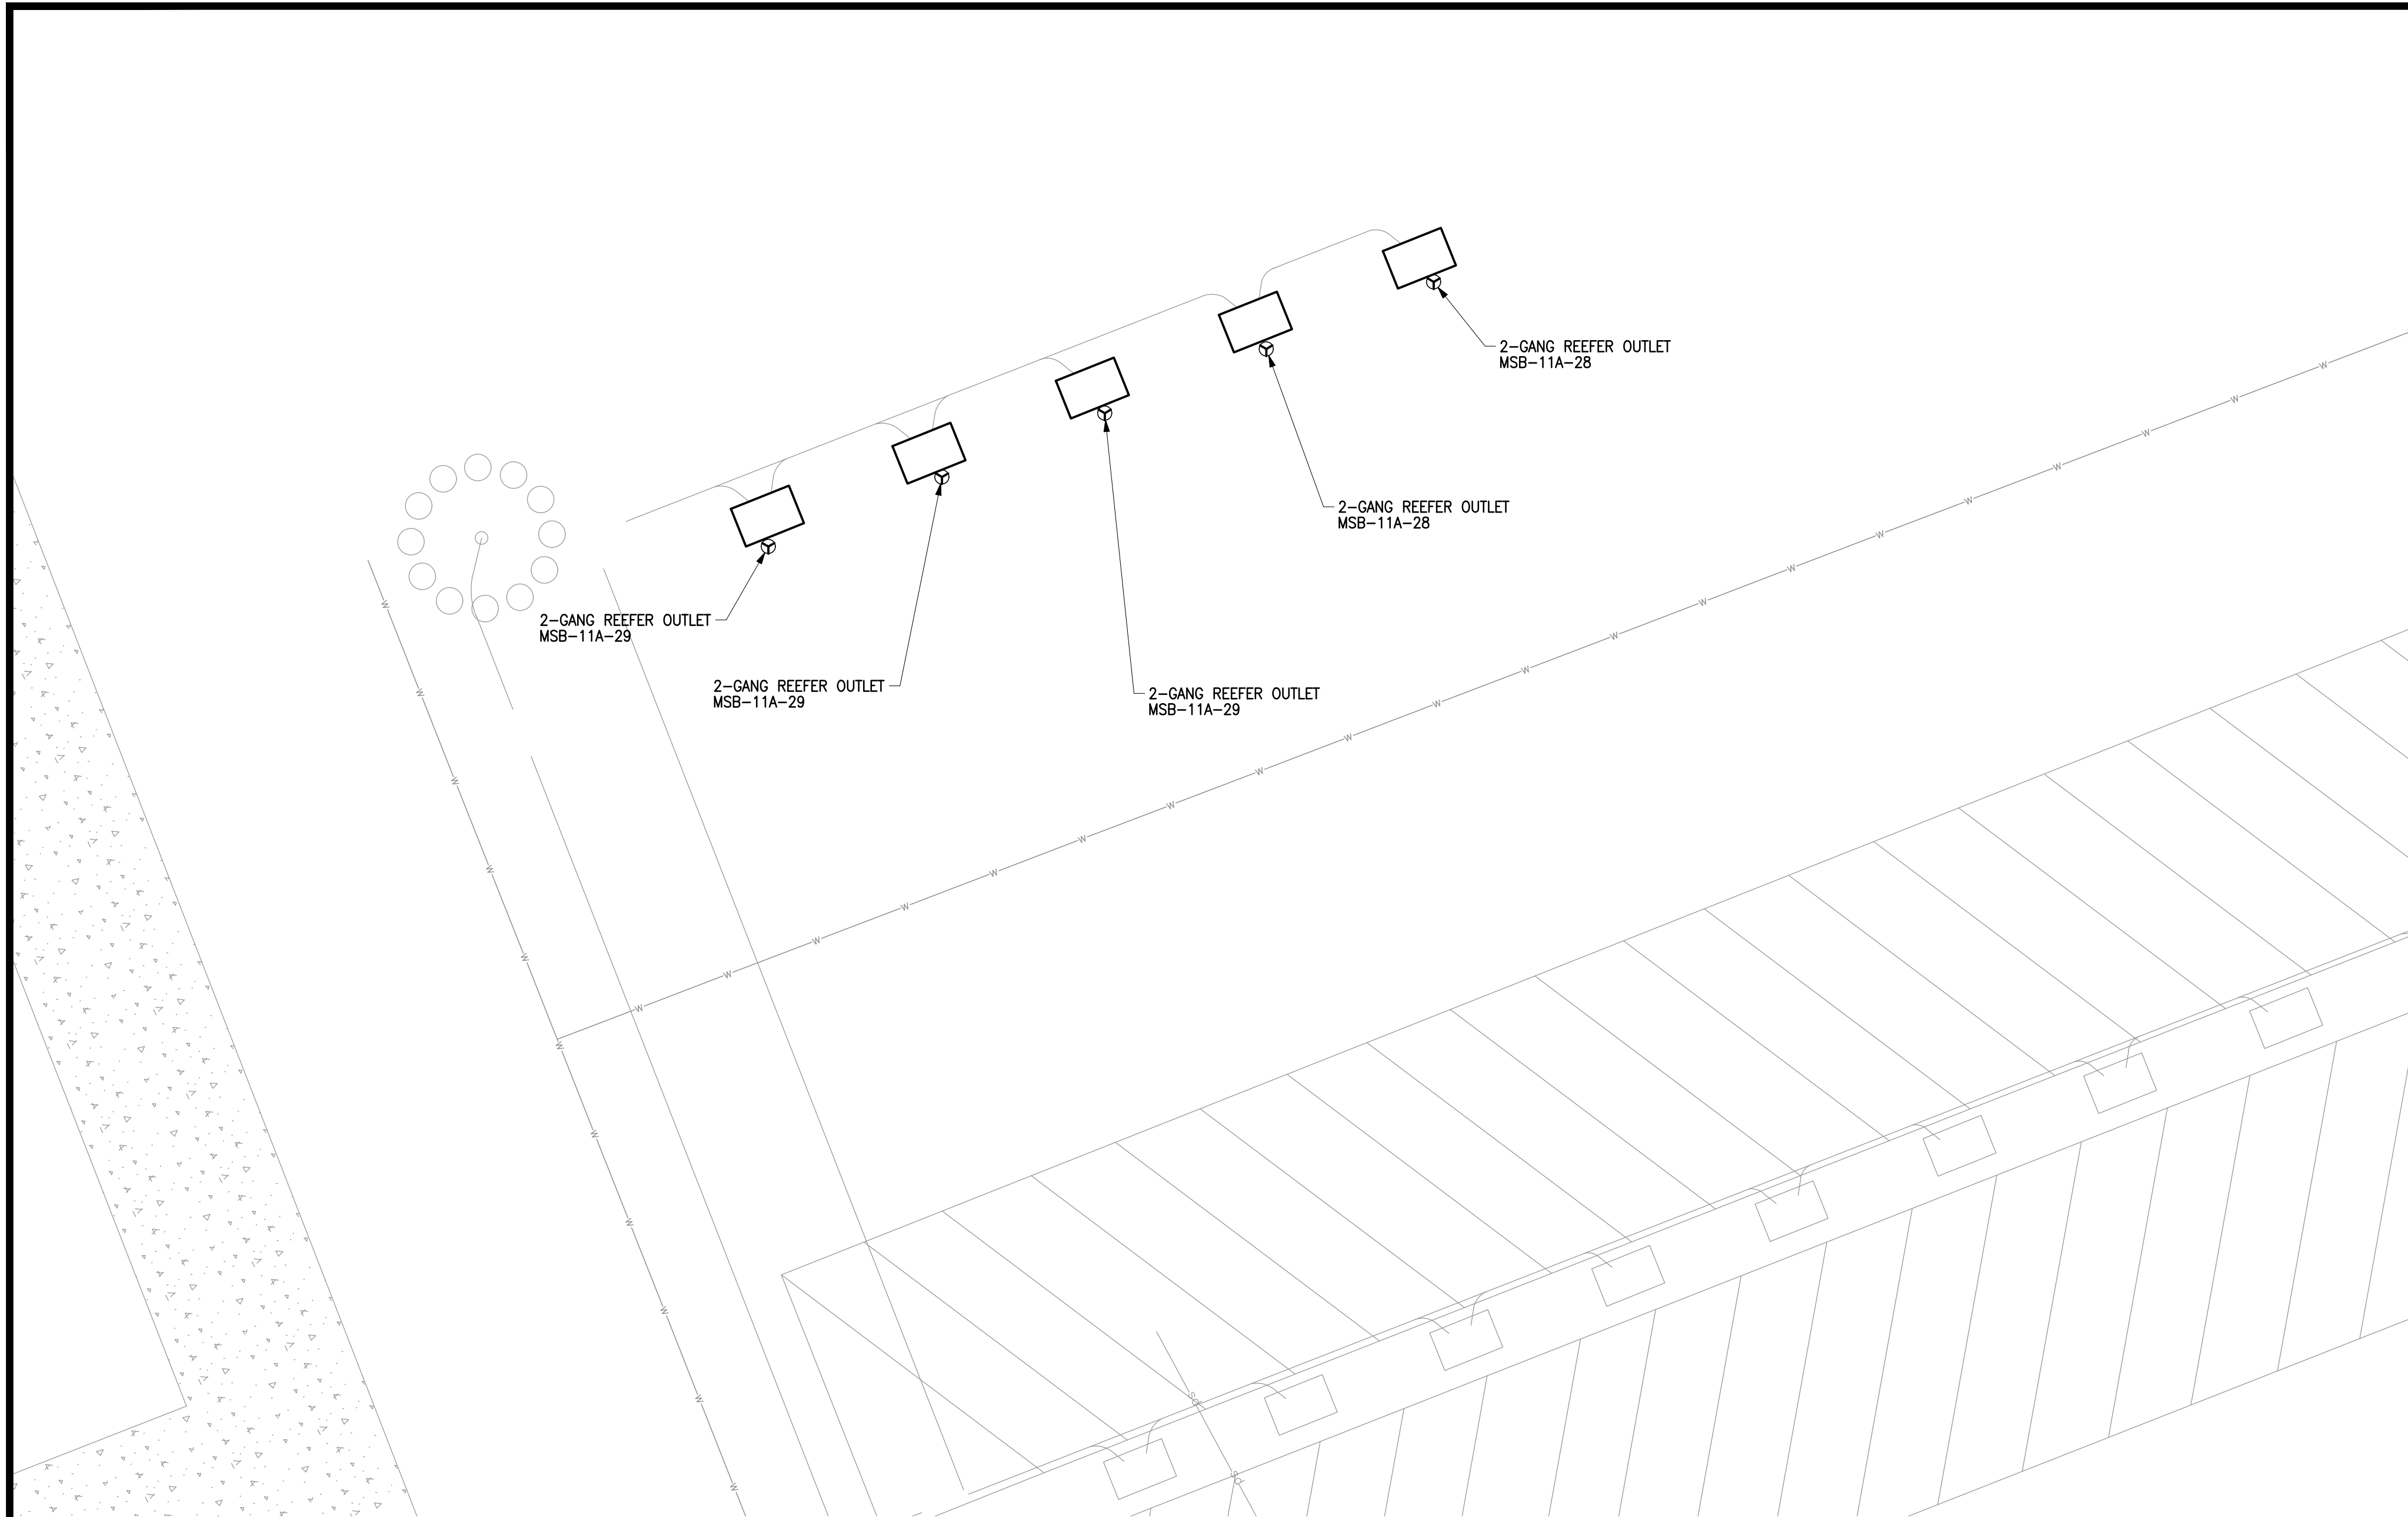
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E116

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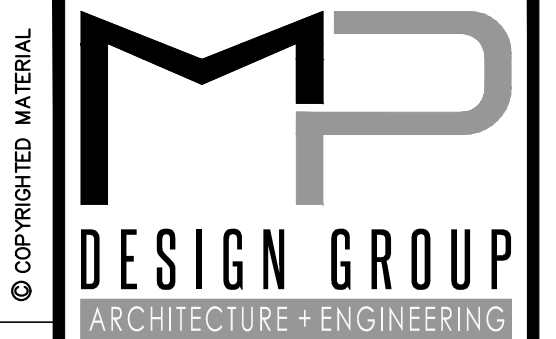
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1 ENLARGED ELECTRICAL POWER PLAN (REEFER OUTLETS RR0N)
 SCALE: 1/16" = 1'-0"

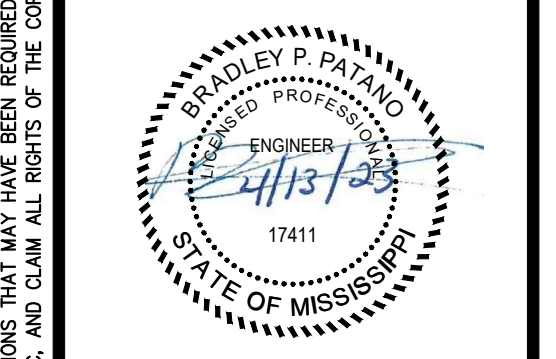
DRAWING E117 NOTES

1. ALL EXTERIOR CONDUIT ABOVE GRADE SHALL BE RIGID GALVANIZED STEEL.
2. ALL REEFER OUTLET ASSEMBLIES ARE OWNER FURNISHED EQUIPMENT. SEE SHEET E002 FOR DETAILS.



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ELEVATED REEFER PLUGS
PORT OF GULFPORT MISSISSIPPI
STATE PORT AUTHORITY
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SCALE: AS INDICATED
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ENLARGED ELECTRICAL POWER PLAN

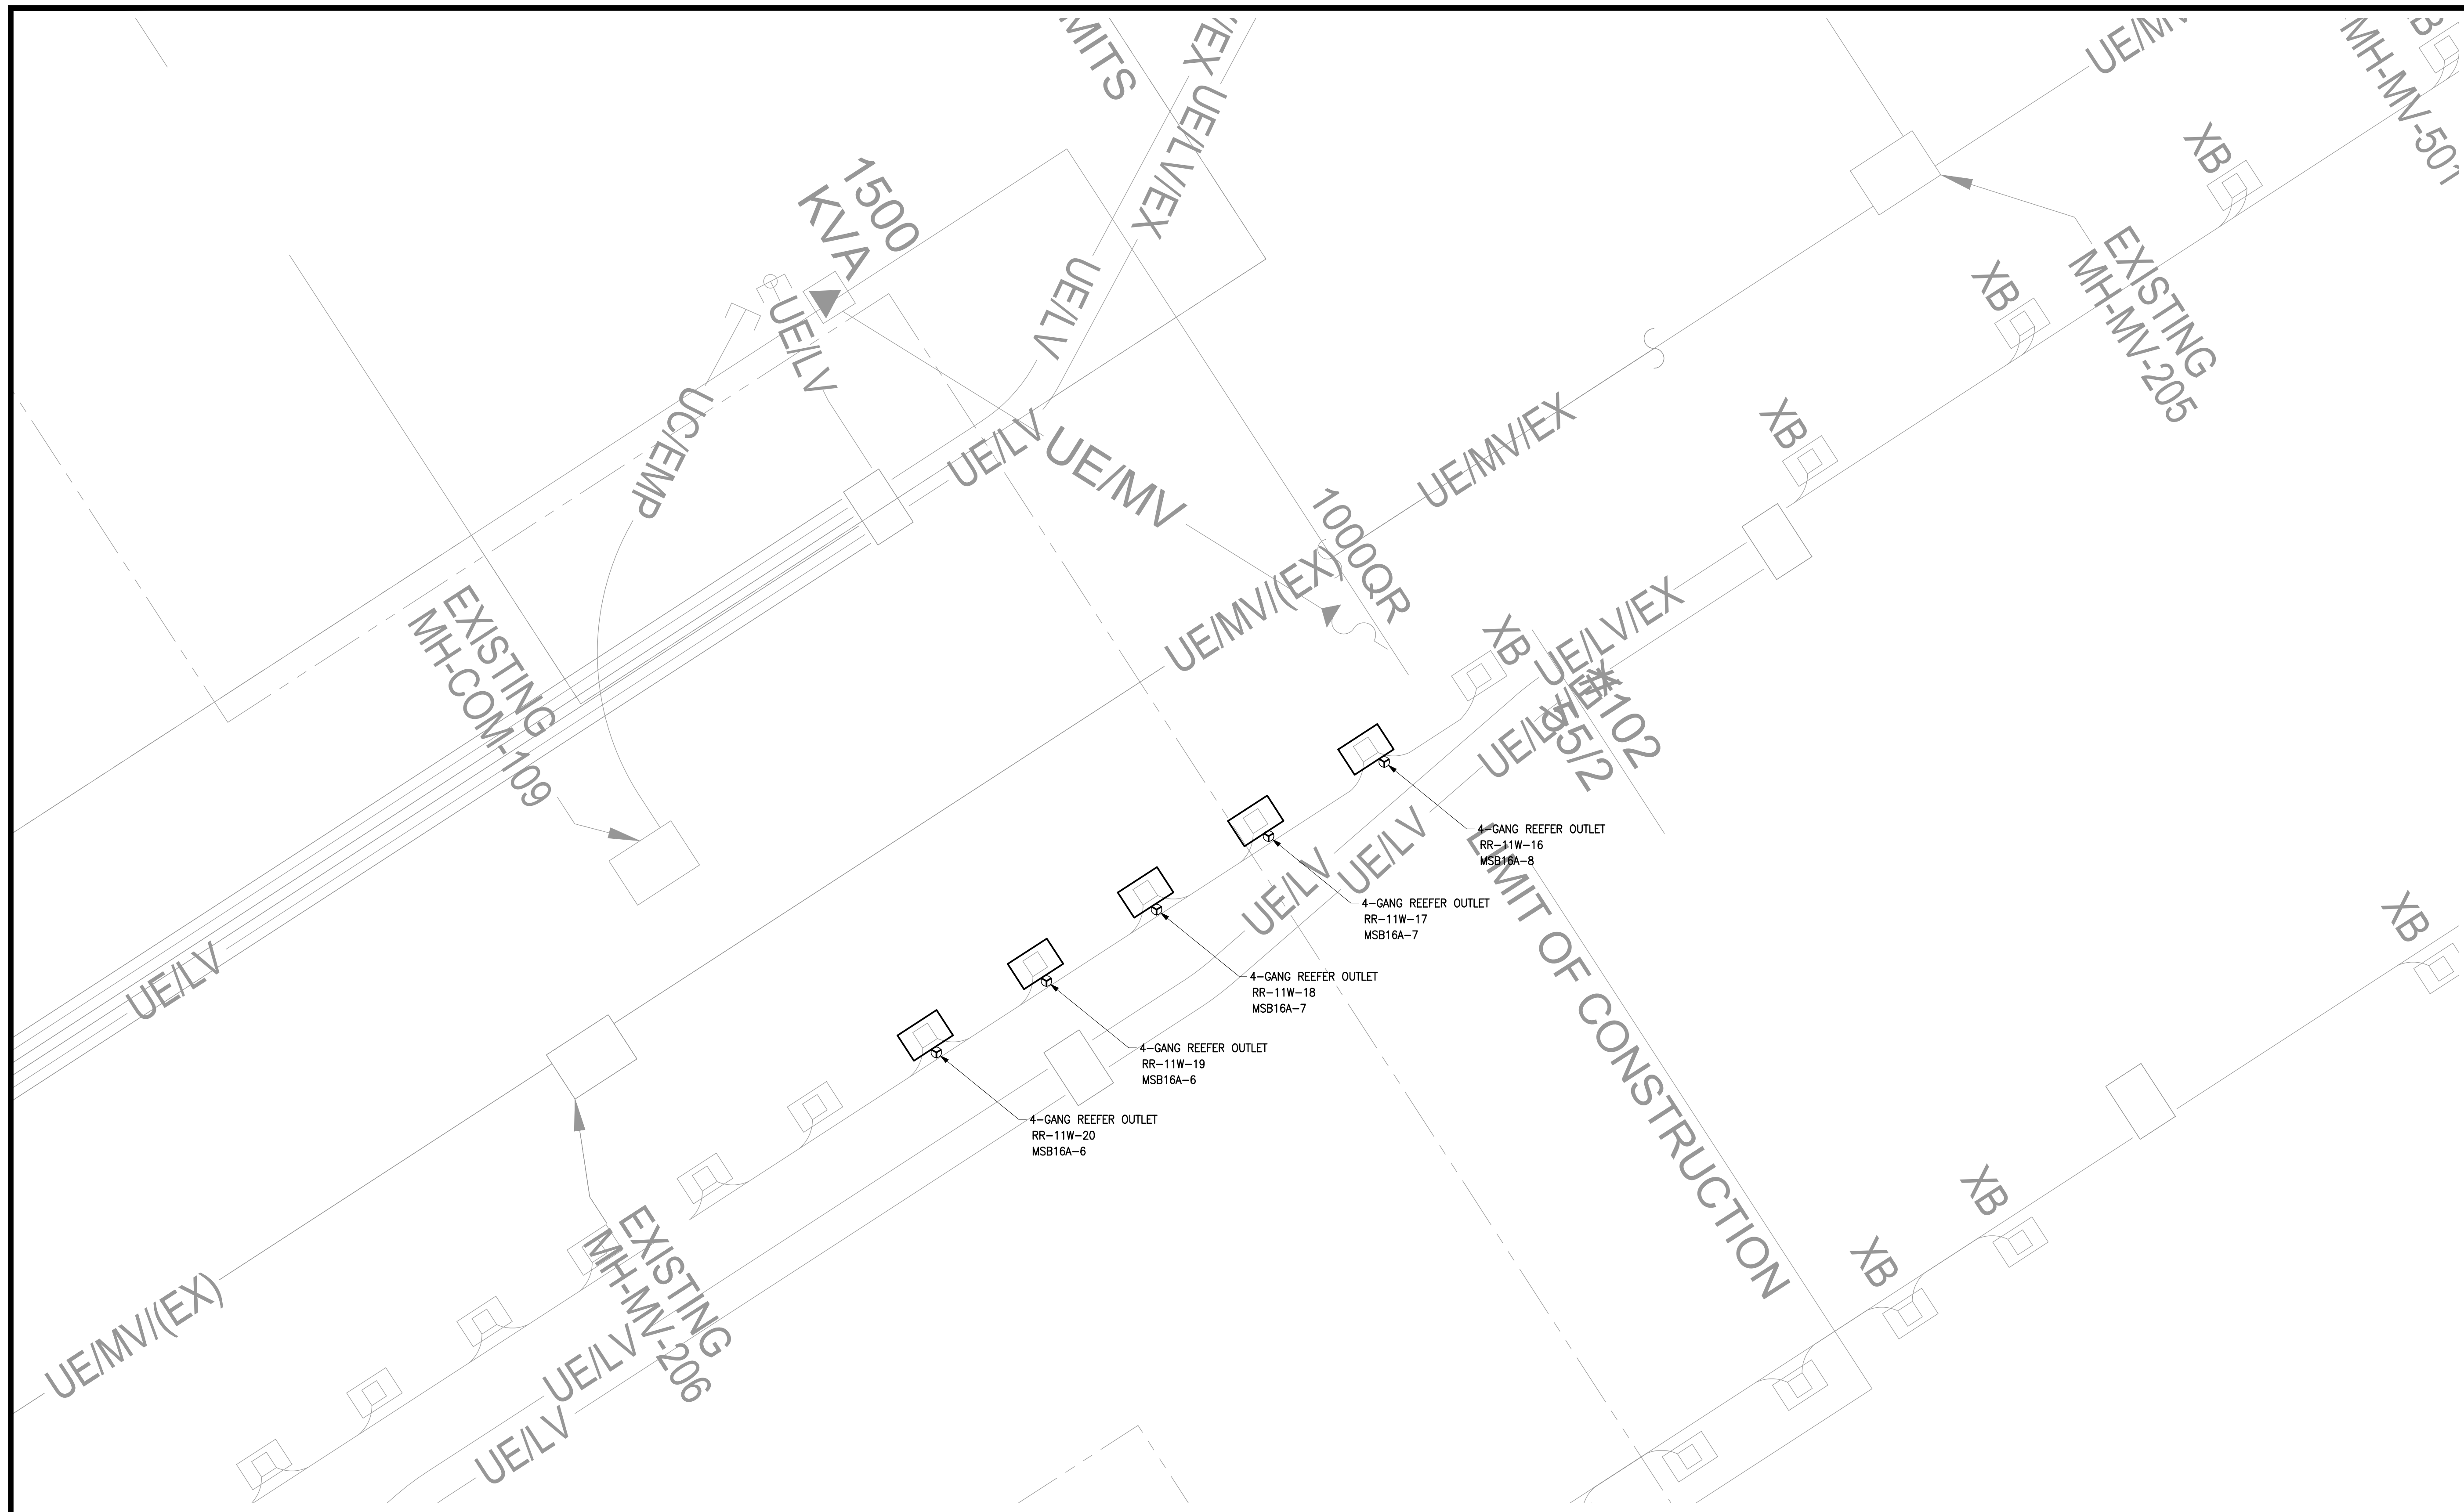
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1	ISSUED FOR CONSTRUCTION	4/13/2023	

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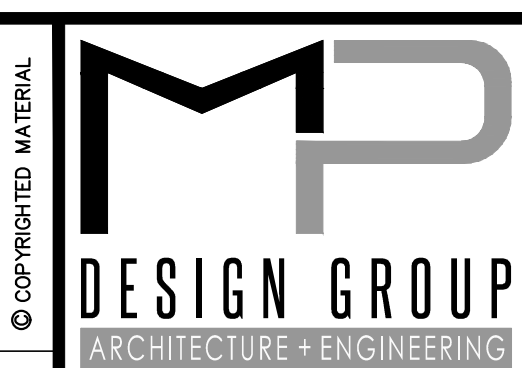
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1 ENLARGED ELECTRICAL POWER PLAN (REEFER OUTLETS RR10W, RR11W AND RR12W)
 SCALE: 1/16" = 1'-0"

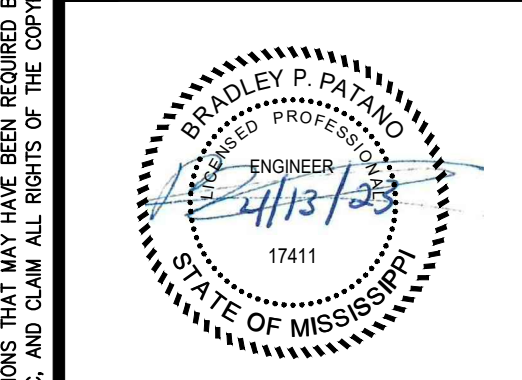
DRAWING E116 NOTES

1. ALL EXTERIOR CONDUIT ABOVE GRADE SHALL BE RIGID GALVANIZED STEEL.
2. ALL REEFER OUTLET ASSEMBLIES ARE OWNER FURNISHED EQUIPMENT. SEE SHEET E002 FOR DETAILS.



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ELEVATED REEFER PLUGS
PORT OF GULFPORT MISSISSIPPI
STATE PORT AUTHORITY
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 GULFPORT, MS 39501

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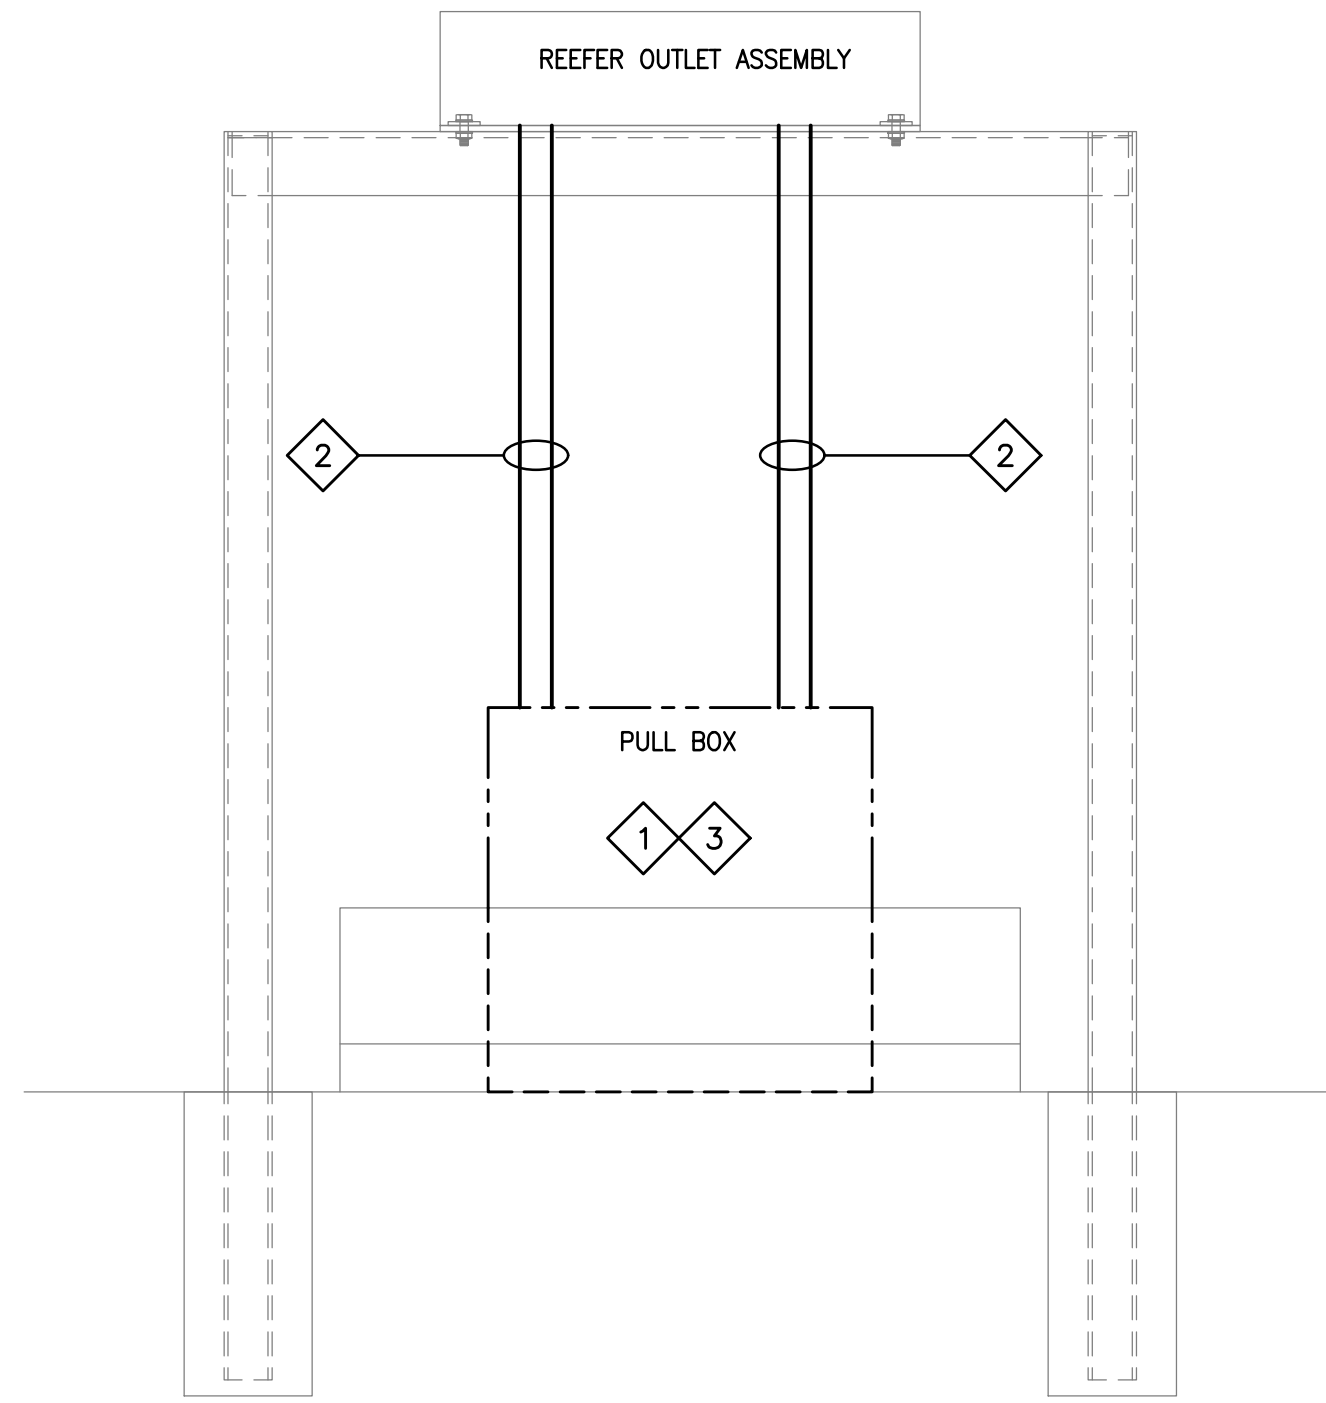
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E118

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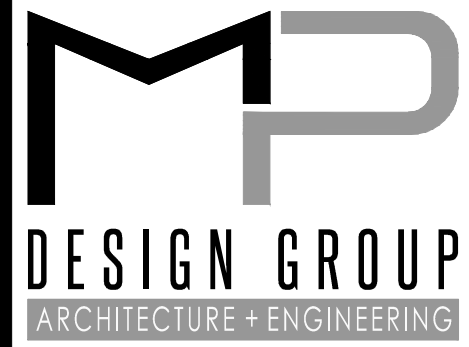
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1 REEFER OUTLET PEDESTAL ELECTRICAL DETAILS - BASE BID
 SCALE: 1" = 1'-0"

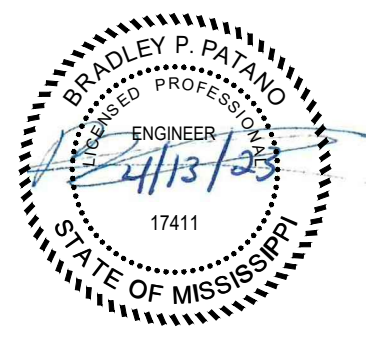
DRAWING E501 SPECIFIC NOTES

- 1** NEMA 4X STAINLESS STEEL PULL BOX. 30"H X 30"L X 16"W. PULL BOX SHALL BE LOCATED SO THAT IT IS SITUATED OVER EXISTING CONDUITS PROTRUDING FROM THE GROUND. SEE CIVIL DRAWINGS FOR MOUNTING DETAILS.
- 2** 2" RIGID GALVANIZED STEEL CONDUIT. CONTRACTOR SHALL USE MYER HUBS AT BOTH ENDS FOR TERMINATION INTO ENCLOSURES.
- 3** CONTRACTOR SHALL SPLICE EXISTING CABLE. CONTRACTOR SHALL USE WATERTIGHT CONNECTIONS. CONTRACTOR SHALL PROVIDE AND INSTALL 3-#3/0 AWG + 1-#4 AWG (G) XHHW-2 TYPE TC CONDUCTOR FROM NEW PULL BOX TO NEW ELEVATED REEFER OUTLET ASSEMBLY. SPLICES SHALL BE MADE WATERTIGHT.



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ELEVATED REEFER PLUGS
PORT OF GULFPORT MISSISSIPPI
STATE PORT AUTHORITY
 30TH AVENUE
 GULFPORT, MS 39501

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ELECTRICAL GENERAL DETAILS

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E501

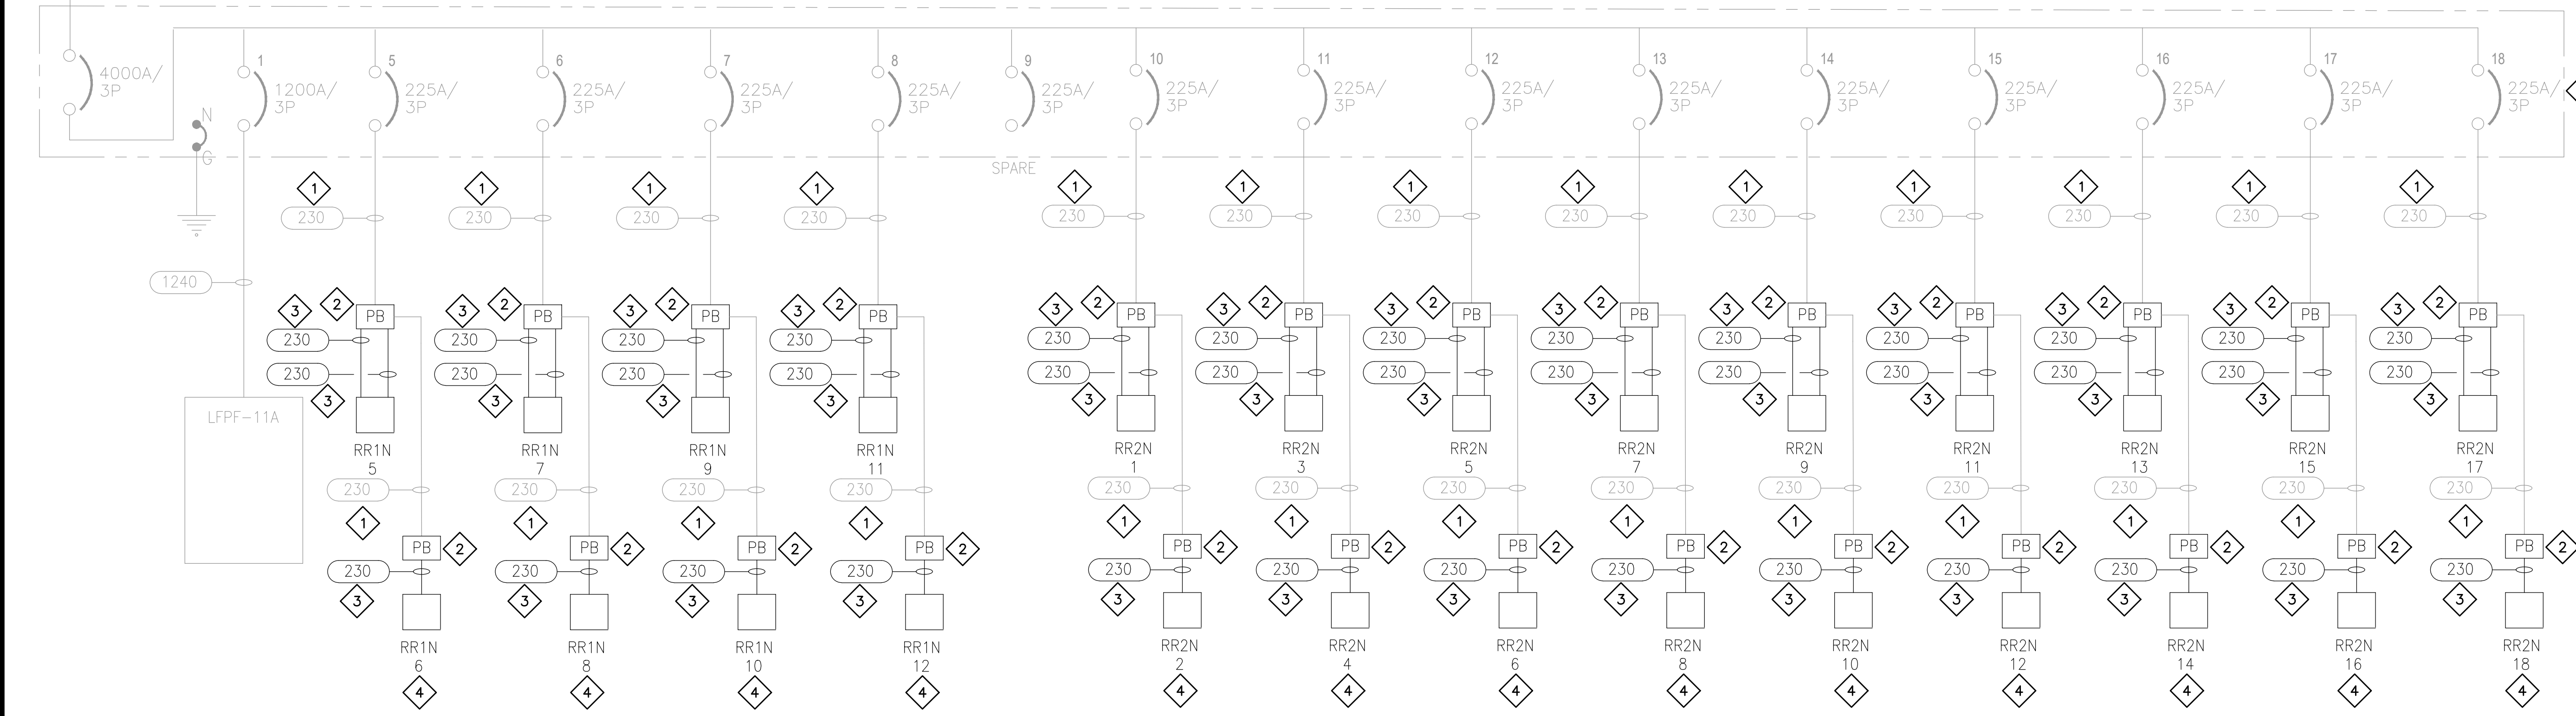
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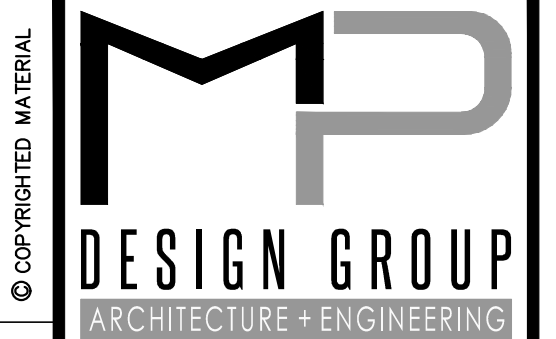
TO
UTILITY
TRANSFORMERS

4180N
 MSB-11A (SECTION 1 & SECTION 2 PARTIAL)
 480/277V, 3Ø, 4W,
 4,000A MCB, 65,000 AIC, NEMA 3R
 LOCATION: PLATFORM 11, TOTAL CONNECTED LOAD = UNKNOWN

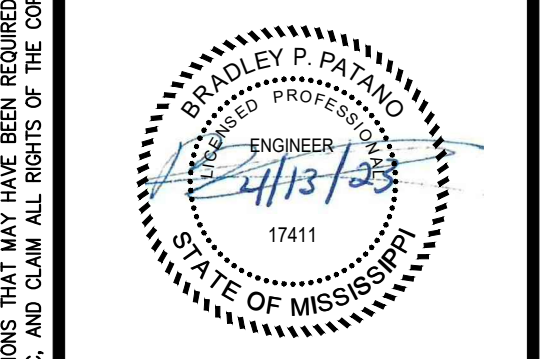


DRAWING E601 SPECIFIC NOTES

- 1 EXISTING FEEDER TO REMAIN AS-IS.
- 2 CONTRACTOR SHALL PROVIDE AND INSTALL PULLBOX/SPLICE BOX. SEE SHEET E501 FOR DETAILS.
- 3 CONTRACTOR SHALL EXTEND FEEDER TO NEW ELEVATED REEFER OUTLET. NEW CONDUCTOR SHALL BE ROUTED IN RGS CONDUIT. SPLICES SHALL BE MADE WATER-TIGHT. SEE SHEET E501 FOR DETAILS.
- 4 NEW REEFER OUTLETS (PROVIDED BY OWNER, INSTALLED BY CONTRACTOR) SHALL BE ON ELEVATED PLATFORM. CONTRACTOR SHALL NOTE THAT MULTIPLE REEFER OUTLETS ARE ON A SINGLE CIRCUIT. SEE CIVIL/STRUCTURAL SHEETS FOR PLATFORM DETAILS. PLATFORMS SHALL BE PROVIDED AND INSTALLED BY CONTRACTOR.
- 5 CONTINUE ON SHEET E602.



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ELEVATED REEFER PLUGS
PORT OF GULFPORT MISSISSIPPI
STATE PORT AUTHORITY
 30TH AVENUE
 GULFPORT, MS 39501

SCALE: NOT TO SCALE
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ELECTRICAL ONE-LINE DIAGRAM

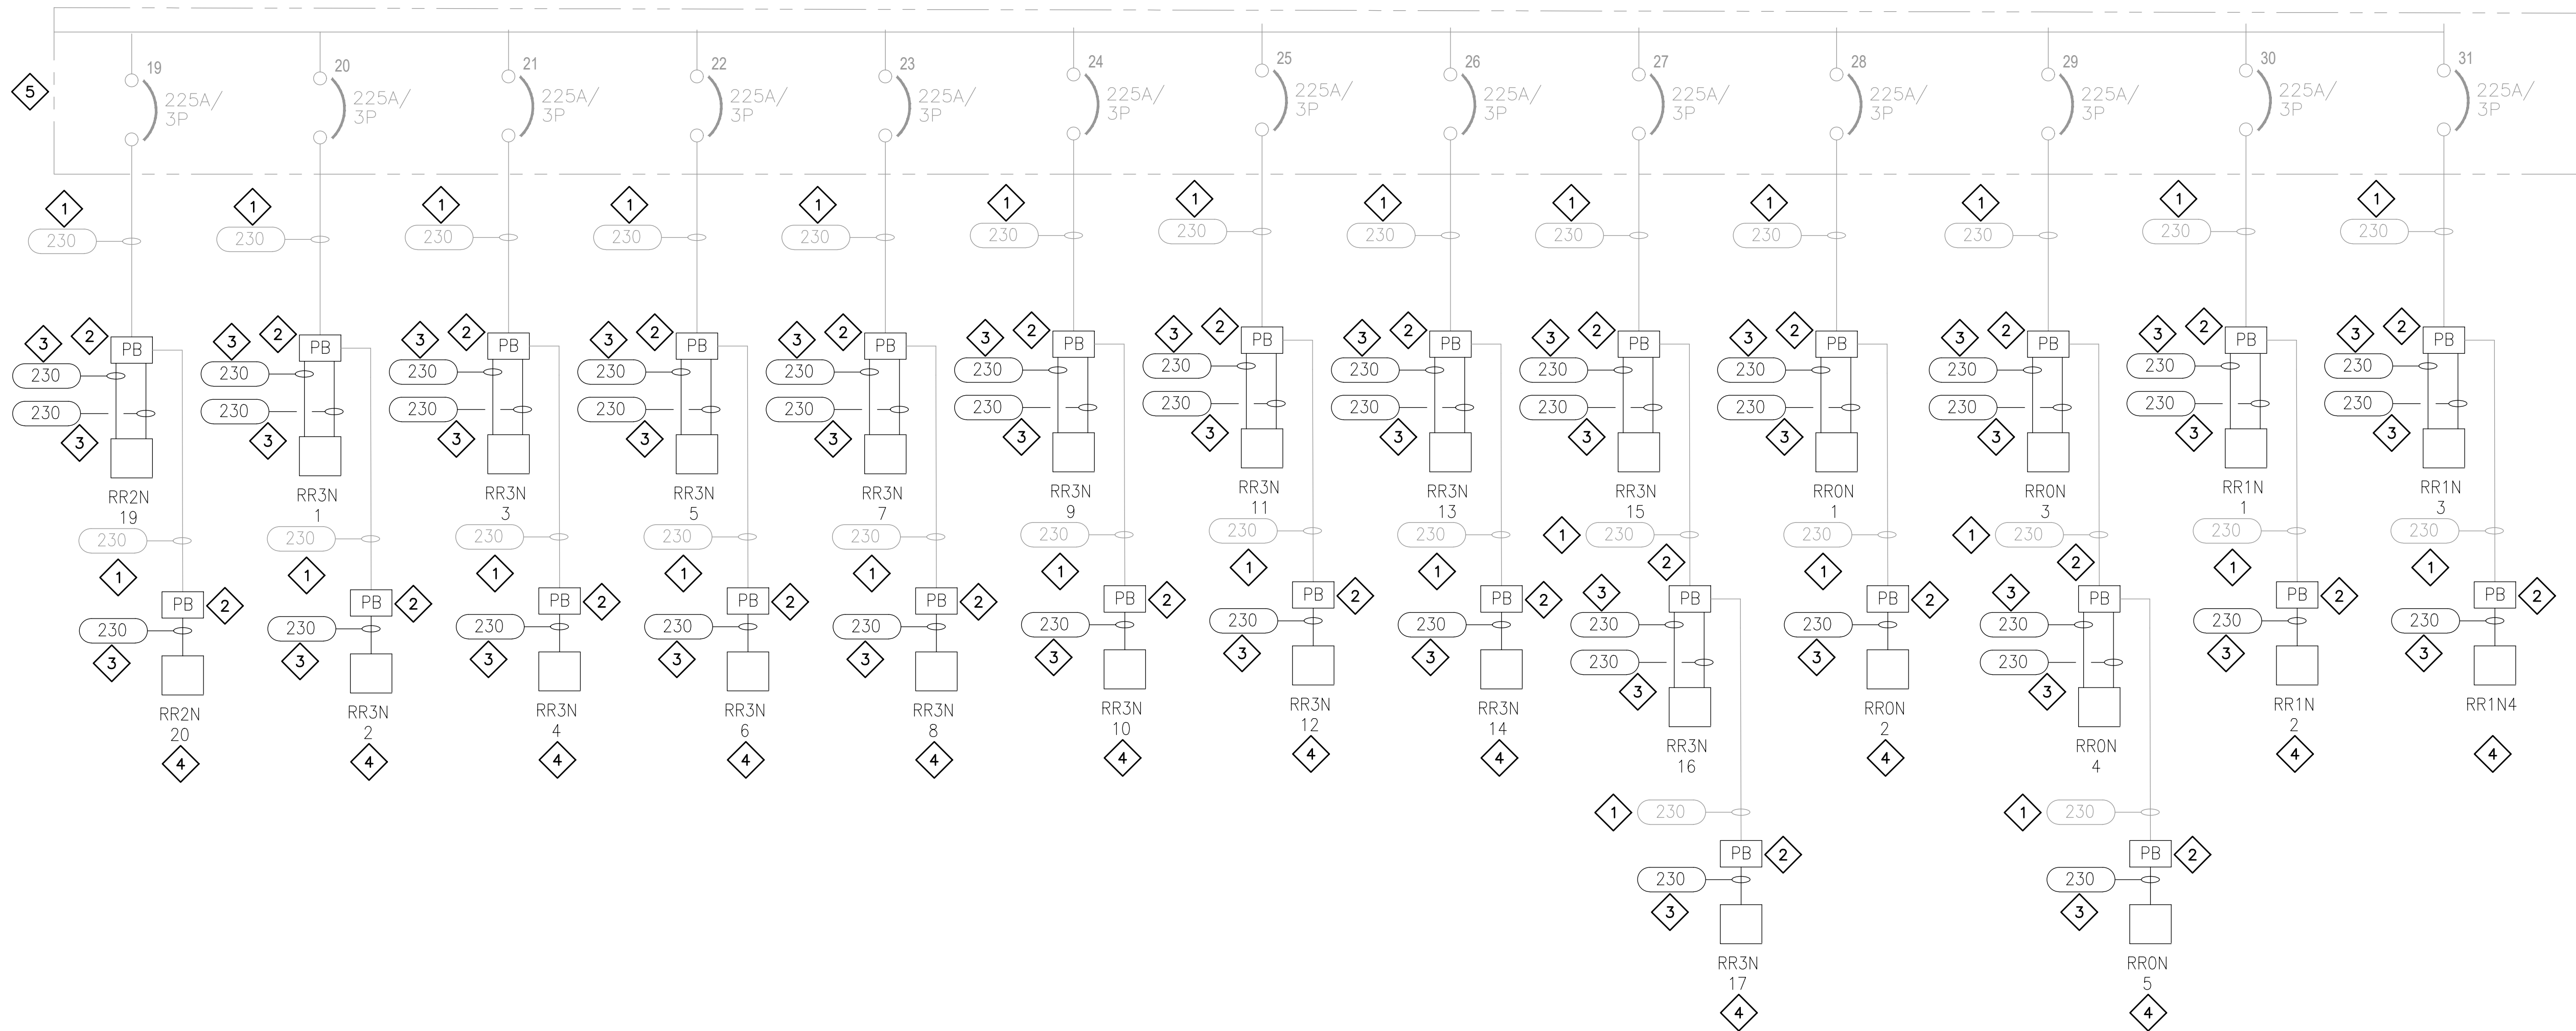
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E601
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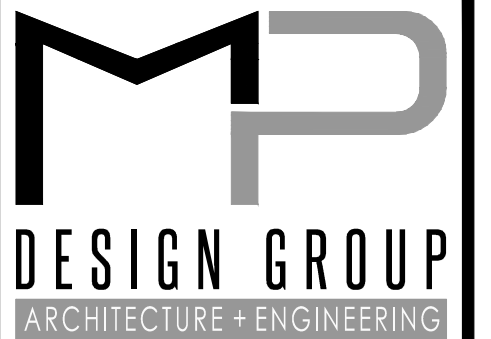
MSB-11A (SECTION 2 PARTIAL AND SECTION 3 PARTIAL)
 480/277V, 3Ø, 4W,
 4,000A MCB, 65,000 AIC, NEMA 3R
 LOCATION: PLATFORM 11, TOTAL CONNECTED LOAD = UNKNOWN



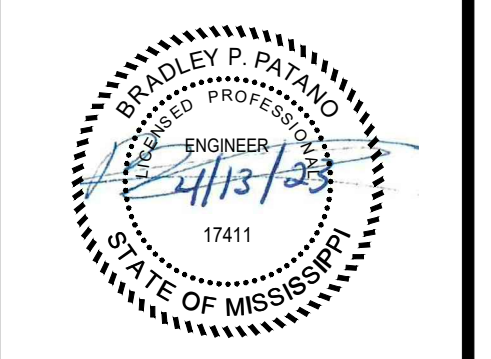
DRAWING E602 SPECIFIC NOTES

- 1 EXISTING FEEDER TO REMAIN AS-IS.
- 2 CONTRACTOR SHALL PROVIDE AND INSTALL PULLBOX/SPLICE BOX. SEE SHEET E501 FOR DETAILS.
- 3 CONTRACTOR SHALL EXTEND FEEDER TO NEW ELEVATED REEFER OUTLET. NEW CONDUCTOR SHALL BE ROUTED IN RGS CONDUIT. SPLICES SHALL BE MADE WATER-TIGHT. SEE SHEET E501 FOR DETAILS.
- 4 NEW REEFER OUTLETS (PROVIDED BY OWNER, INSTALLED BY CONTRACTOR) SHALL BE ON ELEVATED PLATFORM. CONTRACTOR SHALL NOTE THAT MULTIPLE REEFER OUTLETS ARE ON A SINGLE CIRCUIT. SEE CIVIL/STRUCTURAL SHEETS FOR PLATFORM DETAILS. PLATFORMS SHALL BE PROVIDED AND INSTALLED BY CONTRACTOR.
- 5 CONTINUE ON SHEET E601.

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ELEVATED REEFER PLUGS
PORT OF GULFPORT MISSISSIPPI
STATE PORT AUTHORITY
 30TH AVENUE
 GULFPORT, MS 39501

SCALE: NOT TO SCALE
 PROJECT NO: 0297.22.002
 DRAWN BY: KDB
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ELECTRICAL ONE-LINE DIAGRAM

NO.	REV	DATE	REVISION / SUBMITTAL
1		4/13/2023	ISSUED FOR CONSTRUCTION

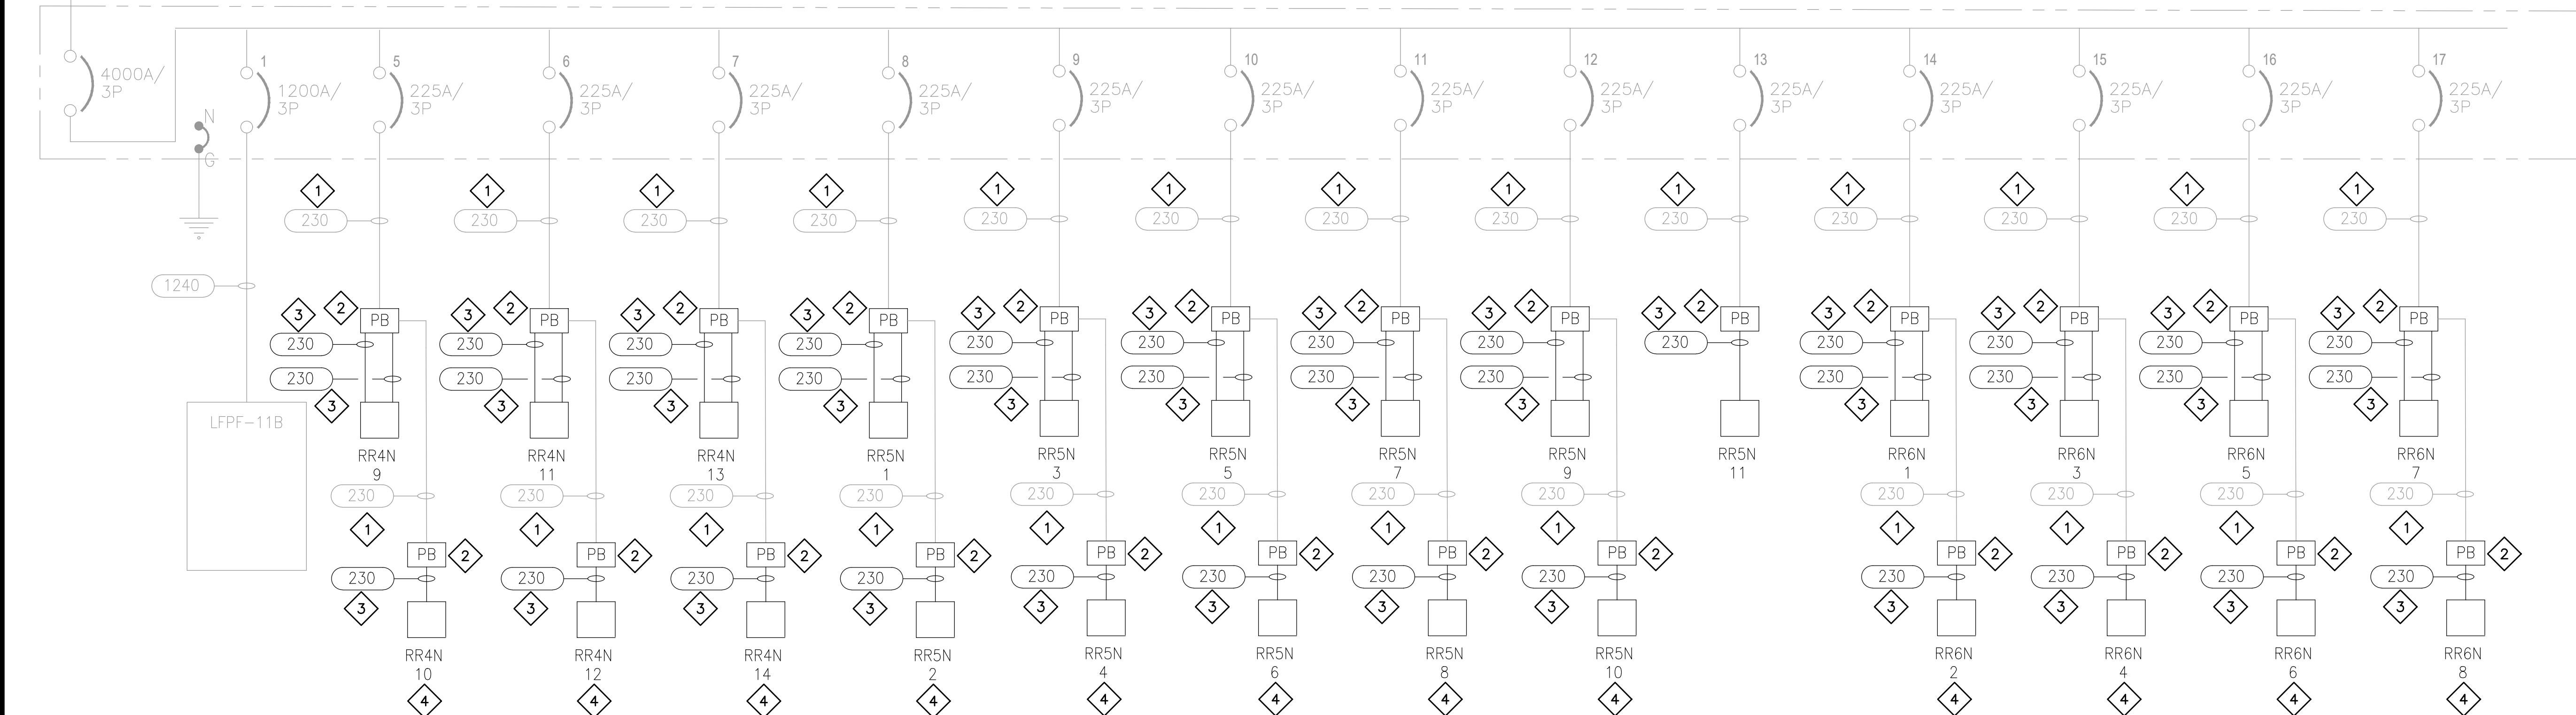
E602
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TO
UTILITY
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4180N

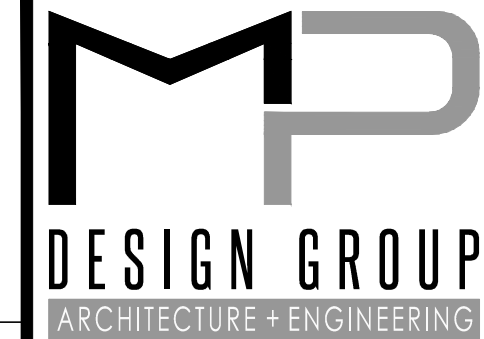
MSB-11B (SECTION 1 & SECTION 2 PARTIAL)
 480/277V, 3Ø, 4W,
 4,000A MCB, 65,000 AIC, NEMA 3R
 LOCATION: PLATFORM 11, TOTAL CONNECTED LOAD = UNKNOWN



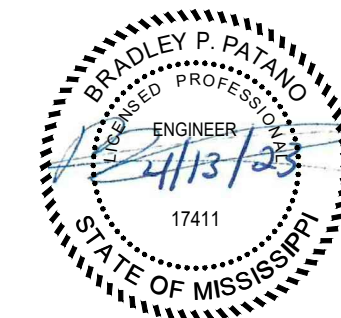
DRAWING E603 SPECIFIC NOTES

- 1 EXISTING FEEDER TO REMAIN AS-IS.
- 2 CONTRACTOR SHALL PROVIDE AND INSTALL PULLBOX/SPLICE BOX. SEE SHEET E501 FOR DETAILS.
- 3 CONTRACTOR SHALL EXTEND FEEDER TO NEW ELEVATED REEFER OUTLET. NEW CONDUCTOR SHALL BE ROUTED IN RGS CONDUIT. SPLICES SHALL BE MADE WATER-TIGHT. SEE SHEET E501 FOR DETAILS.
- 4 NEW REEFER OUTLETS (PROVIDED BY OWNER, INSTALLED BY CONTRACTOR) SHALL BE ON ELEVATED PLATFORM. CONTRACTOR SHALL NOTE THAT MULTIPLE REEFER OUTLETS ARE ON A SINGLE CIRCUIT. SEE CIVIL/STRUCTURAL SHEETS FOR PLATFORM DETAILS. PLATFORMS SHALL BE PROVIDED AND INSTALLED BY CONTRACTOR.
- 5 CONTINUE ON SHEET E604.

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 Bradford A. Jones, AIA
 Fernanda A. Silva, AIA



ELEVATED REEFER PLUGS
 PORT OF GULFPORT MISSISSIPPI
 STATE PORT AUTHORITY
 30TH AVENUE
 GULFPORT, MS 39501

SCALE: NOT TO SCALE
 PROJECT NO: 0297.22.002
 DRAWN BY: KDB
 CHECKED BY: KDB

ELECTRICAL ONE-LINE DIAGRAM

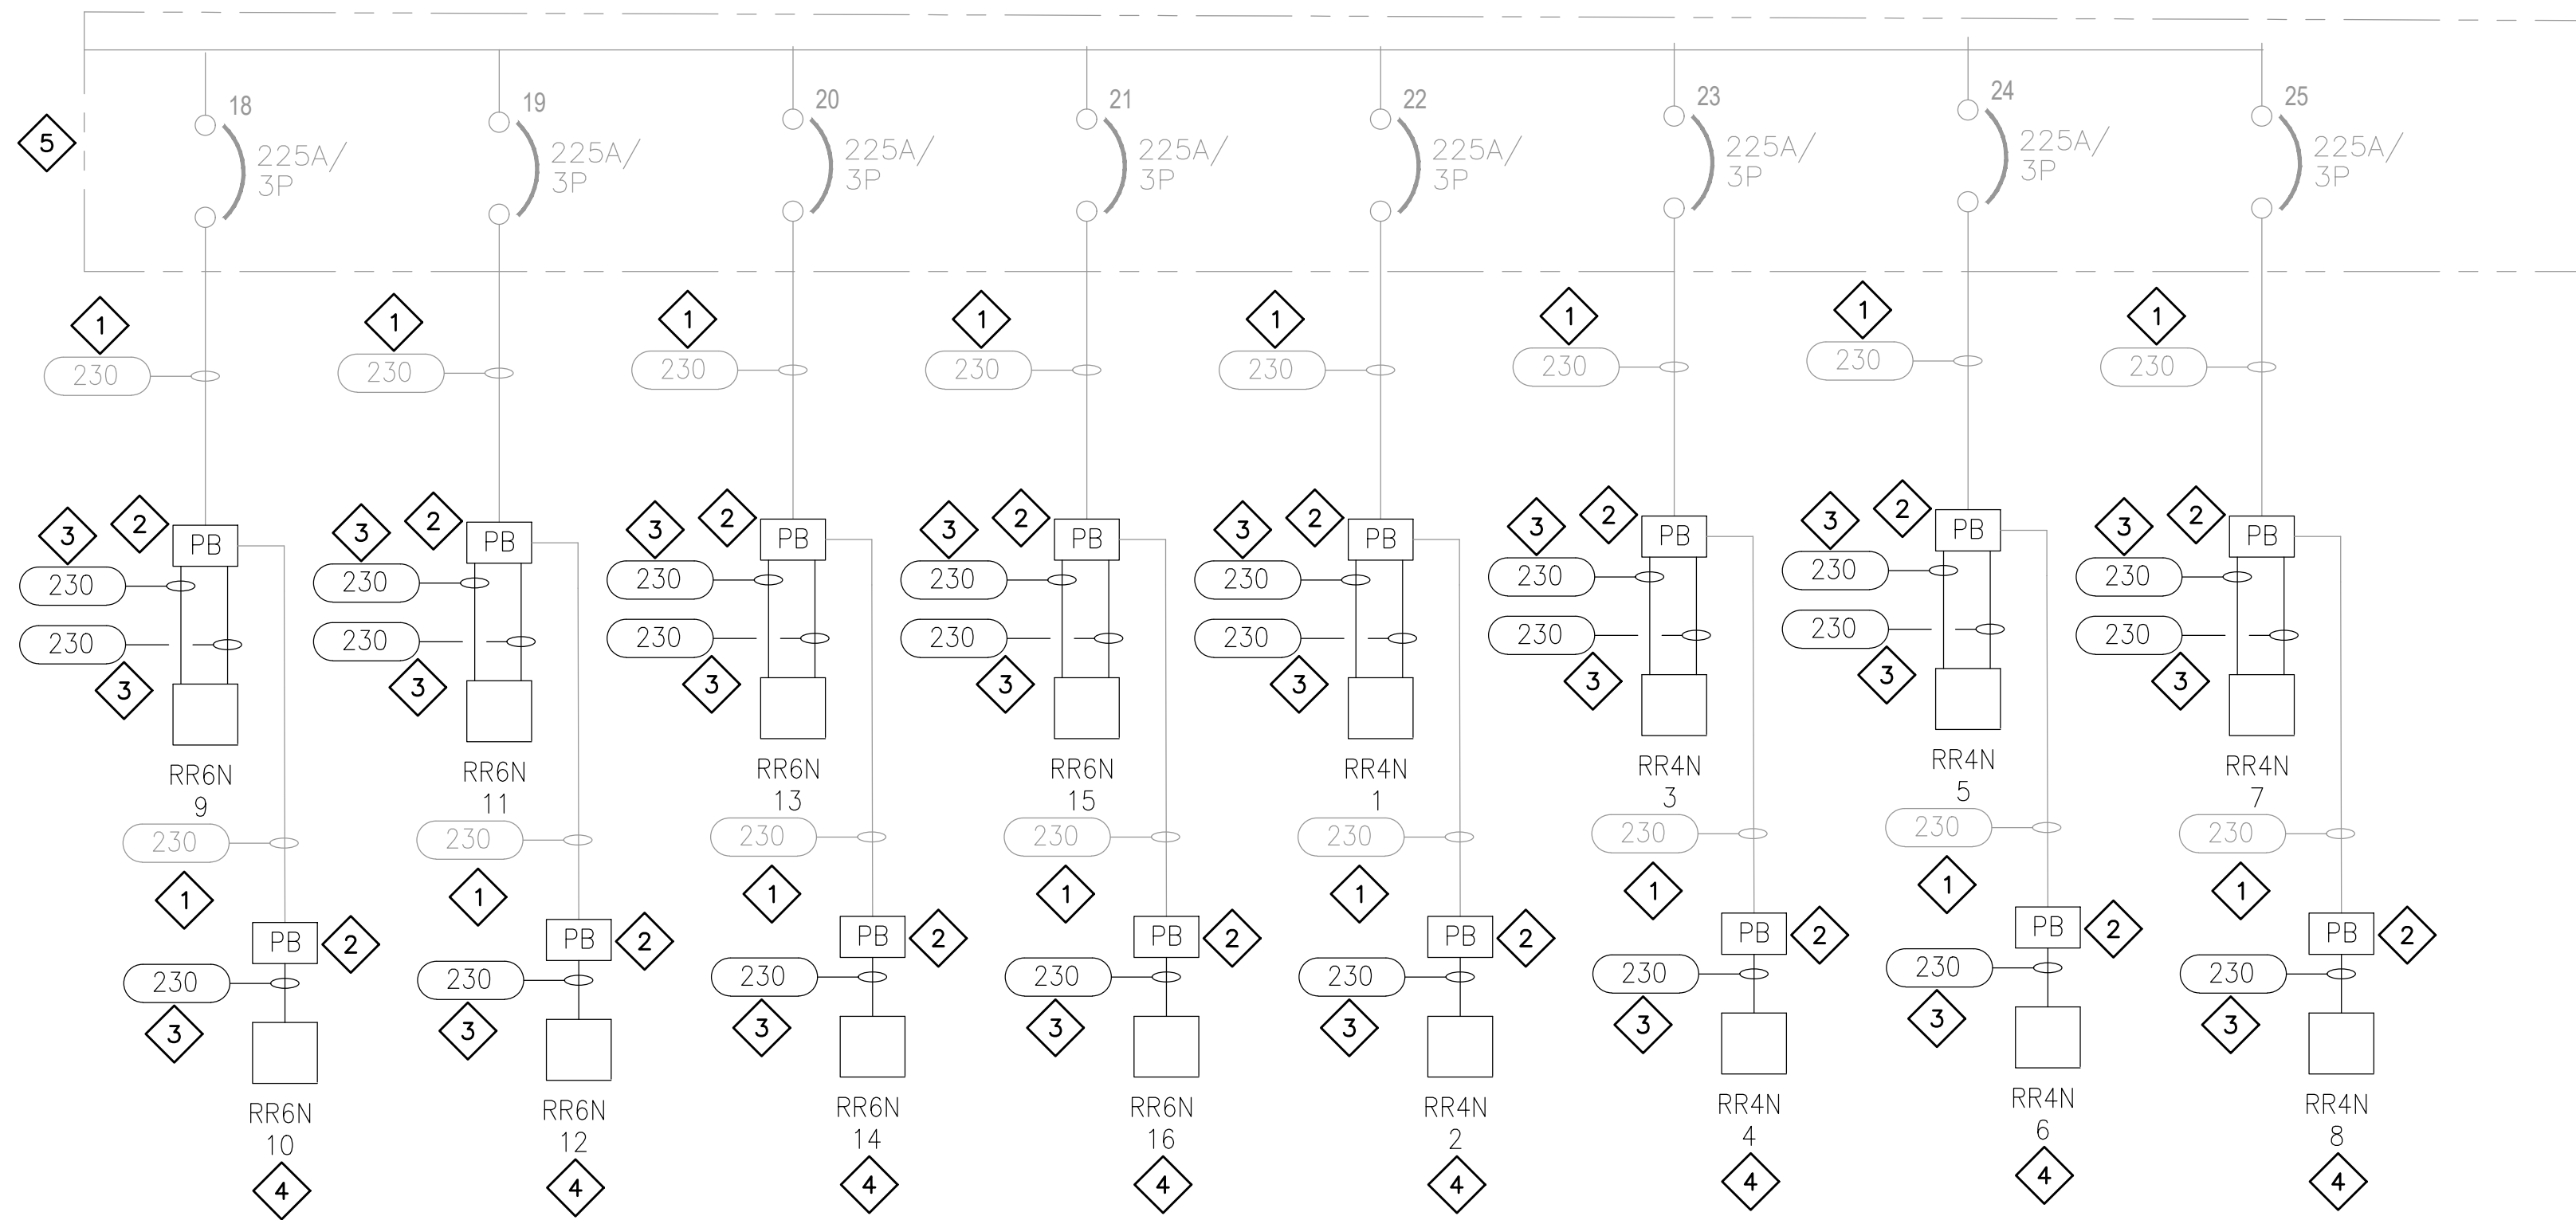
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E603

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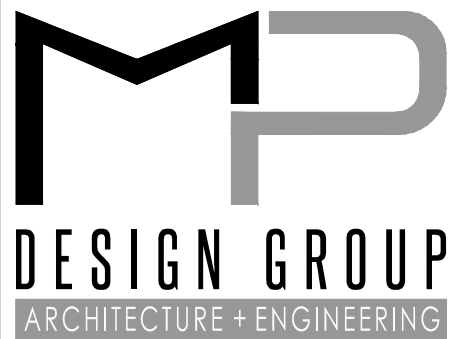
MSB-11B (SECTION 2 PARTIAL)
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 4,000A MCB, 65,000 AIC, NEMA 3R
 LOCATION: PLATFORM 11, TOTAL CONNECTED LOAD = UNKNOWN



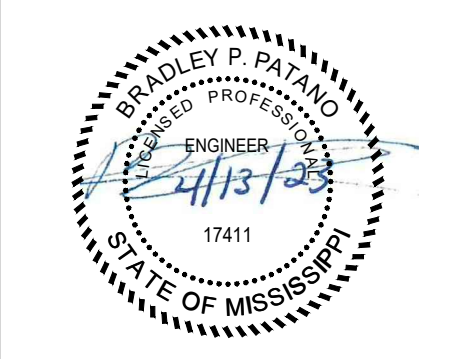
DRAWING E604 SPECIFIC NOTES

- 1 EXISTING FEEDER TO REMAIN AS-IS.
- 2 CONTRACTOR SHALL PROVIDE AND INSTALL PULLBOX/SPLICE BOX. SEE SHEET E501 FOR DETAILS.
- 3 CONTRACTOR SHALL EXTEND FEEDER TO NEW ELEVATED REEFER OUTLET. NEW CONDUCTOR SHALL BE ROUTED IN RGS CONDUIT. SPLICES SHALL BE MADE WATER-TIGHT. SEE SHEET E501 FOR DETAILS.
- 4 NEW REEFER OUTLETS (PROVIDED BY OWNER, INSTALLED BY CONTRACTOR) SHALL BE ON ELEVATED PLATFORM. CONTRACTOR SHALL NOTE THAT MULTIPLE REEFER OUTLETS ARE ON A SINGLE CIRCUIT. SEE CIVIL/STRUCTURAL SHEETS FOR PLATFORM DETAILS. PLATFORMS SHALL BE PROVIDED AND INSTALLED BY CONTRACTOR.
- 5 CONTINUE ON SHEET E603.

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ELEVATED REEFER PLUGS
 PORT OF GULFPORT MISSISSIPPI
 STATE PORT AUTHORITY
 30TH AVENUE
 GULFPORT, MS 39501

SCALE: NOT TO SCALE
 PROJECT NO: 0297.22.002
 DRAWN BY: KDB
 CHECKED BY: KDB

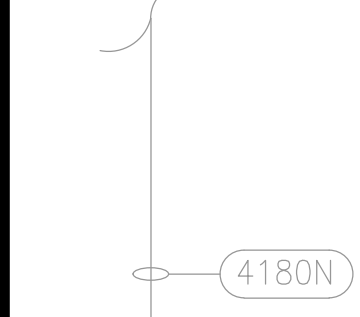
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E604
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MSB-16A (SECTION 1 & SECTION 2 PARTIAL)
480/277V, 3Ø, 4W,
4,000A MCB, 65,000 AIC, NEMA 3R
LOCATION: PLATFORM 16, TOTAL CONNECTED LOAD = UNKNOWN



DRAWING E605 SPECIFIC NOTES

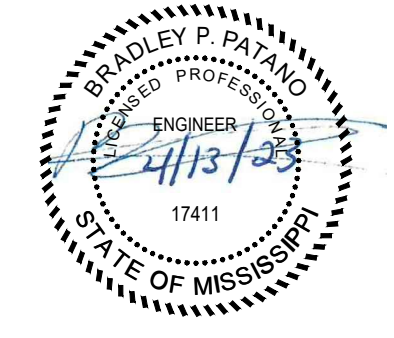
- 1 EXISTING FEEDER TO REMAIN AS-IS.
- 2 CONTRACTOR SHALL PROVIDE AND INSTALL PULLBOX/SPLICE BOX. SEE SHEET E501 FOR DETAILS.
- 3 CONTRACTOR SHALL EXTEND FEEDER TO NEW ELEVATED REEFER OUTLET. NEW CONDUCTOR SHALL BE ROUTED IN RGS CONDUIT. SPLICES SHALL BE MADE WATER-TIGHT. SEE SHEET E501 FOR DETAILS.
- 4 NEW REEFER OUTLETS (PROVIDED BY OWNER, INSTALLED BY CONTRACTOR) SHALL BE ON ELEVATED PLATFORM. CONTRACTOR SHALL NOTE THAT MULTIPLE REEFER OUTLETS ARE ON A SINGLE CIRCUIT. SEE CIVIL/STRUCTURAL SHEETS FOR PLATFORM DETAILS. PLATFORMS SHALL BE PROVIDED AND INSTALLED BY CONTRACTOR.
- 5 CONTINUE ON SHEET E602.

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GULFPORT, MS 39501

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