

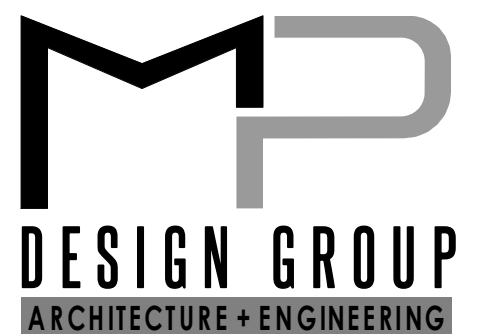
# VANCLEAVE SCHOOLS HVAC UPGRADES

## JACKSON COUNTY SCHOOL DISTRICT

LOWER ELEMENTARY, MIDDLE  
& HIGH SCHOOLS

12602 HWY 57, 4725 BULLDOG LN & 12424 HWY 57  
VANCLEAVE, MISSISSIPPI 39565

FEBRUARY 03, 2023  
REV 0 - ISSUED FOR CONSTRUCTION



"Designed to Build"

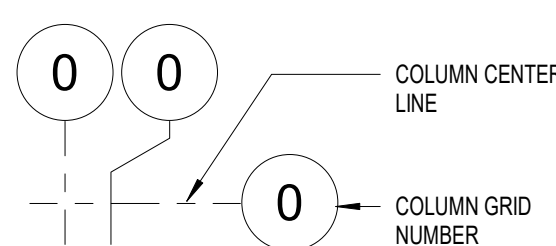
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David J. Machado, PE  
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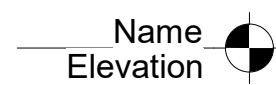


## GENERAL GRAPHIC LEGEND

### SYMBOL-COLUMN GRID



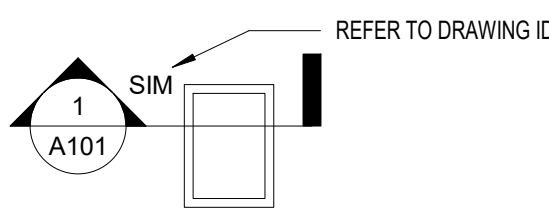
### SYMBOL-FINISHED FLOOR ELEVATION




### SYMBOL-SPOT ELEVATION




### SYMBOL-BUILDING SECTION / WALL SECTION




### SYMBOL-EXTERIOR ELEVATION / INTERIOR ELEVATION

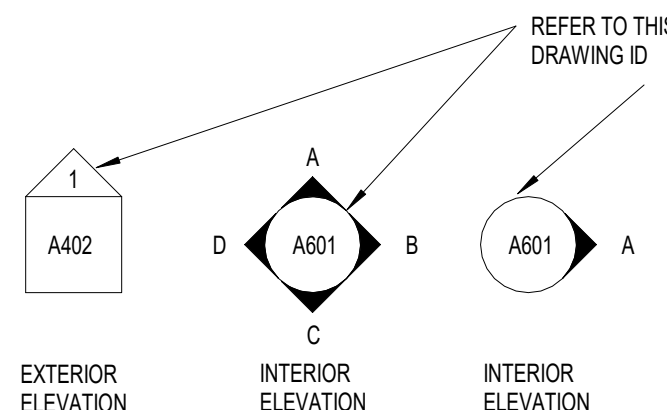


### SYMBOL-DETAIL CALLOUT

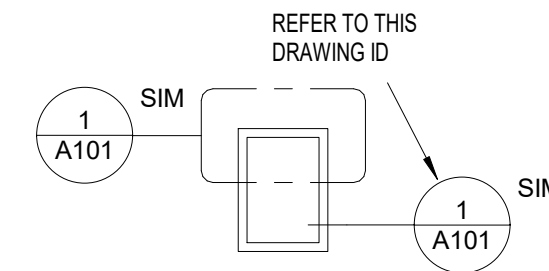


### SYMBOL-ROOM TAG

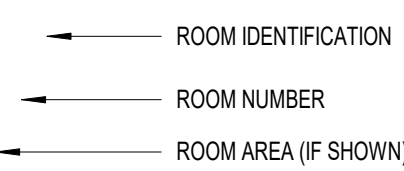

### SYMBOL-WALL / DOOR / WINDOW

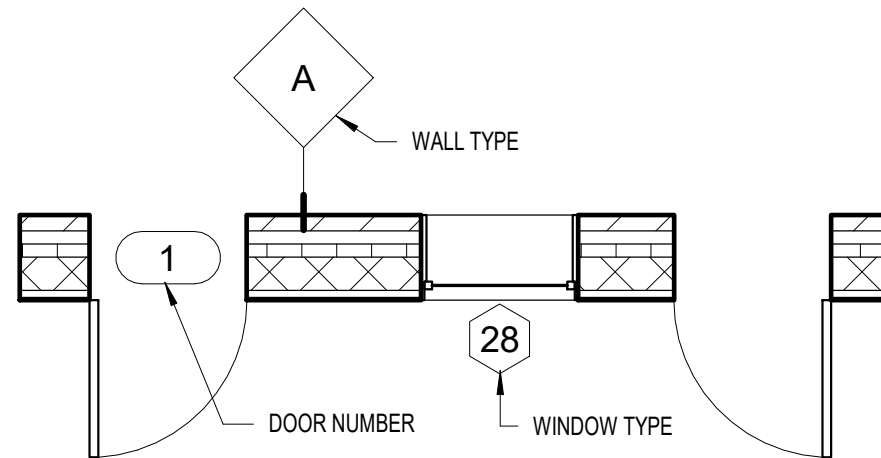


### SYMBOL-REVISIONS

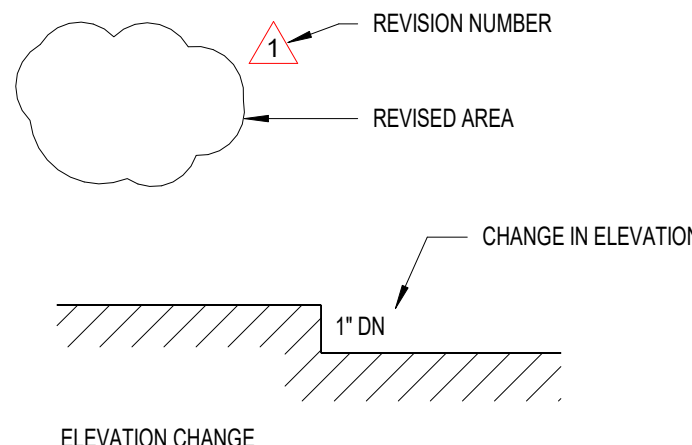


## ABBREVIATIONS INDEX

A	E (CONT)	L	R (CONT)
& @ /	AND AT ANGLE	LAM LAV LT	RET RM R.O RTU
A/C ACT ADDTL ADJ AF AFD AFF ALUM ALT APPROX ARCH ASF	AIR CONDITIONING ACOUSTICAL CEILING TILE ADDITIONAL ADJUSTABLE ACCESS FLOORING AUTOMATIC FIRE DAMPER ABOVE FINISH FLOOR ALUMINUM ALTERNATE APPROXIMATE ARCHITECT ALUMINUM STORE FRONT	MIXED AIR MASONRY MATERIAL MAXIMUM MECHANICAL MANUFACTURER MINIMUM MISCELLANEOUS MASONRY OPENING MODIFIED MOISTURE RELEASE VENT	SUPPLY AIR SANITARY SELF ADHERING FLASHING MEMBRANE SCHEDULE SOLID CORE WOOD SECTION STOREFRONT/ SQUARE FEET
BTWN BIT BJ BLDG BLK BLKG BLT BM BO BR BTWN	BETWEEN BITUMEN BAR JOIST BUILDING BLOCK BLOCKING BUILT BEAM BOTTOM OF BACKER ROD BETWEEN	METAL THRESHOLD MOUNTED METAL	SHEET SIMILAR SLOPE SPACING SPECIFIC/ SPECIFICATIONS SQUARE STAINLESS STEEL STANDARD STEEL STRUCTURAL SUPPLY SUSP SYNTHETIC
B	F	N	T
FA FAC FD FAR FE FEC	FIRE ALARM FIRE ALARM CABINET FLOOR DRAIN FIRE ALARM REMOTE FIRE EXTINGUISHER FIRE EXTINGUISHER CABINET	N/A NF NIC NO / # NOM NTS	TOP & BOTTOM TEMPORARY BENCH MARK TELEPHONE TOUNGE & GROOVE THRESHOLD TOILET T.O. T.O.B. T.O.S. TP TRTD TYP
C	G	O	U
CAP C/C CCTV	CAPACITY CENTER TO CENTER CLOSED CIRCUIT TELEVISION	GA GALV GC OF CMU GL GPM GYF BD	UC UL UNO
CJ CL CLG CLO CLR CMU	CONTROL JOINT CLEAR CEILING CLOSET COLOR CONCRETE MASONRY UNIT	OA OC OCEW OH OPNG OPP OZ	UNDER COUNTER UNDERWRITERS UNLESS NOTED OTHERWISE
CONTR COL COMP	CONTRACTOR COLUMN COMPRESSION OR COMPRESSED	±, +, - PT PARTN PRE-FIN PL PPL PLAM PLYWD PNL PP PR PRE FAB PROJ PSF PTD	VAR VD VERT VCT VIF VTR VWC
CONC COND CONST CONT CPNG CPT CT CTB CTR	CONCRETE CONDENSATE CONSTRUCTION CONTINUOUS COUPLING CARPET CERAMIC TILE CERAMIC TILE BASE CENTERS COLD WATER	PLUS OR MINUS PAINT PARTITION PRE FINISH(ED) PLATE PROPERTY LINE PLASTIC LAMINATE PLYWOOD PANEL POWER POLE PAIR PREFABRICATED PROJECTION POUNDS/SQUARE INCH PAPER TOWEL DISPENSER	VOL VOLUME DAMPER VERTICAL VINYL COMPOSITION TILE VENT THRU-ROOF VINYL WALL COVERING
D	I	J	W
DIA / DB DBL DEFL DEPT DET/DTL DISP DK DN DP DS DWG(S)	DIAMETER DRY BULB DOUBLE DEFLECTION DEPARTMENT DETAIL DISPENSER DARK DOWN DAMP PROOFING DOWNSPOUT DRAWING(S)	JAN JNT JST	WIDE, WIDTH WITH WITHOUT WOOD WATER GAUGE WIRE GLASS VISION PANEL WATER HEATER WATERPROOFING WATERPROOFING MEMBRANE
E	K	R	
EA EDF EF EFC	EACH ELECTRONIC DRINKING FOUNTAIN EXHAUST FAN EACH FACE	RA RB RD RE REF REFR REIN REQ'D	
	LAM LAT LAV LF LG LP	RETURN AIR RUBBER BASE ROOF DRAIN REFER TO... REFERENCE REFRIGERATOR REINFORCED REQUIRED	

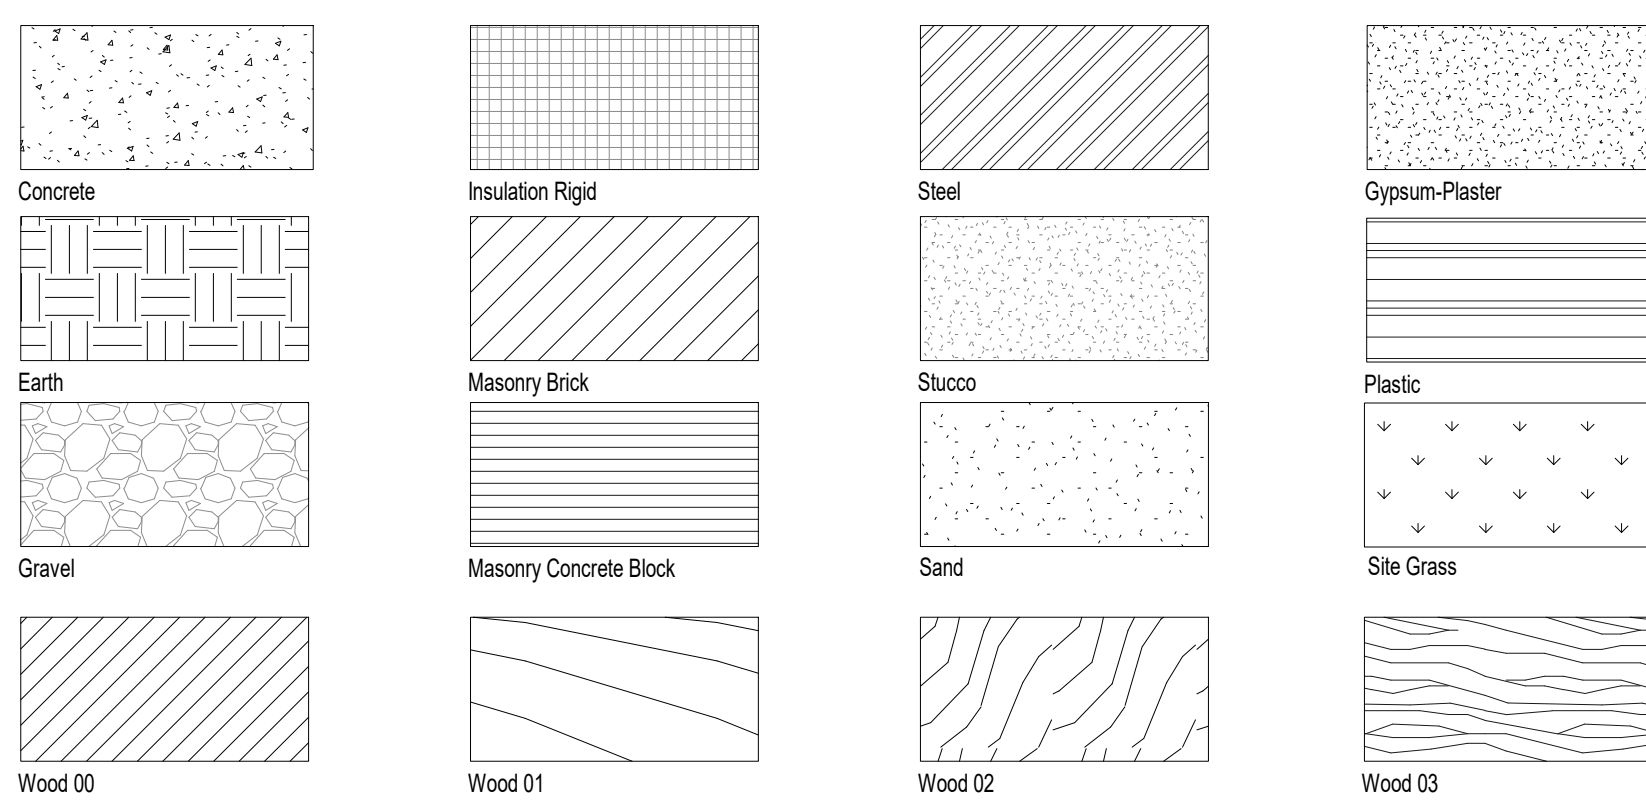
## MATERIAL HATCH LEGEND



## PROJECT MAP

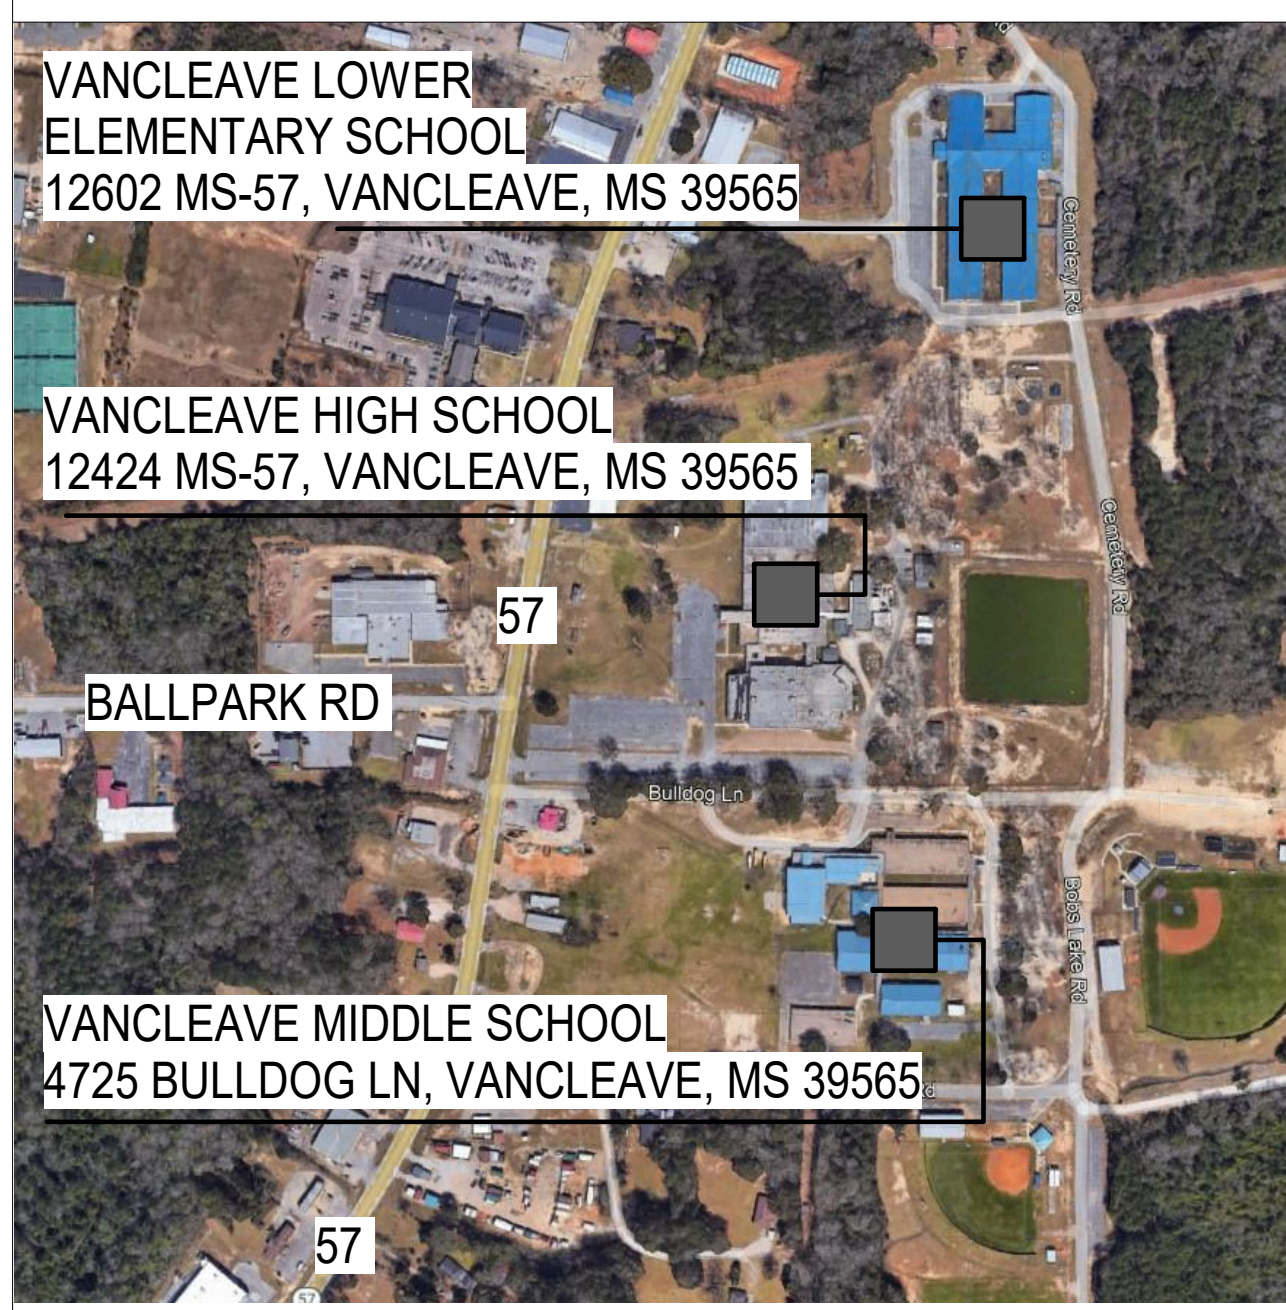

## VICINITY MAP

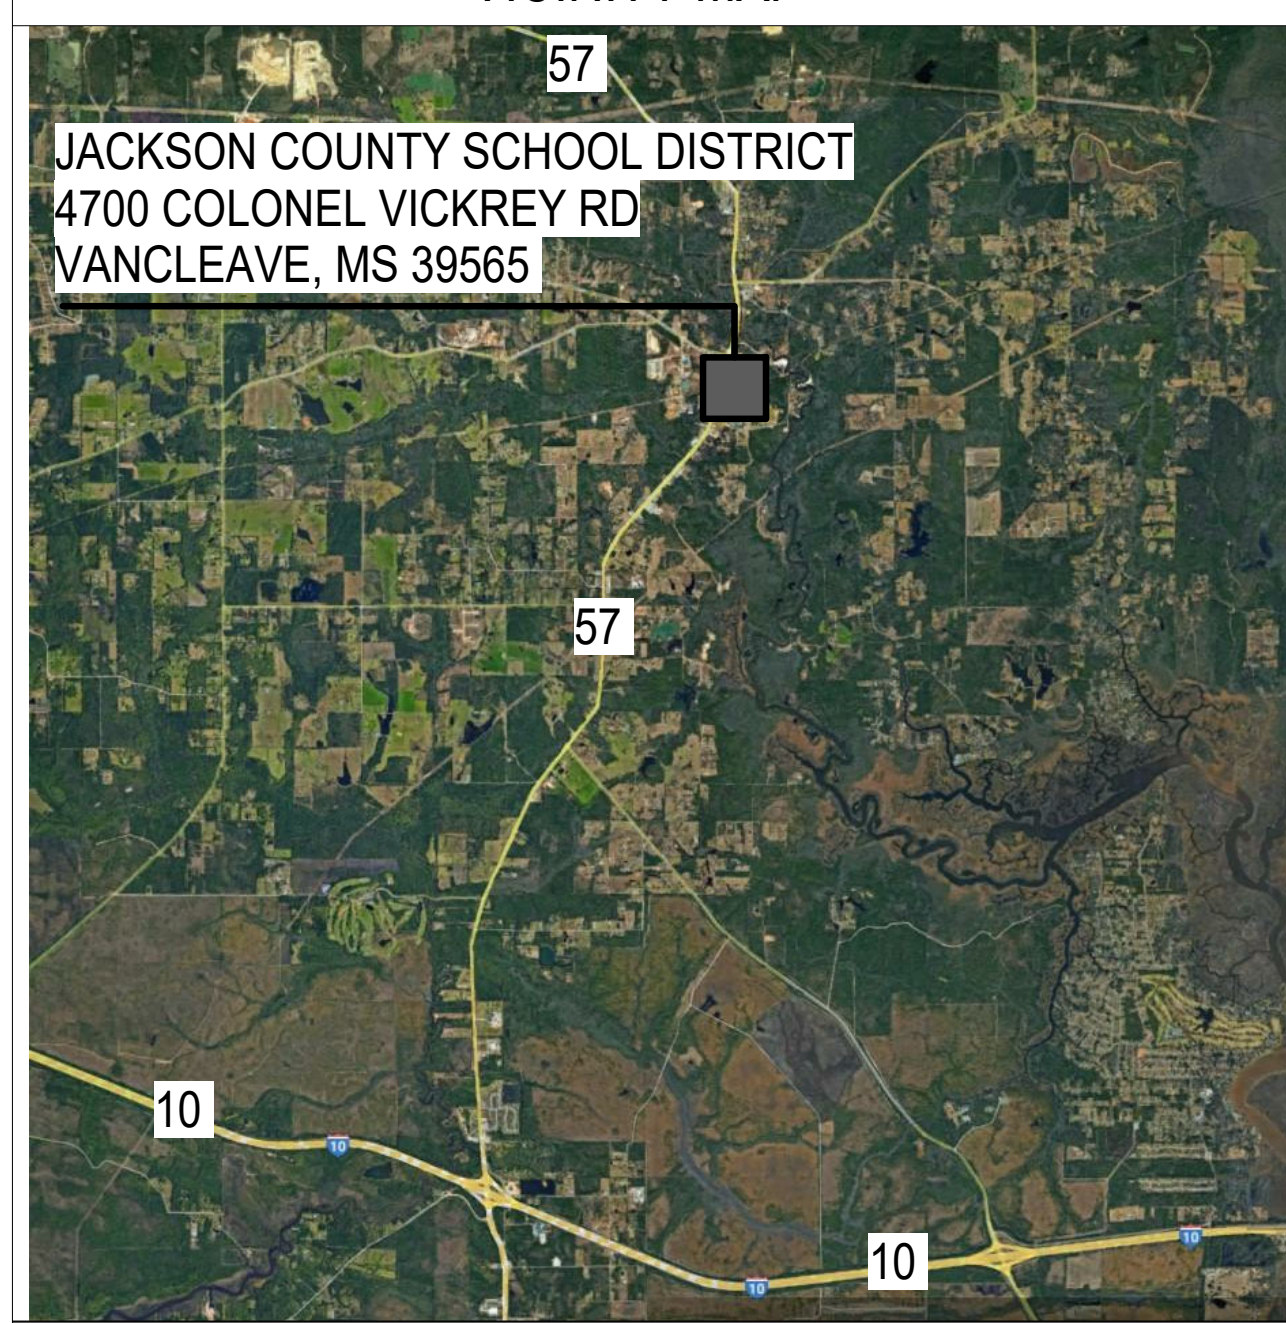

## PROJECT GENERAL NOTES

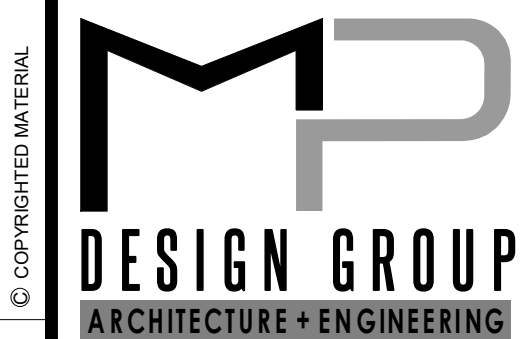
- THE CONSTRUCTION DOCUMENTS ARE COMPRISED OF BOTH DRAWINGS AND SPECIFICATIONS (PROJECT MANUAL). THE GENERAL CONTRACTOR SHALL NOT BREAK OUT SECTIONS TO SUB-CONTRACTORS OR VENDORS.
- DO NOT SCALE DRAWINGS. IF DIMENSIONS ARE IN QUESTION CONTRACTOR SHALL BE RESPONSIBLE FOR OBTAINING CLARIFICATION FROM ARCHITECT BEFORE CONTINUING WITH CONSTRUCTION.
- BIDDERS SHALL FIELD VERIFY ALL EXISTING CONDITIONS ON THE PROJECT JOB SITE PRIOR TO BIDDING.
- GENERAL CONTRACTOR IS RESPONSIBLE FOR COORDINATING WORK OF ALL TRADES TO INSURE A USABLE & FUNCTIONAL END PRODUCT. ANY CONFLICTS BETWEEN THE DRAWINGS AND SPECIFICATIONS SHALL BE CLARIFIED BY THE ARCHITECT/ENGINEER. IF NO CLARIFICATION IS ISSUED THE BIDDER SHALL BID THE MOST STRINGENT PRODUCT OR APPLICATION.
- GENERAL CONTRACTOR IS RESPONSIBLE FOR COORDINATING ALL ABOVE CEILING WORK TO INSURE ADEQUATE INSTALL FOR ALL COMPONENTS AND TO PREVENT THE ADJUSTMENT OF ANY CEILING COMPONENTS.
- GENERAL CONTRACTOR IS RESPONSIBLE FOR SECURING AND PROTECTING ALL CONSTRUCTION MATERIALS, EQUIPMENT, TOOLS, AND TEMPORARY FACILITIES ON THE JOB SITE FOR THE DURATION OF THE PROJECT.
- MATERIALS USED ON THIS PROJECT SHALL NOT CONTAIN ASBESTOS.
- GENERAL CONTRACTOR SHALL PLACE AND MAINTAIN THROUGHOUT DURATION OF PROJECT SPECIFIED GROUND MATERIAL OVER SOILS ADJACENT TO BUILDING PRIOR TO INSTALLING EXTERIOR WALL MATERIALS TO PREVENT STAINING ON FINISHED PRODUCT. ALL STAINS ON EXTERIOR WALL MATERIALS SHALL BE CLEANED AND FULLY REMOVED BEFORE SUBSTANTIAL COMPLETION OF PROJECT AT NO ADDITIONAL COST TO THE OWNER. IF STAINS CAN NOT BE REMOVED FROM THE FINISH MATERIALS, THE MATERIAL MUST BE REPLACED AT NO ADDITIONAL COST TO THE OWNER.
- GENERAL CONTRACTOR SHALL SUBMIT SHOP DRAWINGS AND SUBMITTALS FOR REVIEW AND APPROVAL BEFORE PROCEEDING WITH CONSTRUCTION. CONTRACTOR IS PROCEEDING AT HIS OWN RISK IF MATERIAL OR COMPONENTS ARE INSTALLED PRIOR TO RECEIVING REVIEWED AND EXECUTED SHOP DRAWINGS AND SUBMITTALS. CONTRACTOR SHALL TAKE LIABILITY FOR REMOVAL AND REPLACEMENT, AT NO ADDITIONAL COST TO THE OWNER, OF ALL MATERIAL, COMPONENTS AND LABOR FOR WORK INSTALLED WITHOUT SIGNED/STAMPED/APPROVED SHOP DRAWINGS AND SUBMITTALS.
- ALL BID AMOUNTS MUST BE BASED ON THE MOST STRINGENT REQUIREMENT CALLED FOR IN THE COMPLETE CONSTRUCTION DOCUMENT PACKAGE. IN ADDITION, THE MOST STRINGENT REQUIREMENT SHOWN SHALL GOVERN AND TAKE PRECEDENCE IN THE EVENT OF ANY AND ALL CONFLICTS BETWEEN DIFFERENT DRAWINGS (PLANS, ELEVATIONS, DETAILS, SECTIONS, SCHEDULES, ETC.), BETWEEN DIFFERENT SPECIFICATION SECTIONS, WITHIN SPECIFICATION SECTIONS, AND BETWEEN THE DRAWINGS AND THE SPECIFICATIONS. IT WILL BE THE GENERAL CONTRACTOR'S RESPONSIBILITY TO BRING ANY AND ALL DISCREPANCIES TO THE ARCHITECT'S ATTENTION FOR FURTHER CLARITY PRIOR TO SUBMITTING A FORMAL BID.
- ALL SITE INSPECTIONS, SITE VISITS, SITE MEETINGS, ETC., NOT PREVIOUSLY SCHEDULED, WHICH ARE REQUIRED FOR ANY REASON, ARRANGED OR SCHEDULED BY THE GENERAL CONTRACTOR, OR ANY OF THE PROJECT'S SUBCONTRACTORS, VENDORS, SUPPLIERS, ETC., THAT REQUIRE THE INVOLVEMENT OF ANY EMPLOYEE OF MP DESIGN GROUP OR ANY CONSULTANT OF MP DESIGN GROUP SHALL BE ARRANGED AND FINALIZED IN WRITING AT LEAST FORTY-EIGHT (48) HOURS IN ADVANCE WITH MP DESIGN GROUP.

## PROJECT SCOPE OF WORK

- ALL MECHANICAL, ELECTRICAL, STRUCTURAL, AND ARCHITECTURAL WORK ASSOCIATED WITH THE FOLLOWING:
- LOWER ELEMENTARY CAFETERIA** - REPLACE TWO 10 TON CONDENSING UNITS AND ASSOCIATED AIR HANDLERS
  - MIDDLE SCHOOL GYM** - REPLACE TWO 15 TON CONDENSING UNITS AND ASSOCIATED AIR HANDLERS WITH TWO 20 TON CONDENSING UNITS AND ASSOCIATED AIR HANDLERS
  - HIGH SCHOOL GYM** - REPLACE FOUR 20 TON PACKAGED ROOFTOP AC UNITS
  - HIGH SCHOOL LIBRARY** - REPLACE ONE 10 TON PACKAGED ROOFTOP AC UNIT
  - HIGH SCHOOL COOLING PLANT** - REPLACE COOLING TOWER AND ASSOCIATED FOUNDATION  
REPLACE HEAT EXCHANGER  
REPAIR FLANGE  
ADD REDUNDANT 30 HP CONDENSER WATER PUMP


## DRAWING INDEX

GENERAL INDEX	PLUMBING INDEX	ELECTRICAL INDEX
G000 COVER SHEET	N/A	E001 ELECTRICAL SYMBOL SCHEDULE
G101 GENERAL NOTES, ABBREV, SYMBOLS, SHEET INDEX		E002 ELECTRICAL NOTES
	<b>MECHANICAL INDEX</b>	E003 ELECTRICAL ABBREVIATIONS, LUMINARE SCHEDULE, & FEEDER SCHEDULE
	M001 MECHANICAL SYMBOLS & ABBREVIATIONS	E004 ELECTRICAL DEMO PLAN- LOWER ELEMENTARY SCHOOL
	M002 MECHANICAL NOTES	E005 ELECTRICAL DEMO PLAN- MIDDLE SCHOOL
		E006 ELECTRICAL DEMO PLAN- HIGH SCHOOL
<b>STRUCTURAL INDEX</b>		E101 MECHANICAL POWER PLAN- LOWER ELEMENTARY SCHOOL
S100 LOWER ELEMENTARY SCHOOL - MECHANICAL EQUIPMENT PAD PLAN, SECTIONS, & DETAILS		E102 MECHANICAL POWER PLAN- MIDDLE SCHOOL
S101 HIGH SCHOOL - COOLING TOWER FOUNDATION PLANS, SECTIONS, & DETAILS		E103 MECHANICAL POWER PLAN- HIGH SCHOOL
		E501 ELECTRICAL GENERAL DETAILS
		E501 ELECTRICAL ONE-LINE DIAGRAM DEMOLITION PLAN - HIGH SCHOOL
		E502 ELECTRICAL ONE-LINE DIAGRAM DEMOLITION PLAN - HIGH SCHOOL
		E503 ELECTRICAL ONE-LINE DIAGRAM DEMOLITION PLAN - LOWER ELEMENTARY SCHOOL
		E504 ELECTRICAL ONE-LINE DIAGRAM DEMOLITION PLAN - MIDDLE SCHOOL
		E510 ELECTRICAL ONE-LINE DIAGRAM PLAN - HIGH SCHOOL
		E511 ELECTRICAL ONE-LINE DIAGRAM PLAN - HIGH SCHOOL - ALTERNATE #1
		E512 ELECTRICAL ONE-LINE DIAGRAM PLAN - HIGH SCHOOL
		E513 ELECTRICAL ONE-LINE DIAGRAM PLAN - LOWER ELEMENTARY SCHOOL
		E514 ELECTRICAL ONE-LINE DIAGRAM PLAN - MIDDLE SCHOOL
<b>ARCHITECTURAL INDEX</b>		
N/A		



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**LOWER ELEMENTARY, MIDDLE & HIGH SCHOOLS**  
**JACKSON COUNTY SCHOOL DISTRICT**

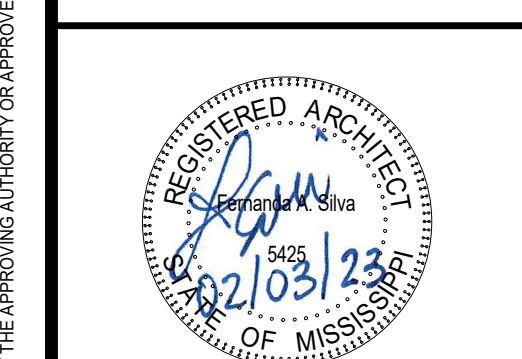
SCALE: AS INDICATED  
PROJECT NO: 0155.22.007  
DRAWN BY: MAJ,  
CHECKED BY: FAS

**GENERAL NOTES, ABBREV,  
SYMBOLS, SHEET INDEX**

NO.	DATE	REVISION / SUBMITTAL
REV 0	02.03.23	ISSUED FOR CONSTRUCTION

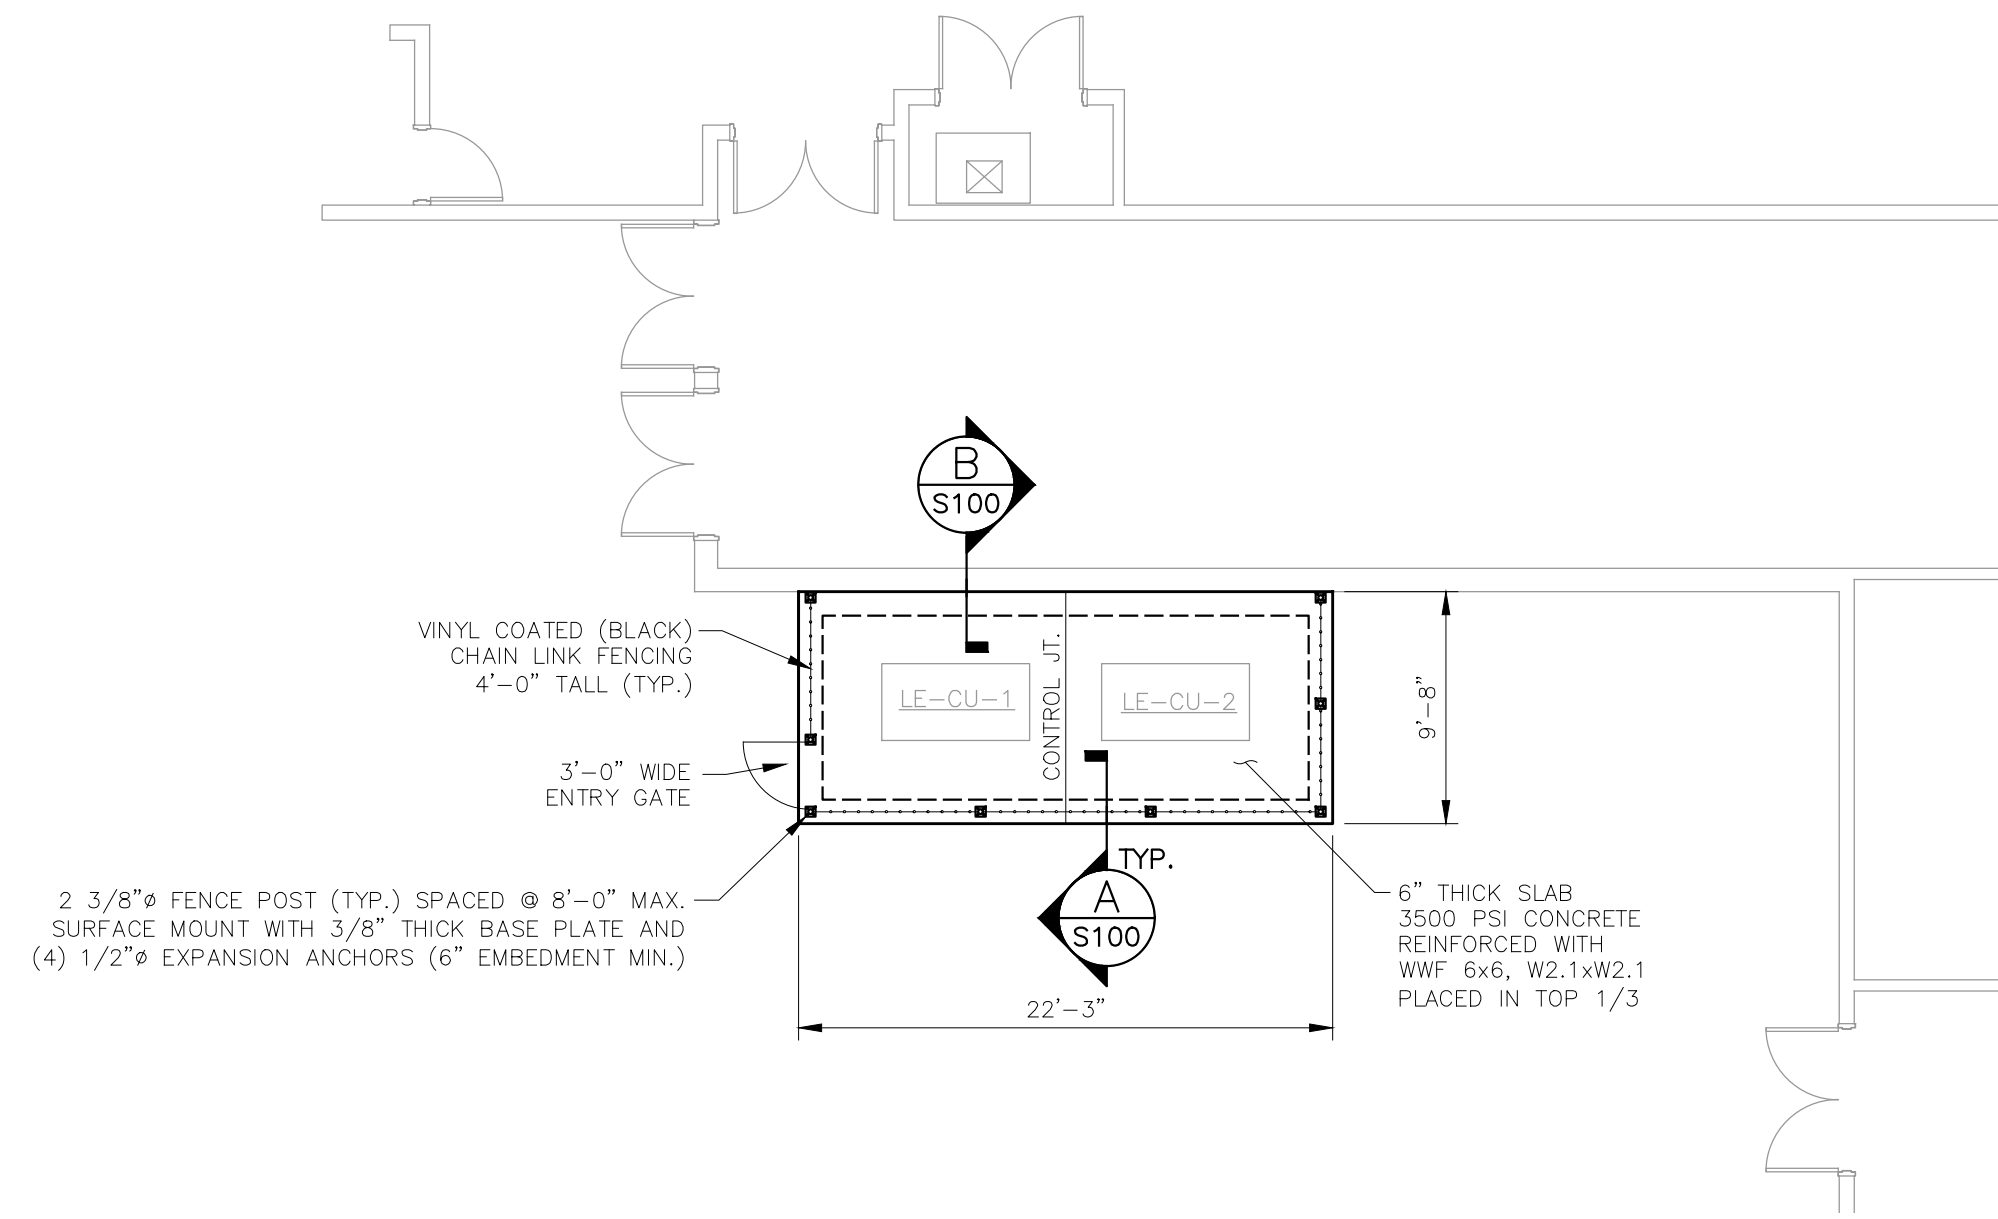
**G101**  
VERIFY SCALES  
BAR IS ONE INCH ON ORIGINAL DRAWING  
IF DISCREPANCIES OCCUR, THE ORIGINAL SIGNED, DATED AND SEALED ENGINEERED PLAN SET SHALL OVERRIDE ANY OTHER PLANS, THE DRAWINGS, DETAILS, AND NOTES THAT APPEAR ON THIS SHEET.






**LOWER ELEMENTARY SCHOOL  
MECHANICAL EQUIPMENT PAD  
FOUNDATION PLAN**

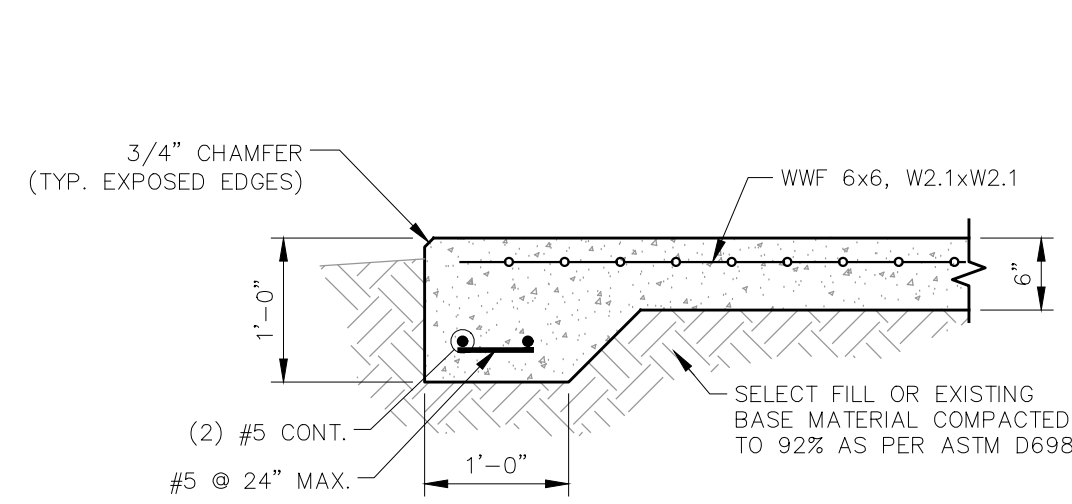
1 SCALE: 1/8" = 1'-0"



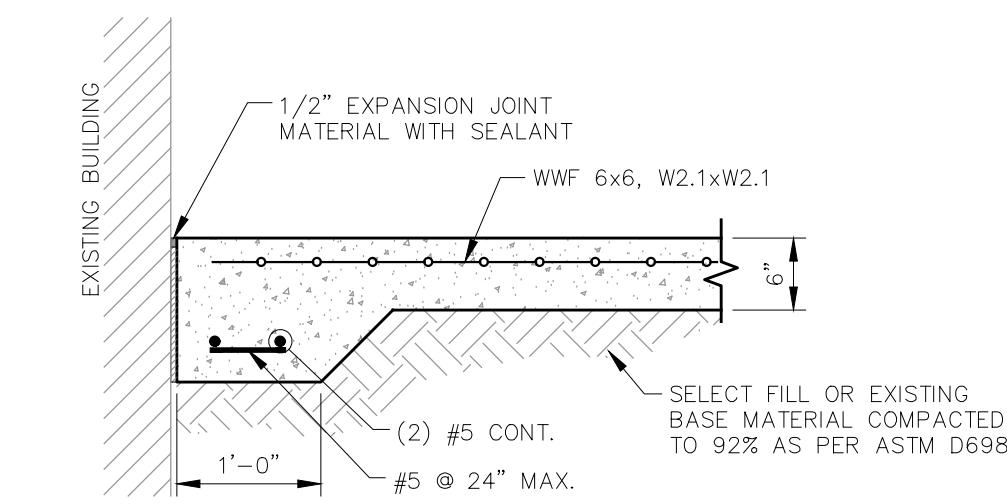**SECTION - FOUNDATION**  
SCALE: 3/4" = 1'-0"



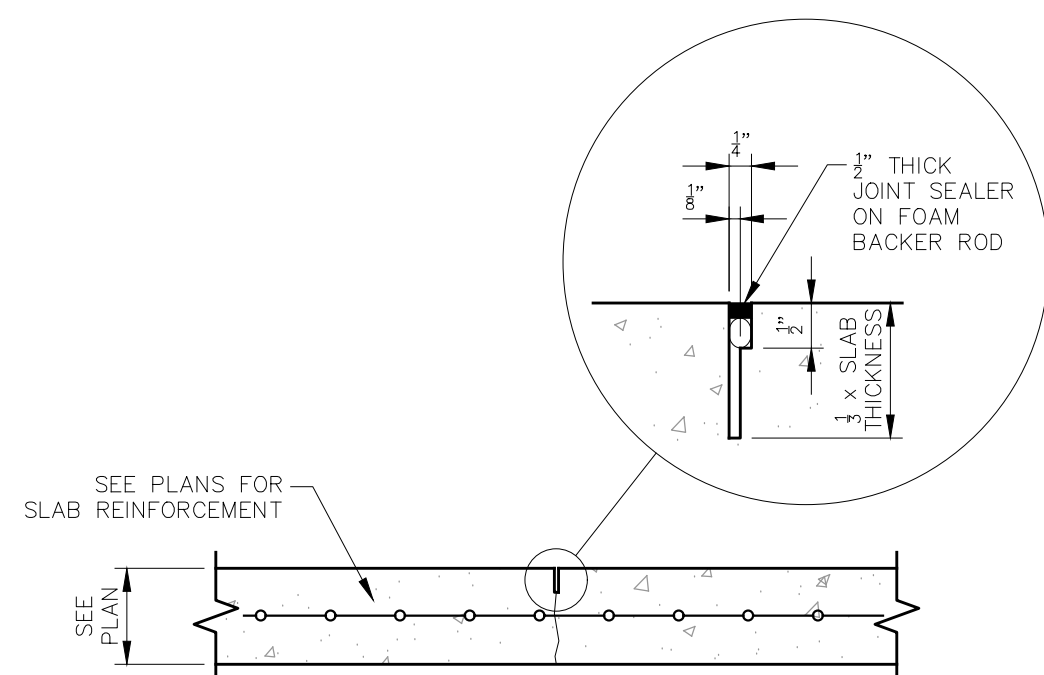**SECTION - FOUNDATION**  
SCALE: 3/4" = 1'-0"



**CONCRETE SAW CUT CONTROL JOINT (CJ)**

- NOTES:  
1.) SAW JOINTS IN GREEN CONCRETE ONCE ADEQUATE CURING HAS OCCURRED TO SUPPORT THE WEIGHT OF THE SAW AND OPERATOR (APPROX. 1 HOUR IN HOT WEATHER AND 4 HOURS IN COLD WEATHER). CUTS TO BE MADE USING A BLADE SPECIFICALLY DESIGNED FOR DRY EARLY ENTRY CONCRETE CUTTING

2 **DETAIL - SLAB JOINTING**  
SCALE: N.T.S.

**DESIGN CODES (ALL LATEST EDITION U.N.O.)**

- INTERNATIONAL BUILDING CODE (IBC 2018)
- AMERICAN SOCIETY OF CIVIL ENGINEERS (ASCE 7-16) MINIMUM DESIGN LOADS FOR BUILDINGS AND OTHER STRUCTURES
- AMERICAN CONCRETE INSTITUTE (ACI)
- AMERICAN INSTITUTE OF STEEL CONSTRUCTION (AISC)
- AMERICAN WELDING SOCIETY (AWS)
- AMERICAN IRON AND STEEL INSTITUTE (SPECIFICATIONS FOR THE DESIGN OF COLD FORMED STEEL CONSTRUCTION MEMBERS)

**MATERIAL SPECIFICATIONS**

- ANCHOR BOLTS  $F_y = 55,000$  PSI (ASTM F1554) (HOT DIP GALVANIZED)
- EMBEDDED STEEL  $F_y = 36,000$  PSI (ASTM A36)
- CAST IN PLACE CONCRETE
  - FOUNDATIONS  $F'_c = 3500$  PSI IN 28 DAYS
  - EXTERIOR EXPOSED CONC.  $F'_c = 3500$  PSI IN 28 DAYS (AIR ENTRAINED)
- REINFORCING STEEL
  - #3 OR LARGER  $F_y = 60,000$  PSI (ASTM A615, GRADE 60) (ASTM A616 (S1), GRADE 60)
  - WELDED WIRE FABRIC ASTM A185 (FLAT SHEETS ONLY)
  - STRUCTURAL STEEL  $F_y = 50$  KSI
  - HIGH STRENGTH STRUCTURAL BOLTS ASTM A325-N (U.N.O.)

**REINFORCING STEEL**

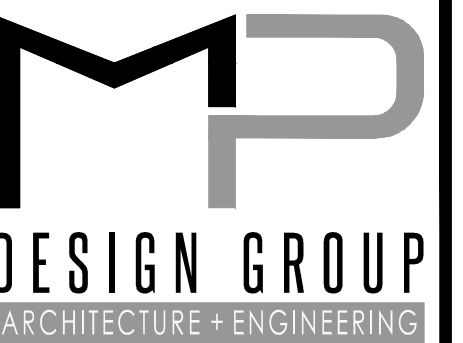
- ARRANGEMENT AND BENDING OF REINFORCING STEEL SHALL BE IN ACCORDANCE WITH THE ACI DETAILING MANUAL, LATEST EDITION.
- DETAILING OF REINFORCING STEEL SHALL CONFORM TO THE ACI MANUAL OF PRACTICE FOR DETAILING REINFORCED CONCRETE STRUCTURES, ACI 315. REINFORCEMENT SHALL NOT BE WELDED UNLESS NOTED OR APPROVED BY THE ENGINEER.
- REINFORCING STEEL SHALL BE NEW AND ALL BARS BE DEFORMED. REINFORCEMENT STEEL SHALL BE STORED IN SUCH MANNER TO PREVENT EXPOSURE TO THE ELEMENTS AND SHALL BE FREE OF RUST BEFORE PLACEMENT.
- REINFORCING BARS: ASTM A615 GRADE 60  
ASTM A706 GRADE 60 FOR WELDABLE REINFORCING
- BAR LAPS SHALL BE CLASS B TENSION LAPS (U.N.O.) AND SHALL BE LAPPED WITH MINIMUM LENGTHS AS SHOWN IN TYPICAL DETAILS, WHERE SPLICES ARE REQUIRED IN REINFORCING. SHORTER LAPS MAY BE ACCEPTABLE IF SPECIFIC LOCATIONS OF ALTERNATE LAPS ARE SHOWN ON THE REINFORCEMENT PLACEMENT DRAWINGS, WITH CALCULATIONS SUBMITTED/STAMPED BY PROFESSIONAL ENGINEER REGISTERED AND LICENSED IN THE STATE OF PROJECT LOCATION, JUSTIFYING THE ALTERNATE LAP LENGTHS.
- PROVIDE SUITABLE CHAIRS, TIES, WIRE SPACERS, ETC. FOR SUPPORTING REINFORCING STEEL IN PROPER LOCATION WHILE PLACING CONCRETE. "WET STICKING" DOWELS WILL NOT BE PERMITTED.
- WELDED WIRE MATERIAL SHALL COMPLY WITH AMERICAN SOCIETY OF TESTING MATERIALS (ASTM) A185 STANDARD SPECIFICATIONS. SUPPORT WELDED WIRE MATERIAL AT THE PROPER DEPTH PRIOR TO PLACING CONCRETE WITH MINIMUM CLEARANCES AS NOTED BELOW AND WITH APPURTENANCES NOTED BELOW. WELDED WIRE MATERIAL SHALL BE LAPPED ONE FULL MESH PANEL PLUS TWO (2) INCHES AT SIDES AND ENDS AND WIRED TOGETHER. LAP ALL SIDES AND ENDS EIGHT (8) INCHES, MINIMUM.
- MINIMUM CONCRETE PROTECTIVE COVERING FOR REINFORCEMENT IN SURFACES NOT EXPOSED DIRECTLY TO THE GROUND SHALL BE:
  - 3/4" FOR SLABS, JOISTS, AND WALLS
  - 1 1/2" FOR BEAM STIRRUPS AND COLUMN TIES/SPIRALS.
 "WET STICKING" DOWELS WILL NOT BE PERMITTED.
- MINIMUM CONCRETE PROTECTIVE COVERING FOR REINFORCEMENT IN SURFACES EXPOSED TO WEATHER OR IN CONTACT WITH GROUND SHALL BE:
  - 1 1/2" FOR BARS #5 OR SMALLER (U.N.O.)
  - 2" FOR BARS GREATER THAN #5 (U.N.O.)
  - PROVIDE 3" COVER FOR CONCRETE CAST AGAINST & PERMANENTLY EXPOSED TO EARTH (U.N.O.).
- CORNER BARS SHALL BE PROVIDED FOR ALL HORIZONTAL REINFORCING BARS AT INTERSECTIONS AND AND CORNERS OF ALL STRIP FOOTINGS, BEAMS, AND WALLS (U.N.O.). CORNER BARS SHALL BE OF THE SAME SIZE AND GRADE AS THE HORIZONTAL REINFORCING THEY CONNECT. MINIMUM LAP LENGTHS SHALL BE AS INDICATED AS INDICATED ON PLANS (U.N.O.).
- REINFORCING STEEL SHOWN IN SECTIONS AND DETAILS ARE SCHEMATIC AND INDICATE THAT REINFORCEMENT IS PRESENT. SEE SCHEDULES, SECTIONS NOTES, AND GENERAL NOTES FOR ACTUAL REINFORCING REQUIRED.
- REINFORCING STEEL SHALL BE PLACED IN ACCORDANCE (IAW) CRSI "PLACING REINFORCING BARS", LATEST EDITION.
- PROVIDE ONE (1) #4 HOOP WITH 8" LAP IN SLAB AROUND ALL FLOOR DRAINS.

**CAST IN PLACE CONCRETE**

- CONCRETE MIX DESIGN SHALL BE 3500 PSI IN 28 DAYS.
- CONTRACTOR SHALL VERIFY ALL IN SLAB FIXTURE DIMENSIONS WITH ARCHITECTURAL, MECHANICAL, PLUMBING AND ELECTRICAL PLANS. ALL SLOTS, SLEEVES AND OTHER EMBEDDED ITEMS SHALL BE SET BEFORE CONCRETE IS PLACED. ALL FOUNDATION PENETRATIONS SHALL BE THROUGH THICKENED SLAB EDGE OR 6" CLEAR BELOW FOOTING. CONDUIT SHALL NOT BE PLACED WITHIN THE SLAB ON GRADE. CONDUIT SHALL BE INSTALLED BELOW THE SLAB ON GRADE. PIPES, CONDUIT, AND DUCTS SHALL NOT EXCEED ONE-THIRD THE SLAB THICKNESS (BASED ON THE MAXIMUM OUTSIDE DIAMETER) AND SHALL HAVE A CENTER-TO-CENTER SPACING OF NO LESS THAN (3) DIAMETERS, UNLESS SPECIFICALLY DETAILED. REGARDLESS OF DIAMETER, THE MINIMUM CLEAR SPACING BETWEEN CONDUITS SHALL BE 1". NO MORE THAN FOUR CONDUITS MAY BE PLACED ADJACENT TO EACH OTHER WITHOUT PRIOR APPROVAL FROM THE STRUCTURAL ENGINEER OF RECORD. PROVIDE 1" MINIMUM CLEARANCE FROM REINFORCEMENT. LOCATIONS AND SIZES OF OPENINGS, SLEEVES, ETC. REQUIRED FOR OTHER TRADES MUST BE VERIFIED BY THOSE TRADES PRIOR TO PLACING CONCRETE. SEE MECHANICAL AND ELECTRICAL DRAWINGS FOR LOCATION OF SLEEVES, ACCESSORIES, ETC.
- NO ALUMINUM CONDUITS, FIXTURES, ETC. MAY BE IN DIRECT CONTACT WITH THE CONCRETE.
- ALL HONEY-COMBING, SPALLS, CRACKS, ETC. SHALL BE REPAIRED. EXTENT OF DEFECTIVE AREA SHALL BE DETERMINED BY THE STRUCTURAL ENGINEER.
- CHAMFER ALL EXPOSED EXTERNAL CORNERS OF CONCRETE WITH A 3/4" DEGREE CHAMFER, UNLESS NOTED OTHERWISE.
- REFER TO PLANS FOR CONTROL JOINT LOCATIONS. CONSTRUCTION JOINTS MAY BE ADDED AS REQUIRED TO PREVENT THE FORMATION OF CONCRETE COLD JOINTS DURING PLACEMENT OF CONCRETE. CONSTRUCTION JOINTS SHALL BE INSTALLED IN LOCATIONS WHERE THE CONCRETE PLACEMENT OPERATION IS SCHEDULED FOR SEVERAL SEPARATE PLACEMENTS OR WHEREVER THE CONCRETE PLACEMENT IS DELAYED A SUFFICIENT AMOUNT OF TIME TO FORM A CONCRETE COLD JOINT.
- SLABS ON GRADE SHALL BE A THICKNESS AND REINFORCING AS SHOWN ON PLANS. REINFORCING AS SHOWN ON PLANS AND SHALL BE HELD SECURELY FROM THE GROUND USING REBAR CHAIRS OR OTHER APPROVED METHODS (CUT CONCRETE BRICK MAY BE USED) TO ENSURE MESH STAYS AT DEPTH INTENDED.
- UNDER NO CIRCUMSTANCES WILL DIGGING, TUNNELING OR TRENCHING BE ALLOWED AT OR NEAR ANY CONCRETE STRUCTURE WHICH MIGHT ACT TO UNDERMINE THE STRUCTURE.
- EXPANSION JOINT FILLER SHALL BE PREMOLDED MATERIAL COMPOSED OF FIBERBOARD IMPREGNATED WITH ASPHALT CONFORMING TO ASTM D1751.
- ALL DETAILS SHOWN ARE TYPICAL, SIMILAR DETAILS APPLY TO SIMILAR CONDITIONS.


**STRUCTURAL STEEL**

- UNLESS SPECIFICALLY NOTED OTHERWISE IN PLANS, FABRICATION AND ERECTION OF STRUCTURAL STEEL SHALL BE IN ACCORDANCE WITH AISC SPECIFICATIONS, LATEST EDITION.
- THE FABRICATOR SHALL BE RESPONSIBLE FOR THE DESIGN AND ADEQUACY OF ALL CONNECTIONS THAT ARE NOT DESIGNED OR FULLY DETAILED IN THE CONTRACT DOCUMENTS.
- WHERE FIELD AND SHOP WELDS ARE INDICATED ON THE DRAWINGS, THEY SHALL BE THE SIZE AND TYPE NOTED. ALL WELDING OF STRUCTURAL STEEL SHALL BE DONE IN ACCORDANCE WITH THE LATEST EDITION OF AWS D1.1 CORRESPONDING TO THE AISC SPECIFICATION USED AND ALL WELDS INCLUDING FIELD WELDS SHALL BE MADE BY CERTIFIED WELDERS USING E70XX ELECTRODES.
- THE CONTRACTOR SHALL PROVIDE ALL TEMPORARY BRACING REQUIRED TO MAINTAIN STABILITY UNTIL THE SYSTEM IS COMPLETE IN PLACE.
- EXTERIOR EXPOSED STRUCTURAL STEEL PREP AND COATING SYSTEM:
  - A. ALL STEEL AND FASTENERS SHALL BE HOT DIP GALVANIZED AFTER FABRICATION.
- THE GENERAL CONTRACTOR SHALL BE RESPONSIBLE FOR INCLUDING THE COSTS FOR ALL MISCELLANEOUS STEEL IN THEIR BID REGARDLESS OF WHETHER OR NOT THOSE ITEMS ARE INDICATED ON THE STRUCTURAL DRAWINGS. THESE COSTS SHALL INCLUDE, BUT NOT LIMITED TO, MISCELLANEOUS STEEL ITEMS SHOWN ON ARCHITECTURAL, CIVIL, MECHANICAL, PLUMBING, AND ELECTRICAL DRAWINGS.
- FIELD CUTTING, DRILLING, AND OTHER MODIFICATIONS OF STRUCTURAL STEEL COMPONENTS IS NOT PERMITTED WITHOUT WRITTEN APPROVAL OF THE STRUCTURAL ENGINEER OF RECORD. WHERE BEAM PENETRATIONS CANNOT BE AVOIDED OR WHERE CUTTING IS REQUIRED, THE CONTRACTOR SHALL SUBMIT, TO THE STRUCTURAL ENGINEER OF RECORD, ALL PERTINENT INFORMATION INCLUDING PENETRATION SHAPE, SIZE, LOCATION, AND METHOD OF CUTTING THE OPENING.



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**VANCLAVE SCHOOLS HVAC UPGRADES**  
**LOWER ELEMENTARY, MIDDLE, & HIGH SCHOOLS**  
12602 HWY 57, 4725 BULLDOG LN,  
& 12424 HWY 57  
VANCLAVE, MISSISSIPPI 39565

SCALE: AS INDICATED  
PROJECT NO: 0155.22.008  
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**LOWER ELEMENTARY SCHOOL  
MECHANICAL EQUIPMENT PAD  
PLAN, SECTIONS, & DETAILS**

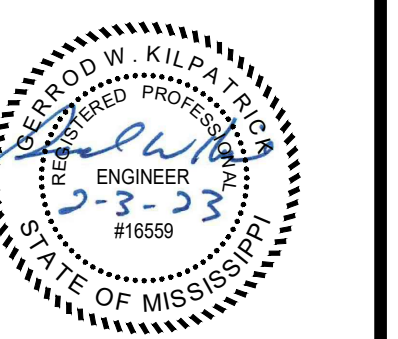
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**S100**

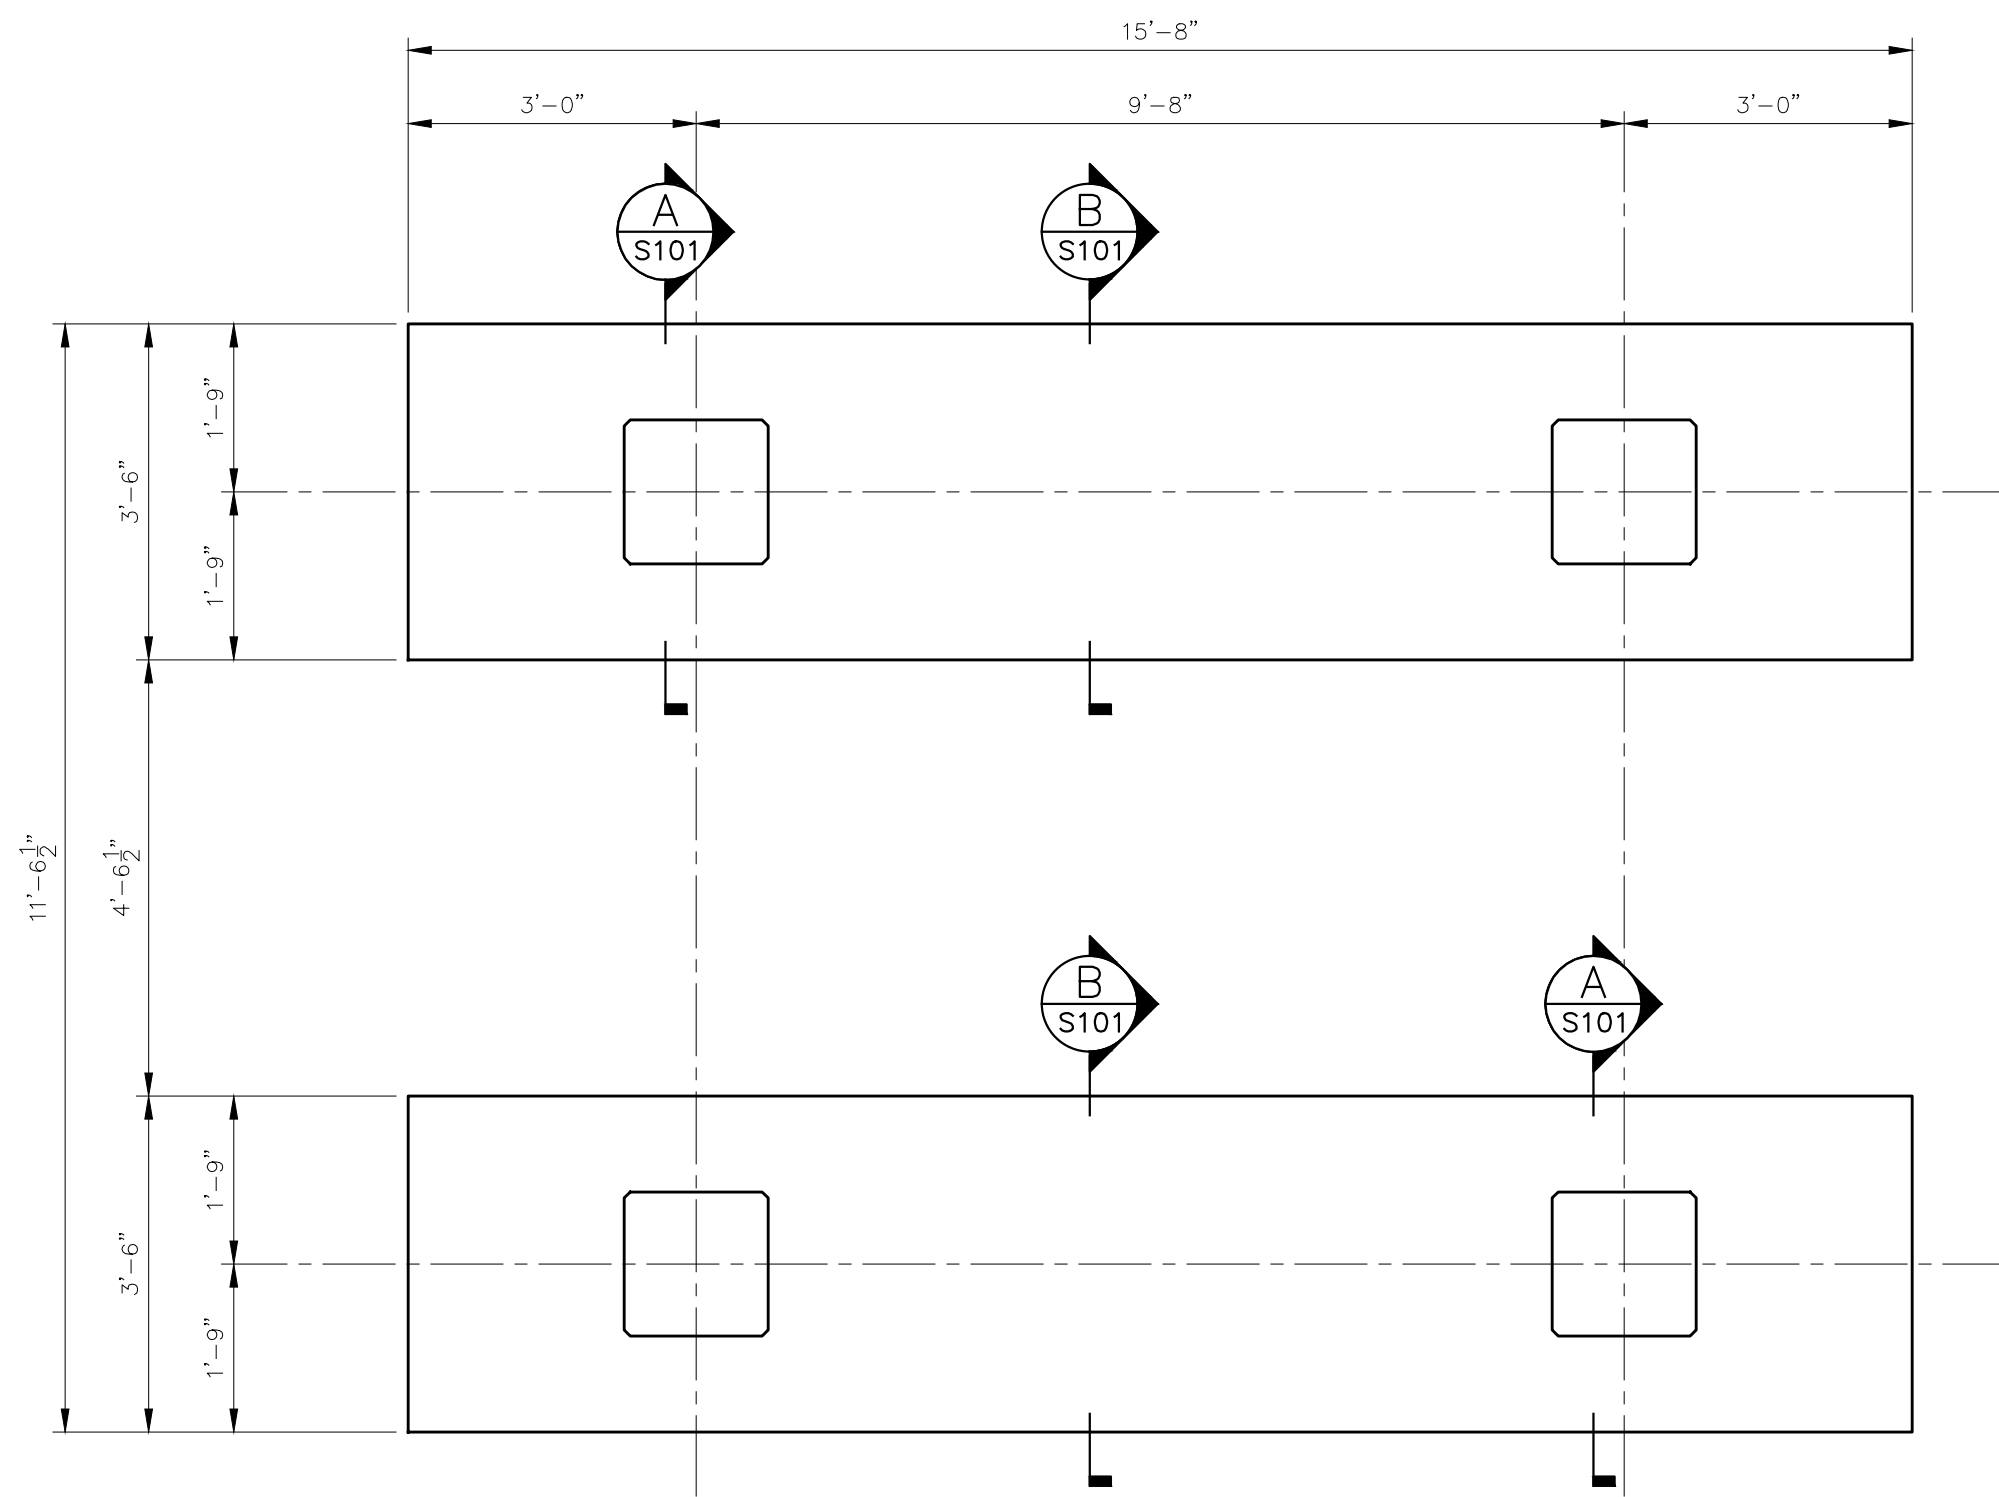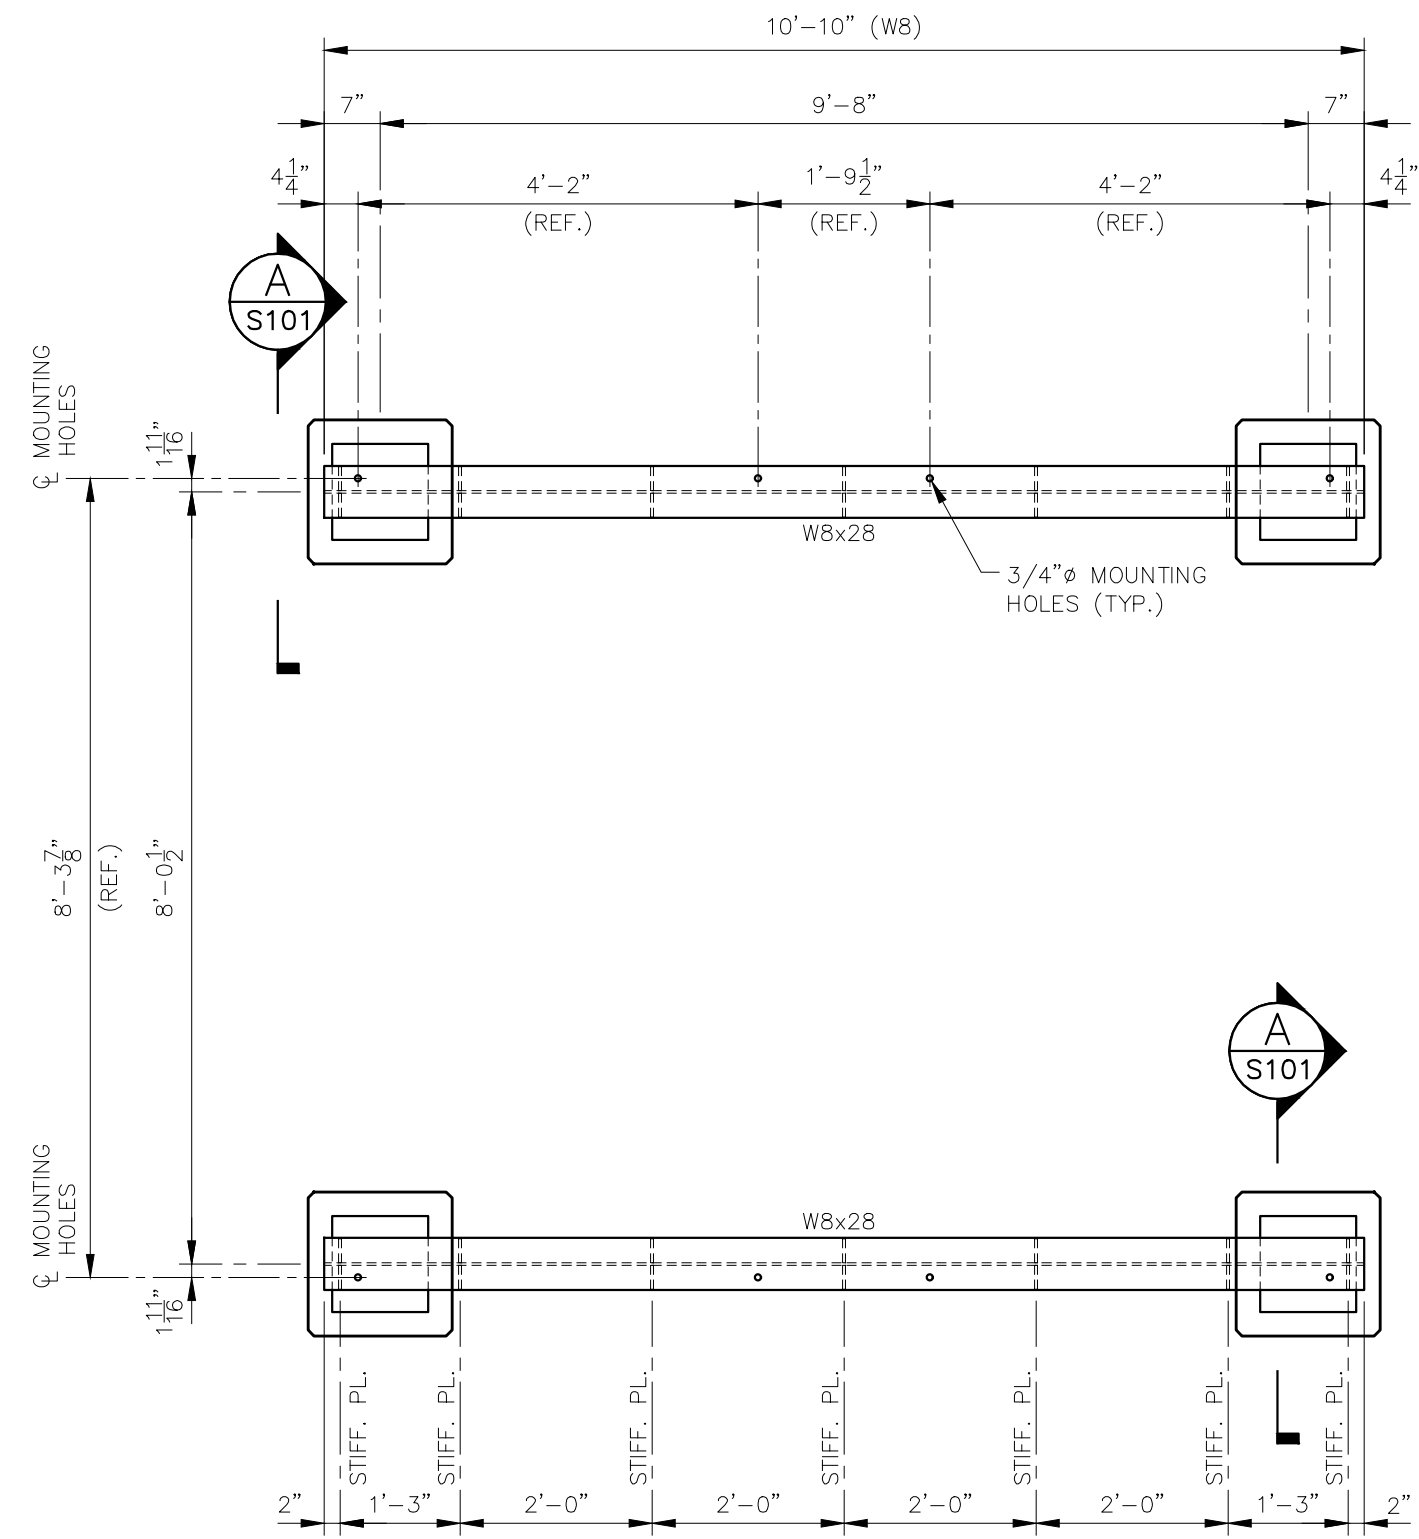
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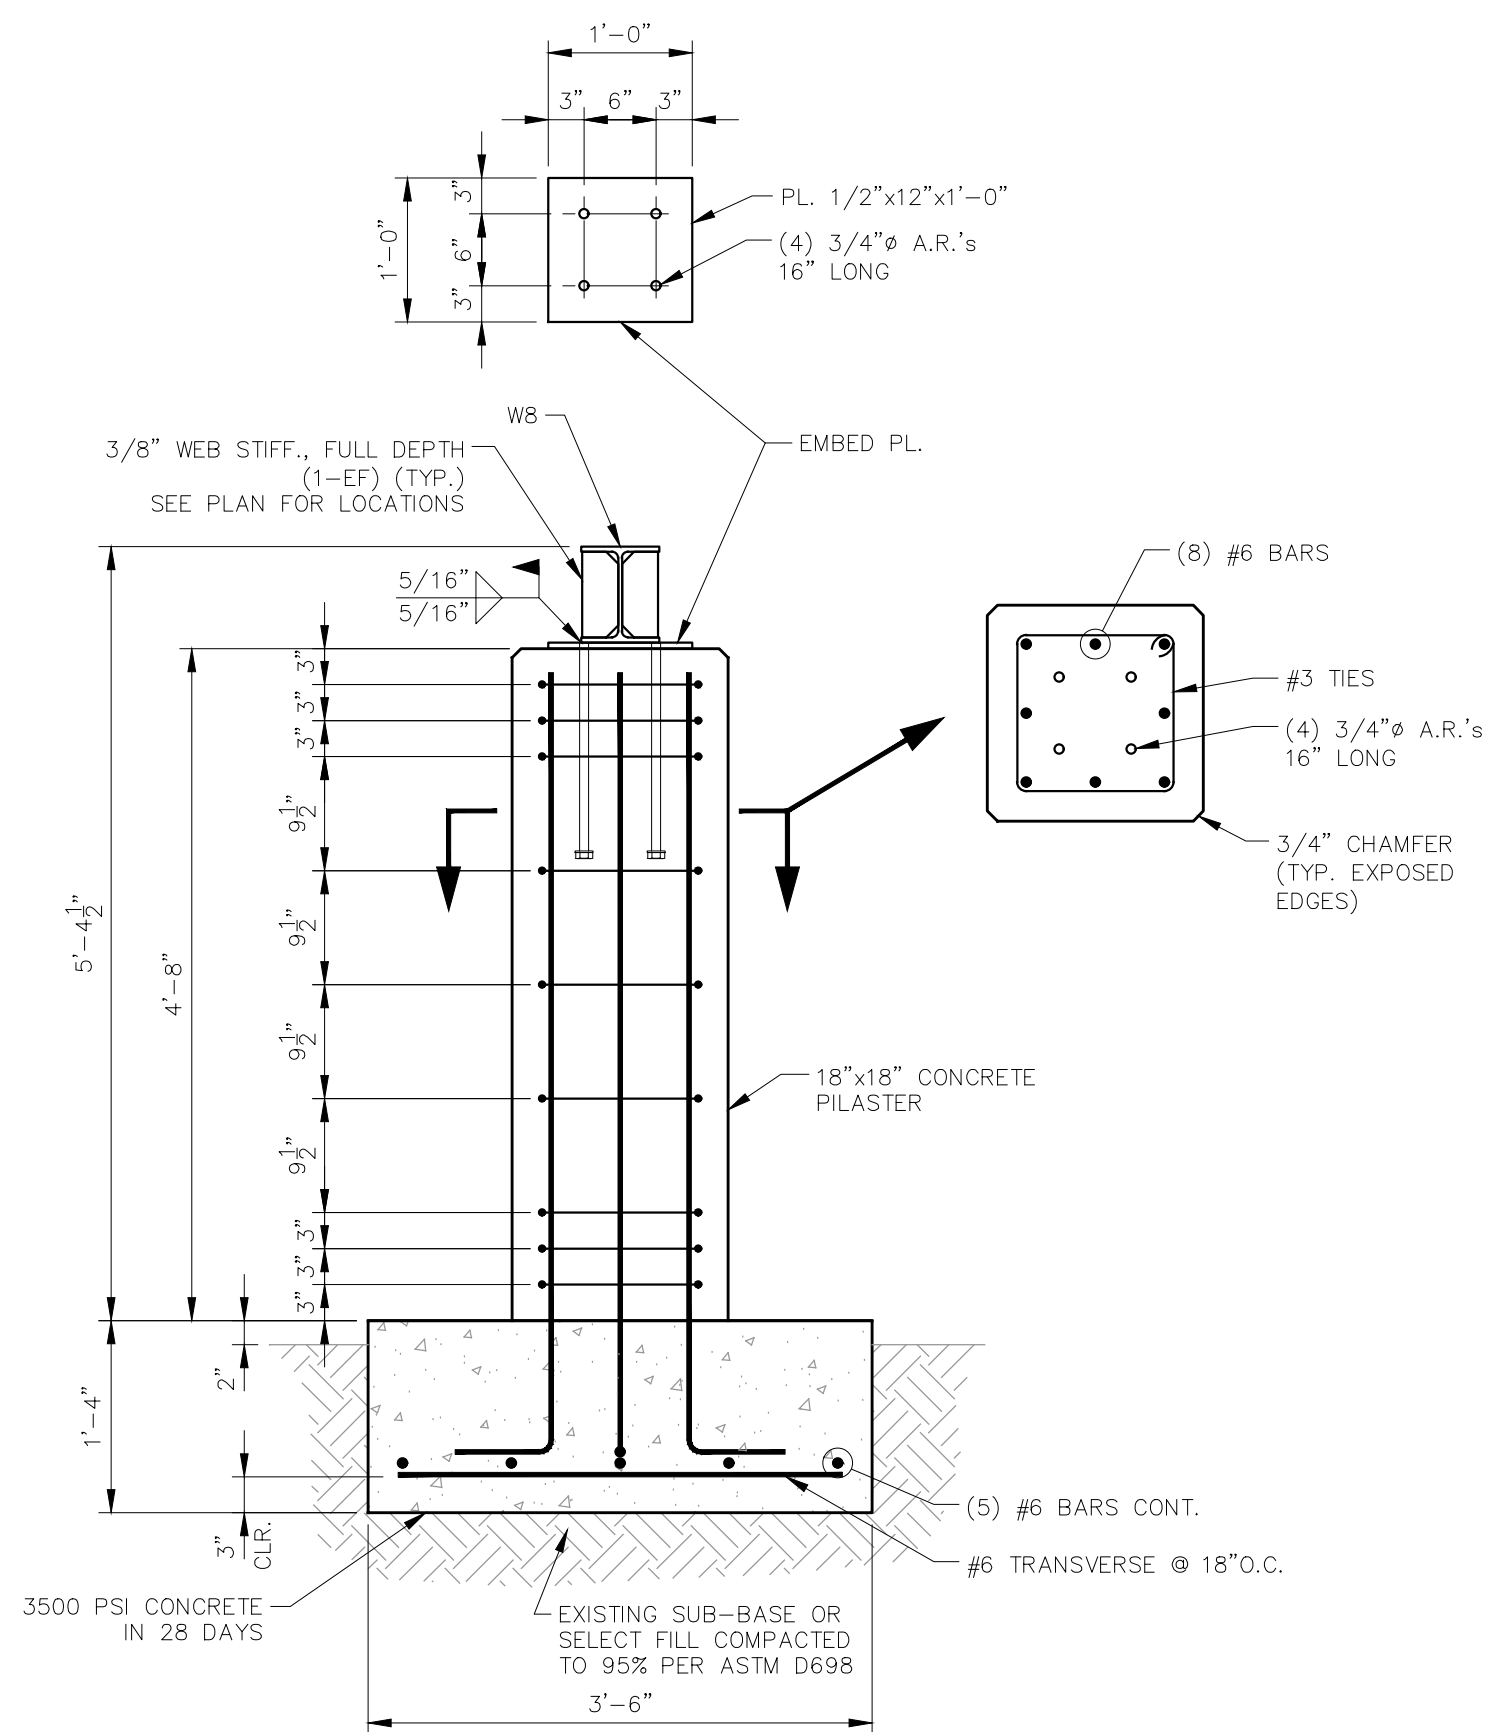
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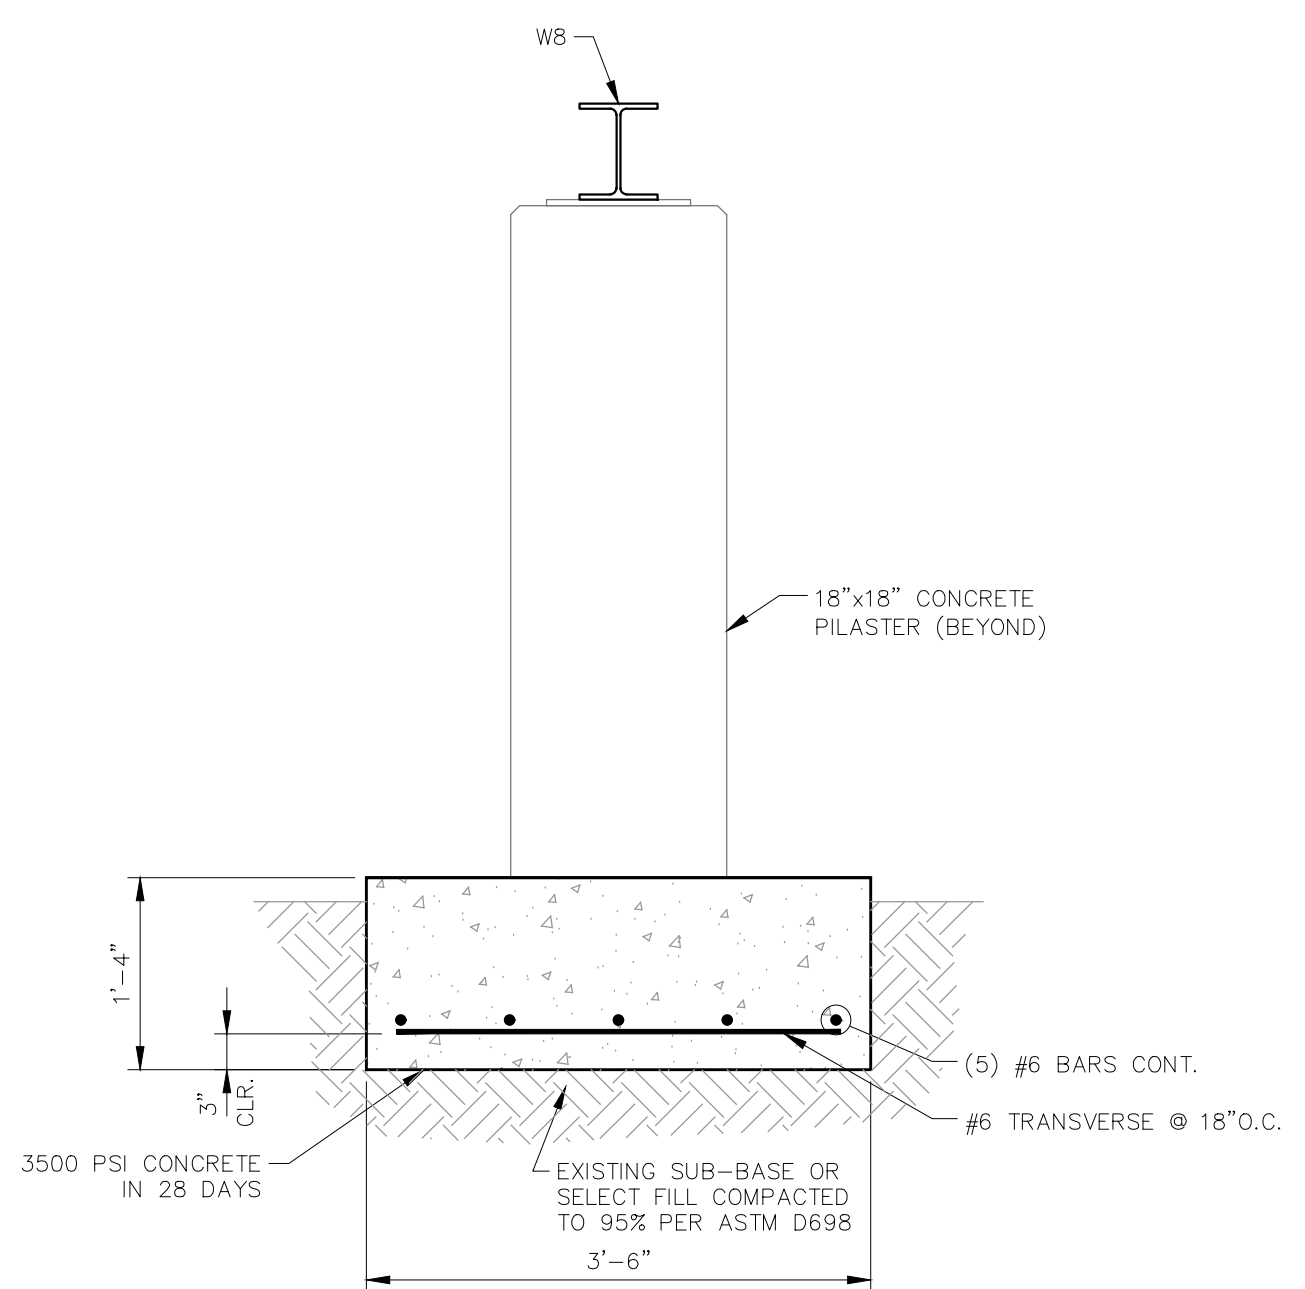
**1 HIGH SCHOOL - COOLING TOWER - FOUNDATION PLAN**  
 SCALE: 1/2" = 1'-0"  
 SEE MECHANICAL PLANS FOR LOCATION AND ORIENTATION



**2 HIGH SCHOOL - COOLING TOWER - FRAMING PLAN**  
 SCALE: 1/2" = 1'-0"  
 SEE MECHANICAL PLANS FOR LOCATION AND ORIENTATION



**A SECTION**  
 S101 | S101 SCALE: 3/4" = 1'-0"



**B SECTION**  
 S101 | S101 SCALE: 3/4" = 1'-0"


SEE S100 FOR STRUCTURAL NOTES

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**HIGH SCHOOL - COOLING TOWER**  
**PLANS, SECTIONS, & DETAILS**

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HVAC SYMBOLS	
	SQUARE/RECTANGULAR SUPPLY DOWN
	SQUARE/RECTANGULAR SUPPLY UP
	ROUND SUPPLY DOWN
	ROUND SUPPLY UP
	SQUARE/RECTANGULAR RETURN DOWN
	SQUARE/RECTANGULAR RETURN UP
	ROUND RETURN DOWN
	ROUND RETURN UP
	SQUARE/RECTANGULAR EXHAUST DOWN
	SQUARE/RECTANGULAR EXHAUST UP
	ROUND EXHAUST DOWN
	ROUND EXHAUST UP
	SQUARE/RECTANGULAR ELBOW
	SQUARE/RECTANGULAR ELBOW WITH TURNING VANES
	ROUND MAIN WITH CONICAL TAKEOFF
	ROUND MAIN WITH CONICAL TEE
	SQUARE/RECTANGULAR MAIN WITH CONICAL TEE
	ROUND MAIN WITH 45° LATERAL WYE
	SQUARE/RECTANGULAR MAIN WITH 45° LEAD IN TAKEOFF
	ROUND ELBOW
	EXISTING DUCT TO BE REMOVED
	EXISTING DUCT TO REMAIN
	NEW DUCT
	FLEXIBLE DUCT
	MANUAL VOLUME DAMPER
	INTERNALLY INSULATED DUCT
	SQUARE/RECTANGULAR TO ROUND TRANSITION
	CONCENTRIC TRANSITION
	ECCENTRIC TRANSITION
	ROUND NECK CEILING AIR TERMINAL
	SQUARE/RECTANGULAR NECK CEILING AIR TERMINAL
	TRANSFER AIR PATH
	TIMECLOCK
	THERMOSTAT
	TEMPERATURE SENSOR
	HUMIDITY SENSOR
	DUCT SMOKE DETECTOR
	CONNECT TO EXISTING
	SWITCH
	MOTORIZED DAMPER
	FIRE DAMPER
	COMBINATION FIRE/SMOKE DAMPER
	SMOKE DAMPER
	BACKDRAFT DAMPER
	CAP AND SEAL
	FLEXIBLE CONNECTION

HVAC ABBREVIATIONS	
A	
A	AMPS
AC	AIR CONDITIONING
AFF	ABOVE FINISHED FLOOR
AHU	AIR HANDLING UNIT
AL	ALUMINUM
B	
BDD	BACKDRAFT DAMPER
BOD	BOTTOM OF DUCT
C	
CEF	CEILING EXHAUST FAN
CFH	CUBIC FEET PER HOUR
CFM	CUBIC FEET PER MINUTE
CHW	CHILLED WATER
CHWR	CHILLED WATER RETURN
CHWS	CHILLED WATER SUPPLY
CU	CONDENSING UNIT
CW	CONDENSER WATER
CWS	CONDENSER WATER SUPPLY
CWR	CONDENSER WATER RETURN
D	
DC	DIRECT CURRENT
E	
E	EXISTING
EA	EXHAUST AIR
EC	ELECTRICAL CONTRACTOR
EF	EXHAUST FAN
ESP	EXTERNAL STATIC PRESSURE
F	
FC	FAN COIL
FD	FIRE DAMPER
FSD	COMBINATION FIRE/SMOKE DAMPER
FT	FOOT/FEET
G	
GA	GAUGE
GC	GENERAL CONTRACTOR
GFM	GLASS FABRIC AND MASTIC
H	
HP	HORSEPOWER OR HEAT PUMP
HW	HOT WATER
HWR	HOT WATER RETURN
HWS	HOT WATER SUPPLY
K	
KW	KILOWATT
L	
LBS	POUNDS
M	
MAX	MAXIMUM
MBH	ONE THOUSAND BRITISH THERMAL UNITS PER HOUR
MC	MECHANICAL CONTRACTOR
MCA	MINIMUM CIRCUIT AMPACITY
MD	MOTORIZED DAMPER
MIN	MINIMUM
MOCP	MAXIMUM OVERCURRENT PROTECTION
N	
NC/PO	NORMALLY CLOSED/POWERED OPEN
NIC	NOT IN CONTRACT
NIS	NEOPRENE IN SHEAR
NO/PC	NORMALLY OPEN/POWERED CLOSED
NTS	NOT TO SCALE
O	
OA	OUTDOOR AIR
OC	ON CENTER
P	
PC	PLUMBING CONTRACTOR
PH	PHASE
R	
RA	RETURN AIR
RFD	ROUND FIRE DAMPER
RGS	RIGID SEALED
RIS	RUBBER IN SHEAR
RPM	REVOLUTIONS PER MINUTE
S	
SA	SUPPLY AIR
SFD	SQUARE FIRE DAMPER
SQFT	SQUARE FEET
T	
TSP	TOTAL STATIC PRESSURE
TYP	TYPICAL
U	
UC	UNDERCUT DOOR
UL	UNDERWRITERS LABORATORIES
V	
V	VOLTAGE
VD	VOLUME DAMPER
VIF	VERIFY IN FIELD
W	
W	WATT
WC	WATER COLUMN

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MECHANICAL SYMBOLS & ABBREVIATIONS

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## HVAC NOTES

### A. GENERAL

1. ALL WORK SHALL CONFORM TO THE LATEST EDITIONS OF THE INTERNATIONAL CODE AND ALL LOCAL ORDINANCES AS ADOPTED BY THE LOCAL JURISDICTION.
  2. CONTRACTOR SHALL PROVIDE ALL MATERIALS AND LABOR NECESSARY FOR THE COMPLETE INSTALLATION AND OPERATION OF THE SYSTEMS INDICATED ON THE CONTRACT DOCUMENTS AND DRAWINGS EVEN IF NOT SPECIFICALLY SHOWN.
  3. THE DRAWINGS ARE, IN PART, DIAGRAMMATIC AND DO NOT ALWAYS SHOW ALL NECESSARY MATERIALS AND EQUIPMENT TO SCALE OR IN EXACT LOCATIONS. IT IS THE CONTRACTORS RESPONSIBILITY TO CHECK ALL MEASUREMENTS, COORDINATE ALL WORK WITH OTHER TRADES, REVIEW ALL ARCHITECTURAL AND STRUCTURAL DRAWINGS, AND VISIT THE JOBSITE TO MAKE APPROPRIATE MEASUREMENTS.
  4. CONTRACTOR SHALL OBTAIN ALL NECESSARY PERMITS AND INSPECTIONS AND SHALL PAY ALL ASSOCIATED FEES FOR SCOPE OF WORK.
  5. WHEN THE SPECIFICATIONS OR DRAWINGS ARE UNCLEAR OR IN CONFLICT WITH CODES OR OTHER TRADES, THE CONTRACTOR SHALL BRING THIS TO THE ATTENTION OF THE ENGINEER FOR CLARIFICATION BEFORE SUBMITTING A BID.
  6. SUBMITTALS AND SHOP DRAWINGS FOR ALL EQUIPMENT, MATERIALS, AND ACCESSORIES SHALL BE PROVIDED TO THE OWNER AND ENGINEER FOR REVIEW AND COMMENT PRIOR TO ORDER, MANUFACTURE, FABRICATION, AND INSTALLATION. FAILURE TO DO SO SHALL NOT RELIEVE THIS CONTRACTOR OF THE RESPONSIBILITY, CONSEQUENCES, AND POSSIBLE COSTS OF SUCH ACTION OR LACK OF ACTION REGARDLESS OF ANY AND ALL ERRORS OR OMISSIONS ON THESE DOCUMENTS. THIS ENGINEER SHALL NOT BE HELD LIABLE FOR ANY COSTS ASSOCIATED WITH THIS CONTRACTOR'S FAILURE TO COMPLY WITH THIS ITEM. IF SUBSTITUTIONS FOR SPECIFIED ITEMS ARE MADE, IT IS THIS CONTRACTOR'S RESPONSIBILITY TO PROVE PERFORMANCE, COMPATIBILITY, AND CONFORMANCE WITH THE ORIGINAL DESIGN AND SPECIFICATIONS. RE-DESIGN BY THIS ENGINEER TO ACCOMMODATE SUBSTITUTIONS SHALL NOT BE PERFORMED. OTHERWISE, IT WILL BE CONSIDERED ADDITIONAL WORK FOR WHICH COMPENSATION WILL BE REQUIRED.
  7. ALL ACTUAL EQUIPMENT, MATERIALS, AND ACCESSORIES TO BE INSTALLED SHALL BE FULLY COORDINATED WITH THE ELECTRICAL, PLUMBING, CIVIL, STRUCTURAL, AND ARCHITECTURAL CONTRACTORS PRIOR TO ORDER, MANUFACTURE, FABRICATION, AND INSTALLATION. THIS INCLUDES BUT IS NOT LIMITED TO ELECTRICAL DATA, WEIGHTS, PLUMBING REQUIREMENTS, DIMENSIONS, PENETRATIONS, ETC. FAILURE TO DO SO SHALL NOT RELIEVE THIS CONTRACTOR OF THE RESPONSIBILITY, CONSEQUENCES, AND POSSIBLE COSTS OF SUCH ACTION OR LACK OF ACTION REGARDLESS OF ANY AND ALL ERRORS OR OMISSIONS ON THESE DOCUMENTS. THIS ENGINEER SHALL NOT BE HELD LIABLE FOR ANY COSTS ASSOCIATED WITH THIS CONTRACTORS FAILURE TO COMPLY WITH THIS ITEM.
  8. ANY AND ALL DEVIATIONS FROM THE DESIGN DOCUMENTS WITHOUT THIS ENGINEER'S APPROVAL INDICATES ACCEPTANCE BY THIS CONTRACTOR AND/OR OWNER FOR THE RESPONSIBILITY OF THE PERFORMANCE OF THE SYSTEM AFFECTED. THIS ENGINEER SHALL NOT BE HELD LIABLE FOR ANY COSTS ASSOCIATED WITH THIS CONTRACTOR'S FAILURE TO FOLLOW THE DESIGN DOCUMENTS. IF MODIFICATIONS TO THE SPECIFIED DESIGN ARE MADE, IT IS THIS CONTRACTOR'S RESPONSIBILITY TO PROVE PERFORMANCE, COMPATIBILITY, AND CONFORMANCE WITH THE ORIGINAL DESIGN AND SPECIFICATIONS. RE-DESIGN BY THIS ENGINEER TO ACCOMMODATE MODIFICATIONS SHALL NOT BE PERFORMED. OTHERWISE, IT WILL BE CONSIDERED ADDITIONAL WORK FOR WHICH COMPENSATION WILL BE REQUIRED. SITE VISITS, INSPECTIONS, CALCULATIONS, COORDINATION, ETC. PERFORMED BY THIS ENGINEER TO INVESTIGATE PROBLEMS ASSOCIATED WITH DESIGN DEVIATIONS WILL ALSO BE CONSIDERED ADDITIONAL WORK FOR WHICH COMPENSATION WILL BE REQUIRED.
  9. ANY ERRORS OR OMISSIONS ON THESE DOCUMENTS SHALL BE IMMEDIATELY BROUGHT TO THE ATTENTION OF THE ENGINEER FOR REVIEW AND CORRECTION.
  10. THE CONSTRUCTION DOCUMENTS ARE COMPRISED OF BOTH DRAWINGS AND SPECIFICATIONS (PROJECT MANUAL). ALL TRADES ARE INTERDEPENDENT AND MUST BE FULLY COORDINATED TO PROVIDE A COMPLETE PROJECT. THE GENERAL CONTRACTOR SHALL NOT BREAK OUT INDIVIDUAL SECTIONS TO SUB-CONTRACTORS OR VENDORS.
  11. THE CONTRACTOR IS RESPONSIBLE FOR COORDINATING WORK OF ALL TRADES TO INSURE A USABLE & FUNCTIONAL END PRODUCT. ANY CONFLICTS BETWEEN THE DRAWINGS AND SPECIFICATIONS SHALL BE CLARIFIED BY THE ARCHITECT/ENGINEER. IF NO CLARIFICATION IS ISSUED THE BIDDER SHALL BID THE MOST STRINGENT PRODUCT OR APPLICATION.
  12. IF DISCREPANCIES ARE ENCOUNTERED BETWEEN THE DRAWINGS AND SPECIFICATIONS, THE MOST STRINGENT PRODUCT OR APPLICATION OVERRIDES IN ALL CASES.
  13. THIS ENGINEER SHALL NOT BE HELD LIABLE FOR COSTS ASSOCIATED WITH ERRORS AND/OR OMISSIONS ON THESE DOCUMENTS IN EXCESS OF THE COST AND/OR TIME FOR THIS ENGINEER TO CORRECT THE DOCUMENTS. IN ANY CASE, THE LIMIT OF LIABILITY FOR THIS ENGINEER SHALL BE NO MORE THAN THE COST OF THIS ENGINEER'S INDIVIDUAL FEE, REGARDLESS OF THE TOTAL DESIGN FEE CHARGED FOR THE SET OF CONSTRUCTION DOCUMENTS.
  14. TO THE FULLEST EXTENT PERMITTED BY LAW, THE TOTAL LIABILITY IN THE AGGREGATE, OF THIS ENGINEER AND THIS ENGINEER'S OFFICERS, DIRECTORS, EMPLOYEES, AGENTS, AND INDEPENDENT PROFESSIONAL ASSOCIATES, AND ANY OF THEM, TO OWNER AND ANY ONE CLAIMING BY, THROUGH OR UNDER OWNER, FOR ANY AND ALL INJURIES, CLAIMS, LOSSES, EXPENSES, OR DAMAGES WHATSOEVER ARISING OUT OF OR IN ANY WAY RELATED TO THIS ENGINEER'S SERVICES, THE PROJECT OR THESE DOCUMENTS, FROM ANY CAUSE OR CAUSES WHATSOEVER, INCLUDING BUT NOT LIMITED TO, THE NEGLIGENCE, ERRORS, OMISSIONS, STRICT LIABILITY, BREACH OF CONTRACT, MISREPRESENTATION, OR BREACH OF WARRANTY OF THIS ENGINEER; OR THIS ENGINEER'S OFFICERS, DIRECTORS, EMPLOYEES, AGENTS OR INDEPENDENT PROFESSIONAL ASSOCIATES, OR ANY OF THEM, SHALL NOT EXCEED THE TOTAL COMPENSATION RECEIVED BY THIS ENGINEER FOR SERVICES PROVIDED.
  15. THE USE OF THESE DOCUMENTS FOR CONSTRUCTION SIGNIFIES THIS OWNER, TENANT, AND CONTRACTORS AGREEMENT WITH THE ABOVE REQUIREMENTS REGARDLESS OF ANY OTHER PRIOR, CURRENT, OR FUTURE AGREEMENT AND/OR CONTRACT.
  16. ALL EQUIPMENT, PRODUCTS, MATERIALS, COMPONENTS, ACCESSORIES, ETC. SHALL BE MANUFACTURED IN THE USA.
- ### B. DUCTWORK
1. TURNING VANES SHALL BE INSTALLED IN ALL RECTANGULAR/SQUARE ELBOWS AND TEES 45° OR LARGER.
  2. ALL DUCTWORK SHALL BE SHEET METAL CONSTRUCTION.
  3. ALL SHEET METAL DUCT CONNECTIONS TO ANY FAN POWERED EQUIPMENT SHALL BE MADE WITH FLEXIBLE DUCT CONNECTORS 3" MIN IN LENGTH.
  4. LOW PRESSURE DUCTWORK
    - a. ALL SUPPLY DUCTWORK AND RETURN DUCTWORK SHALL BE CONSTRUCTED TO 2" WG PRESSURE CLASS STANDARDS AND SHALL CONFORM TO THE LATEST EDITIONS OF THE SMACNA DUCT CONSTRUCTION STANDARDS.
    - b. ALL SUPPLY, RETURN, AND EXHAUST DUCTWORK SHALL BE GALVANIZED SHEET METAL CONSTRUCTION UNLESS OTHERWISE NOTED IN THIS SECTION. SHEET METAL GAUGE SHALL BE AS PER SMACNA DUCT CONSTRUCTION STANDARDS (28 GAUGE OR LESS DEPENDING ON SIZE AND SHAPE). 30 GAUGE OR HIGHER SHEET METAL DUCT IS NOT ACCEPTABLE.

- c. ALL EXTERNALLY INSULATED SHEET METAL DUCTWORK JOINTS SHALL BE SEALED AIRTIGHT WITH MASTIC AND TAPED OVER WITH DUCT TAPE. ALL INTERNALLY INSULATED SHEET METAL DUCTWORK JOINTS SHALL BE SEALED AIRTIGHT WITH MASTIC AND THE EXTERIOR SURFACE WIPED CLEAN TO PROVIDE A FINISHED APPEARANCE.
- d. ALL SQUARE AND RECTANGULAR VOLUME DAMPERS SHALL BE OPPOSED BLADE TYPE.

### C. INSULATION

1. ALL SUPPLY, RETURN, AND OUTDOOR AIR DUCTWORK SHALL BE INSULATED.
  2. ALL EXPOSED SUPPLY, RETURN, AND OUTDOOR AIR DUCTWORK SHALL BE SHEET METAL CONSTRUCTION AND SHALL BE INTERNALLY INSULATED.
  3. ALL CONCEALED SHEET METAL AND FLEXIBLE SUPPLY, RETURN, AND OUTDOOR AIR DUCTWORK SHALL BE EXTERNALLY INSULATED. UNLESS INTERNALLY LINED.
  4. INTERNAL DUCT INSULATION
    - a. WHERE INDICATED ON THE PLANS, SHEET METAL DUCTWORK SHALL BE INTERNALLY LINED WITH INSULATION.
    - b. WHEN INSTALLED IN FULLY CONDITIONED SPACES AND RETURN AIR PLENUMS WITHIN THE INSULATED AND/OR CONDITIONED ENVELOPE, INTERNAL INSULATION SHALL BE 1" THICK UNLESS OTHERWISE SPECIFIED.
    - c. THE FIRST 10'-0" OF RECTANGULAR/SQUARE SHEET METAL DUCT UPSTREAM OR DOWNSTREAM OF ANY FAN SHALL BE INTERNALLY INSULATED WHETHER OR NOT INDICATED IN PLAN.
  5. ALL SUPPLY, RETURN, AND OUTDOOR AIR DUCTWORK SHALL BE EXTERNALLY INSULATED WITH 2" THICK INSULATION (R=6.0), UNLESS INTERNALLY LINED. ALL JOINTS SHALL BE SEALED.
  6. ALL CONDENSATE PIPING WITHIN THE BUILDING ENVELOPE, INCLUDING PRIMARY AND SECONDARY LINES, SHALL BE INSULATED WITH 1/2" THICK PIPE INSULATION. ALL JOINTS SHALL BE SEALED.
  7. REFRIGERANT SUCTION PIPING LESS THAN 1-1/2" SHALL BE INSULATED WITH 1/2" THICK FLEXIBLE CELLULAR INSULATION. PIPING 1-1/2" OR LARGER SHALL BE INSULATED WITH 1" THICK INSULATION. ALL JOINTS SHALL BE SEALED. LIQUID LINES SHALL BE INSULATED WHEN INSTALLED WITHIN THE BUILDING IN UNCONDITIONED SPACES OUTSIDE OF THE INSULATED AND/OR CONDITIONED ENVELOPE.
  8. EXPOSED EXTERIOR PIPE INSULATION SHALL BE JACKETED WITH ALUMINUM AND SEALED WEATHER TIGHT.
- ### D. REFRIGERANT PIPING
1. ALL REFRIGERANT PIPING 1-3/8" AND SMALLER SHALL BE TYPE L-ACR OR TYPE K-ACR HARD DRAWN OR SOFT (AS INDICATED) COPPER UL RATED FOR 700 PSI AT 250°F AND CONFORMING TO ASTM STANDARD B280.
  2. ALL REFRIGERANT PIPING LARGER THAN 1-3/8" AND 2-5/8" OR LESS SHALL BE TYPE K-ACR HARD DRAWN OR SOFT (AS INDICATED) COPPER UL RATED TO 700 PSI AT 250°F AND CONFORMING TO ASTM STANDARD B280.
  3. ALL REFRIGERANT PIPE FITTINGS SHALL BE WROT COPPER UL RATED TO 700 PSI AT 250°F AND SHALL MEET ANSI/ASME STANDARD B16.22 AND NSF 61G.
  4. ALL STRAIGHT RUNS OF REFRIGERANT PIPING SHALL BE SLOPED 1/8" PER FOOT MIN IN THE DIRECTION OF FLOW.
  5. IF SOFT COPPER TUBING IS USED, IT SHALL BE INSTALLED AS STRAIGHT AS POSSIBLE WITHOUT EXCESSIVE BENDS, KINKS, OR OTHER OBSTRUCTIONS.
- ### E. THERMOSTATS SHALL BE COMPATIBLE WITH SCHOOL CONTROL SYSTEM.
- ### F. A CERTIFIED TEST AND BALANCE SHALL BE PERFORMED BY A CERTIFIED, 3RD PARTY TEST AND BALANCE COMPANY. INDIVIDUAL GRILLES SHALL BE BALANCED TO WITHIN 10% OF THE DESIGN AIR FLOWS AND UNITS SHALL BE BALANCED TO WITHIN 5% OF THE DESIGN AIR FLOWS. PUMPS SHALL BE BALANCED TO WITHIN 5% OF THE DESIGN FLOW. THE TEST AND BALANCE REPORT SHALL BE PROVIDED TO THE OWNER AND THIS ENGINEER FOR REVIEW AND COMMENT.
- ### G. ALL LINE VOLTAGE (120V, 240V, 460V, ETC.) CONTROLS (SWITCHES, TIME CLOCKS, ETC.), ACCESSORIES, AND INTERCONNECTING WIRING SHALL BE PROVIDED AND INSTALLED BY THE ELECTRICAL CONTRACTOR EXCEPT THAT ALL DAMPER ACTUATORS SHALL BE PROVIDED AND INSTALLED BY THE MECHANICAL CONTRACTOR. ALL LOW VOLTAGE (24V, ETC.) CONTROLS (THERMOSTATS, ETC.), ACCESSORIES, AND INTERCONNECTING WIRING SHALL BE PROVIDED AND INSTALLED BY THE MECHANICAL CONTRACTOR EXCEPT THAT ALL ASSOCIATED SMOKE AND FIRE ALARM WIRING SHALL BE PROVIDED AND INSTALLED BY THE FIRE ALARM CONTRACTOR. ALL NECESSARY TRANSFORMERS (120V TO 24V, ETC.) SHALL BE PROVIDED AND INSTALLED BY THE MECHANICAL CONTRACTOR OR THEIR CONTROLS SUBCONTRACTOR. COORDINATE ALL WORK WITH THE ELECTRICAL AND FIRE ALARM CONTRACTORS.

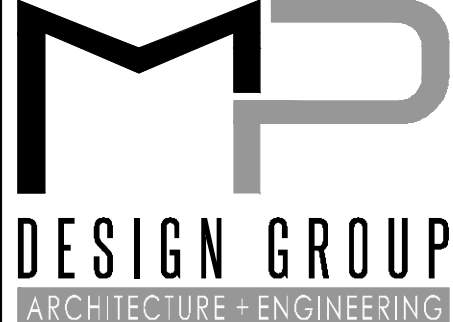
### H. REFRIGERANT SYSTEM TESTS

1. PRESSURE TEST
  - a. INTERCONNECTING PIPING
    - a.1. EVACUATE ALL REFRIGERANT FROM THE SYSTEM.
    - a.2. ISOLATE THE COMPONENT INTERCONNECTING PIPING AND CHARGE WITH DRY, OXYGEN FREE NITROGEN (O<sub>2</sub>N) TO 1.3 TIMES THE MAXIMUM ALLOWABLE PRESSURE OF THE SYSTEM COMPONENTS. MAINTAIN PRESSURE FOR 12 HOURS. IF LOSS OF PRESSURE OCCURS, LOCATE AND REPAIR LEAKS AND REPEAT TEST PROCEDURE.
  - b. ENTIRE SYSTEM
    - b.1. EVACUATE ALL REFRIGERANT FROM THE SYSTEM.
    - b.2. CHARGE SYSTEM WITH DRY OFN TO THE MAXIMUM ALLOWABLE PRESSURE OF THE SYSTEM COMPONENTS. MAINTAIN PRESSURE FOR 12 HOURS. IF LOSS OF PRESSURE OCCURS, LOCATE AND REPAIR LEAKS AND REPEAT TEST PROCEDURE.
2. VACUUM TEST
  - a. FOLLOWING SUCCESSFUL PRESSURE TESTING, EVACUATE THE SYSTEM TO 1500 MICRON. BREAK THE VACUUM WITH DRY OFN TO 1 BAR. REPEAT ONCE.
  - b. CONTINUOUSLY EVACUATE THE SYSTEM TO BETWEEN 300 MICRON AND 500 MICRON FOR A MINIMUM OF 1 HOUR. INSPECT VACUUM PUMP FOR SIGNS OF MOISTURE DISCHARGE. CONTINUE EVACUATION AND INSPECT AT 1 HOUR INTERVALS UNTIL MOISTURE IS NOT PRESENT.
  - c. MAINTAIN VACUUM FOR FOR 12 HOURS. IF LOSS OF VACUUM OCCURS, REPEAT TEST PROCEDURE.
3. FOLLOWING SUCCESSFUL PRESSURE AND VACUUM TESTING, CHARGE SYSTEM WITH NEW REFRIGERANT. RECOVERED, RECYCLED, OR RECLAIMED REFRIGERANT SHALL BE TREATED TO REMOVE MOISTURE, OIL, ACID, AND PARTICULATE MATTER PRIOR TO USE.

4. DOCUMENT TESTING AND PROVIDE TO OWNER. INSPECTION BY LOCAL AUTHORITY MAY BE REQUIRED.


### I. CONDENSATE PIPING

1. ALL CONDENSATE PIPING SHALL BE PROVIDED AND INSTALLED BY THE MECHANICAL CONTRACTOR.
2. MATERIAL
  - a. INTERIOR CONDENSATE PIPING SHALL BE APPROVED, SCHEDULE 40 PVC WITH PVC FITTINGS AND SOLVENT CEMENT JOINTS UNLESS OTHERWISE NOTED.
  - b. EXTERIOR CONDENSATE PIPING SHALL BE APPROVED, SCHEDULE 80 PVC WITH PVC FITTINGS AND SOLVENT CEMENT JOINTS UNLESS OTHERWISE NOTED.
  - c. WHEN NOTED AND/OR WHEN INSTALLED IN A RETURN AIR PLENUM CONDENSATE PIPING SHALL BE TYPE M COPPER WITH WROT COPPER FITTINGS AND SOLDERED JOINTS.
3. SIZING-CONNECTED LOAD
  - a. 2 TONS OR LESS=3/4"
  - b. MORE THAN 2 TONS TO 5 TONS=1"
  - c. MORE THAN 5 TONS TO 30 TONS=1-1/4"
4. MINIMUM SLOPE
  - a. 2-1/2" OR LESS=1/4" PER FOOT
- J. ALL PIPING SHALL BE LABELED IN ACCORDANCE WITH ASTM STANDARD A13.1. LABELS SHALL INCLUDE PIPING SERVICE (REFRIGERANT SUCTION, REFRIGERANT LIQUID, CONDENSATE, ETC.), SIZE, AND DIRECTION OF FLOW.
- K. COORDINATE ALL REQUIRED WALL, FLOOR, CEILING, AND ROOF PENETRATION LOCATIONS AND SIZES WITH THE GC PRIOR TO CONSTRUCTION. GC SHALL PROVIDE ALL REQUIRED FRAMED OPENINGS, HEADERS, MASONRY OPENINGS, LINTELS, ETC. AS NECESSARY.
- L. COORDINATE ALL DUCT LOCATIONS, SIZES, AND ROUTING WITH GC PRIOR TO CONSTRUCTION. GC SHALL PROVIDE A CLEAR PATH THROUGH FRAMING AND MASONRY COMPONENTS TO ACCOMMODATE DUCT ROUTING.
- M. COORDINATE ALL DUCT AND PIPE LOCATIONS, SIZES, AND ROUTING PRIOR TO CONSTRUCTION.
- N. WATER SYSTEMS SHALL BE FLUSHED WITH CLEAN POTABLE WATER PRIOR TO SYSTEM START UP. FOLLOWING SYSTEM TURN OVER TO OWNER TO PREVENT CORROSION, SCALE, BIOLOGICAL CONTAMINANTS, ETC. CHEMICALS AND CONCENTRATIONS USED SHALL BE COMPATIBLE WITH PIPING AND EQUIPMENT MATERIALS.
- O. A QUALIFIED WATER TREATMENT SPECIALIST SHALL TEST AND TREAT ALL CONDENSER WATER SYSTEMS PRIOR TO SYSTEM TURN OVER TO OWNER TO PREVENT CORROSION, SCALE, BIOLOGICAL CONTAMINANTS, ETC. CHEMICALS AND CONCENTRATIONS USED SHALL BE COMPATIBLE WITH PIPING AND EQUIPMENT MATERIALS.
- P. LARGE EQUIPMENT SHALL BE SHIPPED FROM THE FACTORY IN SECTIONS SMALL ENOUGH TO FIT THROUGH ALL OPENINGS REQUIRED FOR INSTALLATION. BREAKDOWN OF EQUIPMENT ON SITE SHALL NOT BE PERMITTED. EQUIPMENT SHALL BE PROVIDED WITH DETAILED FACTORY PROVIDED INSTRUCTIONS FOR REASSEMBLY AND CONTRACTOR SHALL COMPLY WITH ALL REQUIREMENTS, MATERIALS, WORKMANSHIP, ETC. COORDINATE WITH EQUIPMENT MANUFACTURERS, ARCHITECTURAL PLANS, AND WITH GC. REASSEMBLY OF EQUIPMENT SHALL BE PART OF THIS CONTRACT AND NO CHANGE ORDERS SHALL BE ALLOWED FOR FAILURE TO COMPLY WITH THIS SECTION.
- Q. ALL PIPING CONNECTIONS AT MOTORIZED EQUIPMENT SHALL HAVE BRAIDED STAINLESS STEEL FLEXIBLE CONNECTIONS. PROVIDE WITH DIELECTRIC UNIONS FOR COPPER PIPE AND CONNECTIONS.
- R. ALL CONTROL COMPONENTS, ACCESSORIES, AND INTERCONNECTING WIRING SHALL BE PROVIDED AND INSTALLED BY THE MECHANICAL CONTRACTOR OR HIS CONTROLS SUBCONTRACTOR. 120V POWER SHALL BE BROUGHT TO CONTROL COMPONENTS AS NECESSARY BY THE ELECTRICAL CONTRACTOR. COORDINATE ALL WORK WITH THE ELECTRICAL CONTRACTOR.
- S. CONTRACTOR SHALL PROCURE THE SERVICES OF THE SCHOOL'S EXISTING CONTROLS CONTRACTOR (SIEMENS) TO FULLY INTEGRATE THE NEW/REPLACED EQUIPMENT INTO THE EXISTING CONTROL SYSTEM. THIS SHALL INCLUDE ALL PROGRAMMING, CONTROLLERS, CONTROL CABINETS, GRAPHICS, LOW VOLTAGE WIRING, SOFTWARE, HARDWARE, SENSORS, ETC. AS NECESSARY.
- T. THE CONTROLS CONTRACTOR SHALL PROVIDE AND INSTALL ALL LOW VOLTAGE EQUIPMENT, COMPONENTS, AND WIRING.
- U. 120V POWER SHALL BE BROUGHT TO CONTROL COMPONENTS AS NECESSARY BY THE ELECTRICAL CONTRACTOR. COORDINATE ALL WORK WITH THE ELECTRICAL AND FIRE ALARM CONTRACTORS.
- V. VARIABLE FREQUENCY DRIVES (VFDs) SHALL BE PROVIDED BY THE MECHANICAL OR CONTROLS CONTRACTOR AND SHALL BE INSTALLED BY THE ELECTRICAL CONTRACTOR.
- W. LOW VOLTAGE CONTROL WIRING CONDUIT/RACEWAYS SHALL BE PROVIDED AND INSTALLED BY THE CONTROLS CONTRACTOR. ALL LOW VOLTAGE CONTROL WIRING IN EXPOSED AREAS (MECHANICAL ROOMS, ETC.) SHALL BE INSTALLED IN CONDUIT. ALL LOW VOLTAGE CONTROL WIRING IN CONCEALED AREAS (ABOVE CEILINGS, ETC.) SHALL BE PROPERLY SUPPORTED FROM STRUCTURE WITH J-HOOKS.
- X. ALL TEMPERATURE, HUMIDITY, ETC. SENSORS AND PORTS SHALL BE PROVIDED AND INSTALLED BY THE CONTROLS CONTRACTOR.
- Y. ALL NECESSARY 120V TO LOW VOLTAGE TRANSFORMERS SHALL BE PROVIDED AND INSTALLED BY THE CONTROLS CONTRACTOR.
- Z. ION GENERATORS SHALL BE PROVIDED AND INSTALLED BY THE MECHANICAL CONTRACTOR. THEY SHALL BE WIRED BY THE CONTROLS CONTRACTOR.
- AA. CONDENSATE OVERFLOW SWITCHES SHALL BE PROVIDED AND INSTALLED BY THE MECHANICAL CONTRACTOR. THEY SHALL BE WIRED BY THE CONTROLS CONTRACTOR.
- AB. DUCT SMOKE DETECTORS SHALL BE PROVIDED AND INSTALLED BY THE CONTROLS CONTRACTOR. ALL UNITS OVER 2000 CFM SHALL HAVE RETURN DUCT MOUNTED SMOKE DETECTORS. CONTROLS CONTRACTOR SHALL VERIFY ALL RETURN DUCT SMOKE DETECTORS ARE COMPATIBLE WITH THE FIRE ALARM SYSTEM. SMOKE DETECTORS SHALL BE ADDRESSABLE AND ABLE TO BE MONITORED BY THE FIRE ALARM SYSTEM. WIRING FOR SIGNAL TO THE FIRE ALARM PANEL SHALL BE PROVIDED AND INSTALLED BY THE FIRE ALARM CONTRACTOR. COORDINATE WITH FIRE ALARM CONTRACTOR.
- AC. THE ROOFTOP AC UNITS HAVE FACTORY PROVIDED CONTROLLERS. THE CONTROLS CONTRACTOR SHALL PROVIDE AND INSTALL INTEGRATION OF THESE CONTROLLERS INTO THE BAS. COORDINATE WITH THE MANUFACTURER.
- AD. ALL WORK SHALL BE CAREFULLY COORDINATED BETWEEN THE CONTROLS CONTRACTOR, MECHANICAL CONTRACTOR, ELECTRICAL CONTRACTOR, FIRE ALARM CONTRACTOR, TEST AND BALANCE CONTRACTOR, AND ALL WORK DEPICTED ON THE DRAWINGS AND SPECIFICATIONS.
- AE. THE CONTROLS CONTRACTOR SHALL BE COPIED ON ALL EQUIPMENT SUBMITTALS RELATIVE TO THEIR WORK (PUMPS, AC UNITS, COOLING TOWER, ETC.) FOR REVIEW AND COMMENT. COORDINATE WITH MECHANICAL CONTRACTOR.



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**VANCLAVE SCHOOLS HVAC UPGRADES**  
**LOWER ELEMENTARY, MIDDLE,**  
**& HIGH SCHOOLS**  
**12602 HWY 57, 4725 BULLDOG LN,**  
**& 12424 HWY 57**  
**VANCLAVE, MISSISSIPPI 39565**

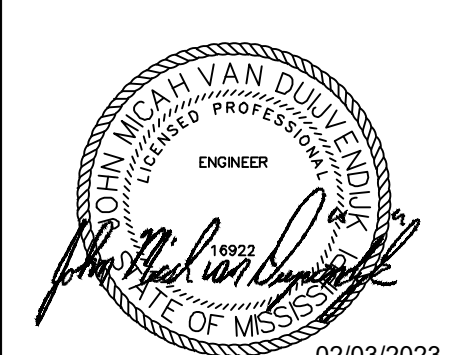SCALE: NONE  
PROJECT NO: 0155.22.008  
DRAWN BY: JMV  
CHECKED BY: JMV

**MECHANICAL NOTES**

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**M002**

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**1 LOWER ELEMENTARY SCHOOL MECHANICAL SITE PLAN**  
 SCALE: 1/32"=1'-0"

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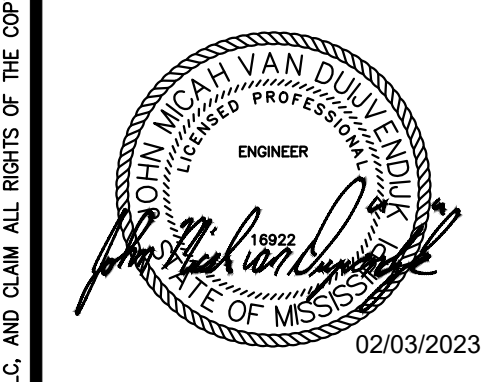
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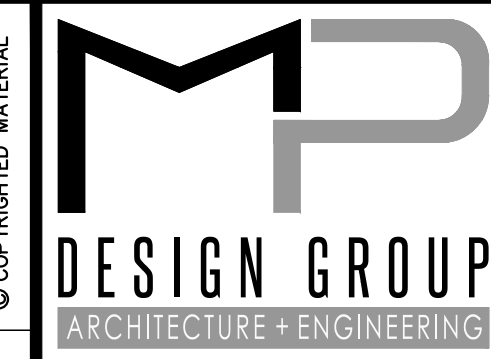
**LOWER ELEMENTARY SCHOOL  
 MECHANICAL SITE PLAN**

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 & HIGH SCHOOLS**  
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1 MIDDLE SCHOOL MECHANICAL SITE PLAN  
 SCALE: 1/32"=1'-0"

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**MIDDLE SCHOOL MECHANICAL SITE PLAN**

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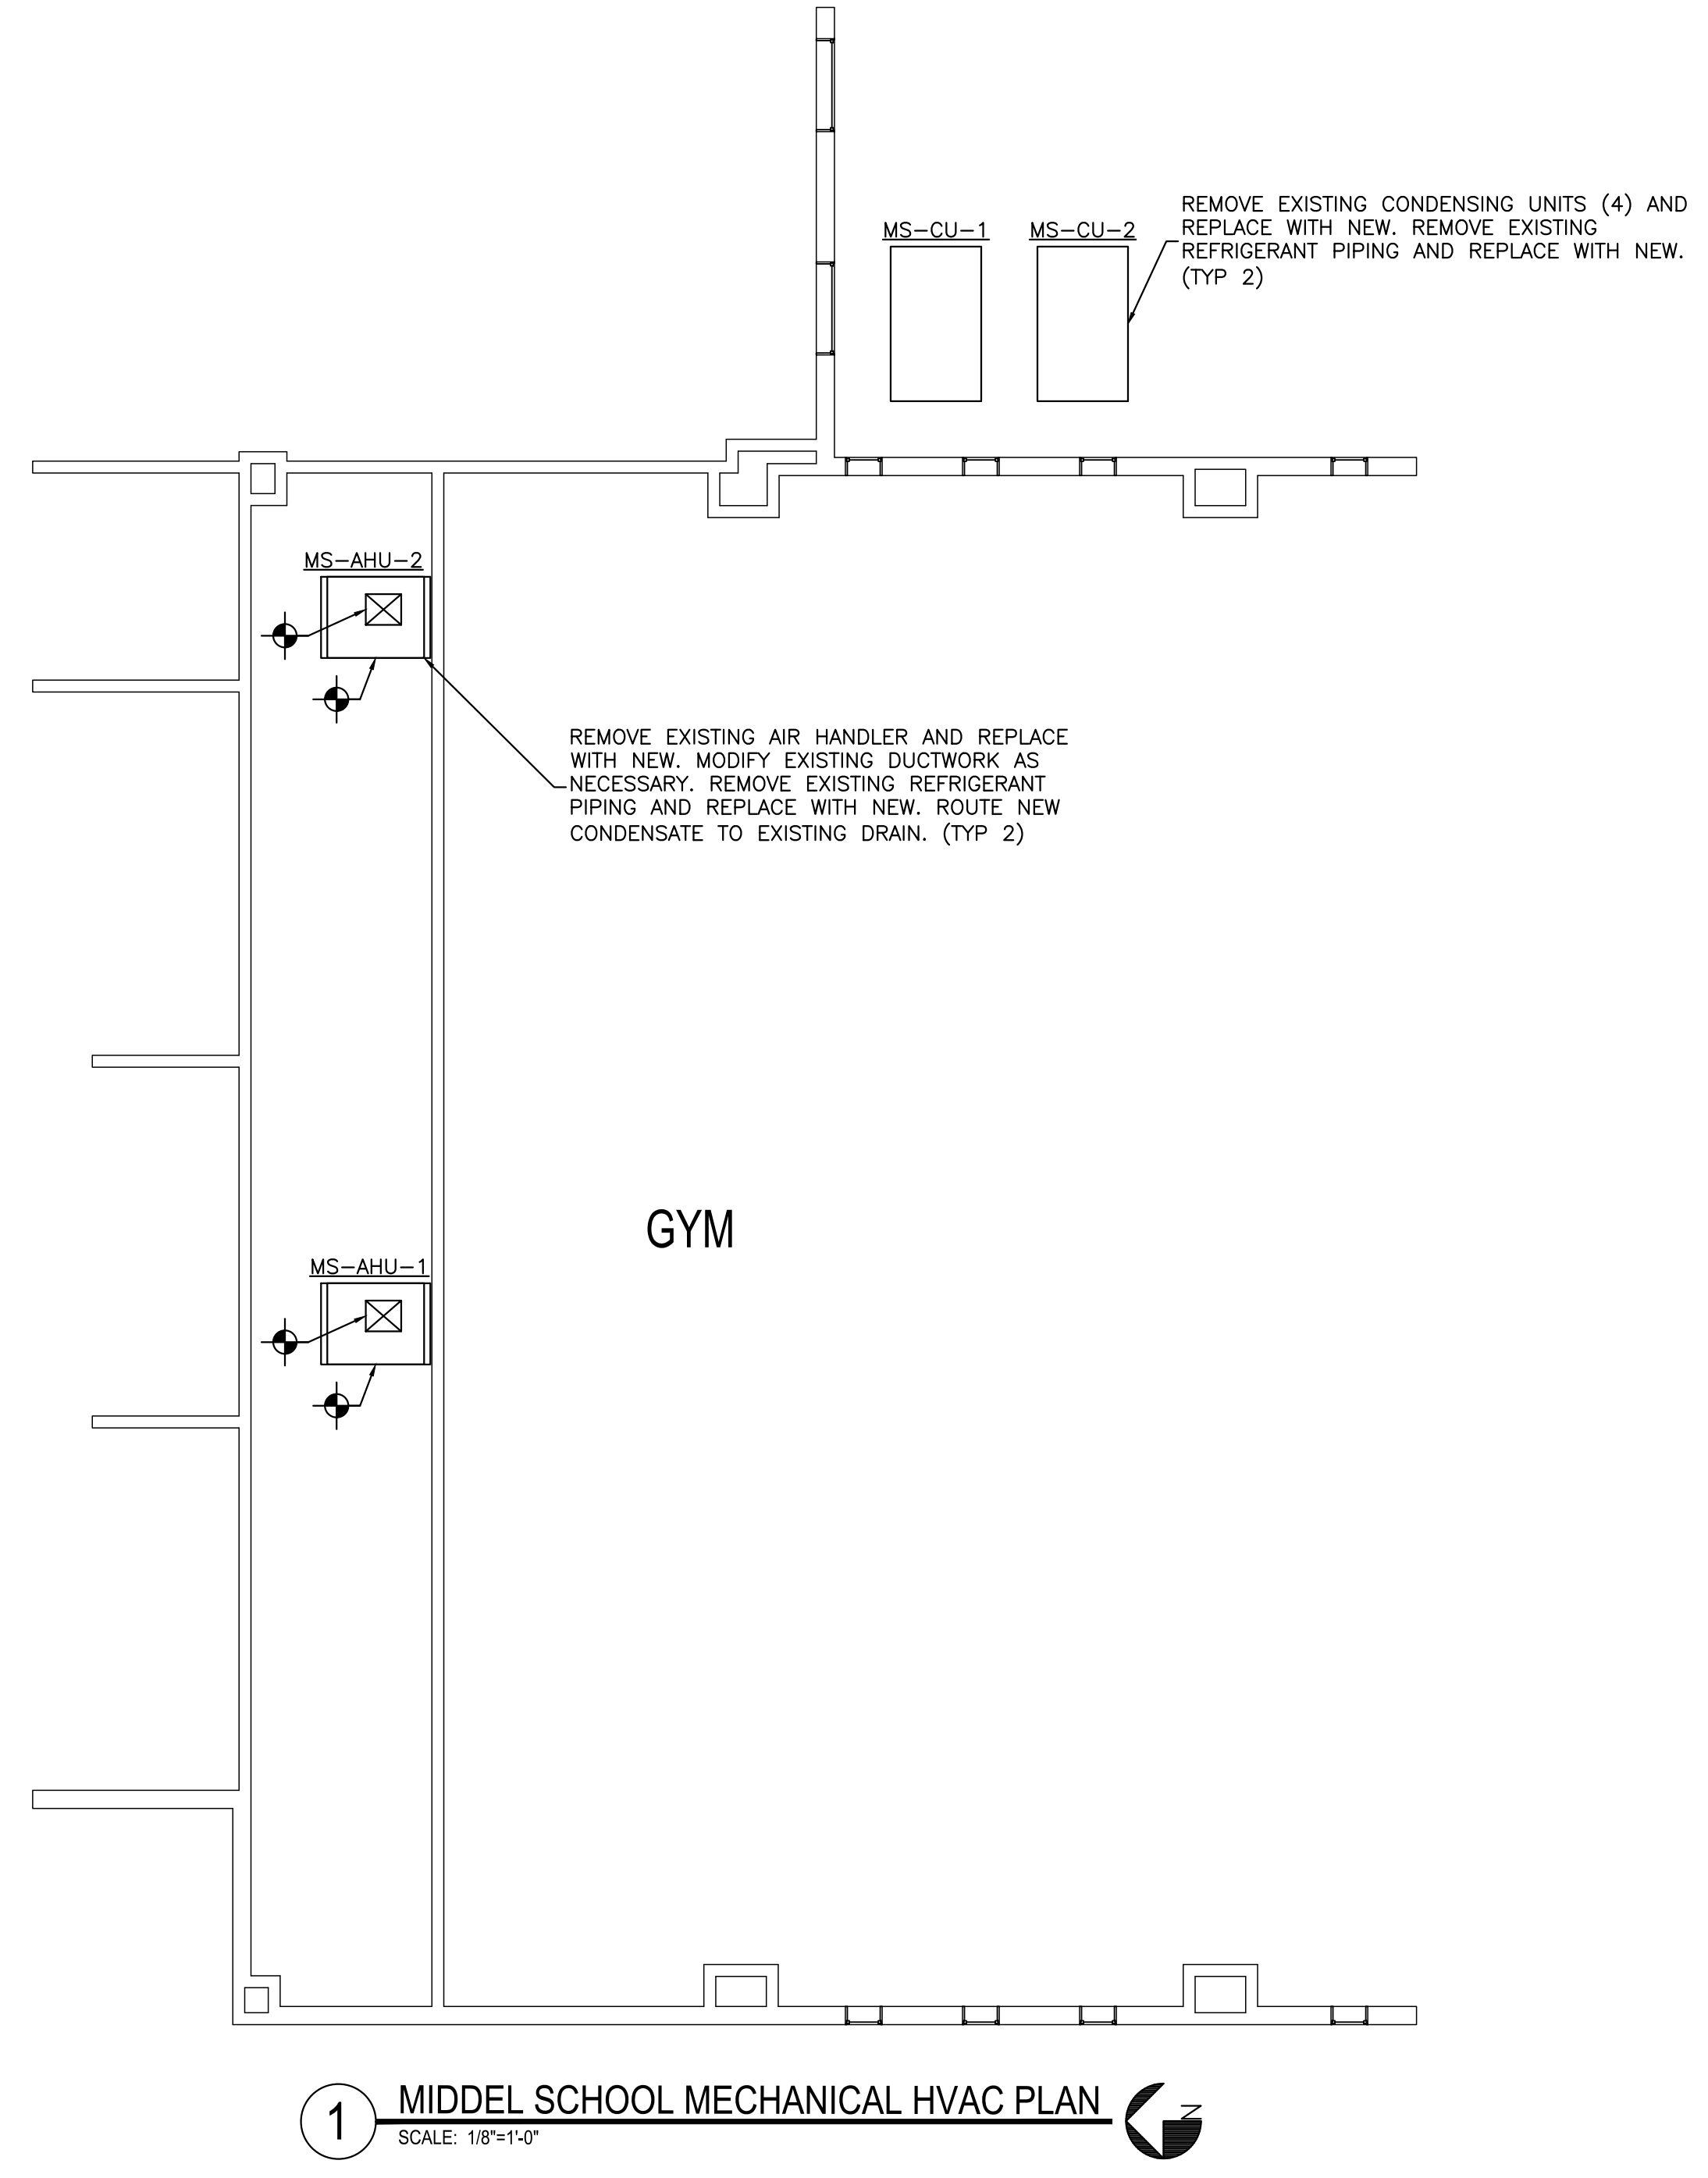




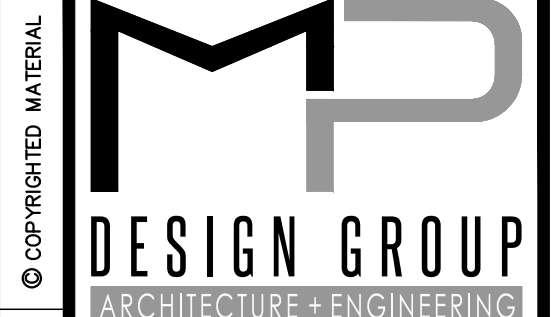




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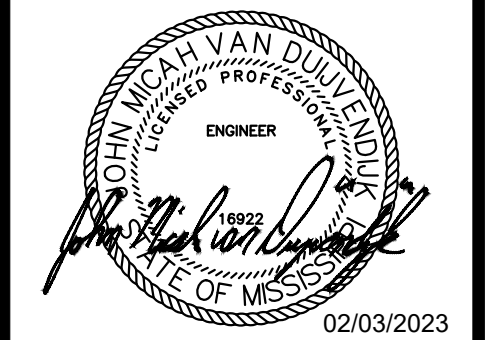


1 MIDDLE SCHOOL MECHANICAL HVAC PLAN  
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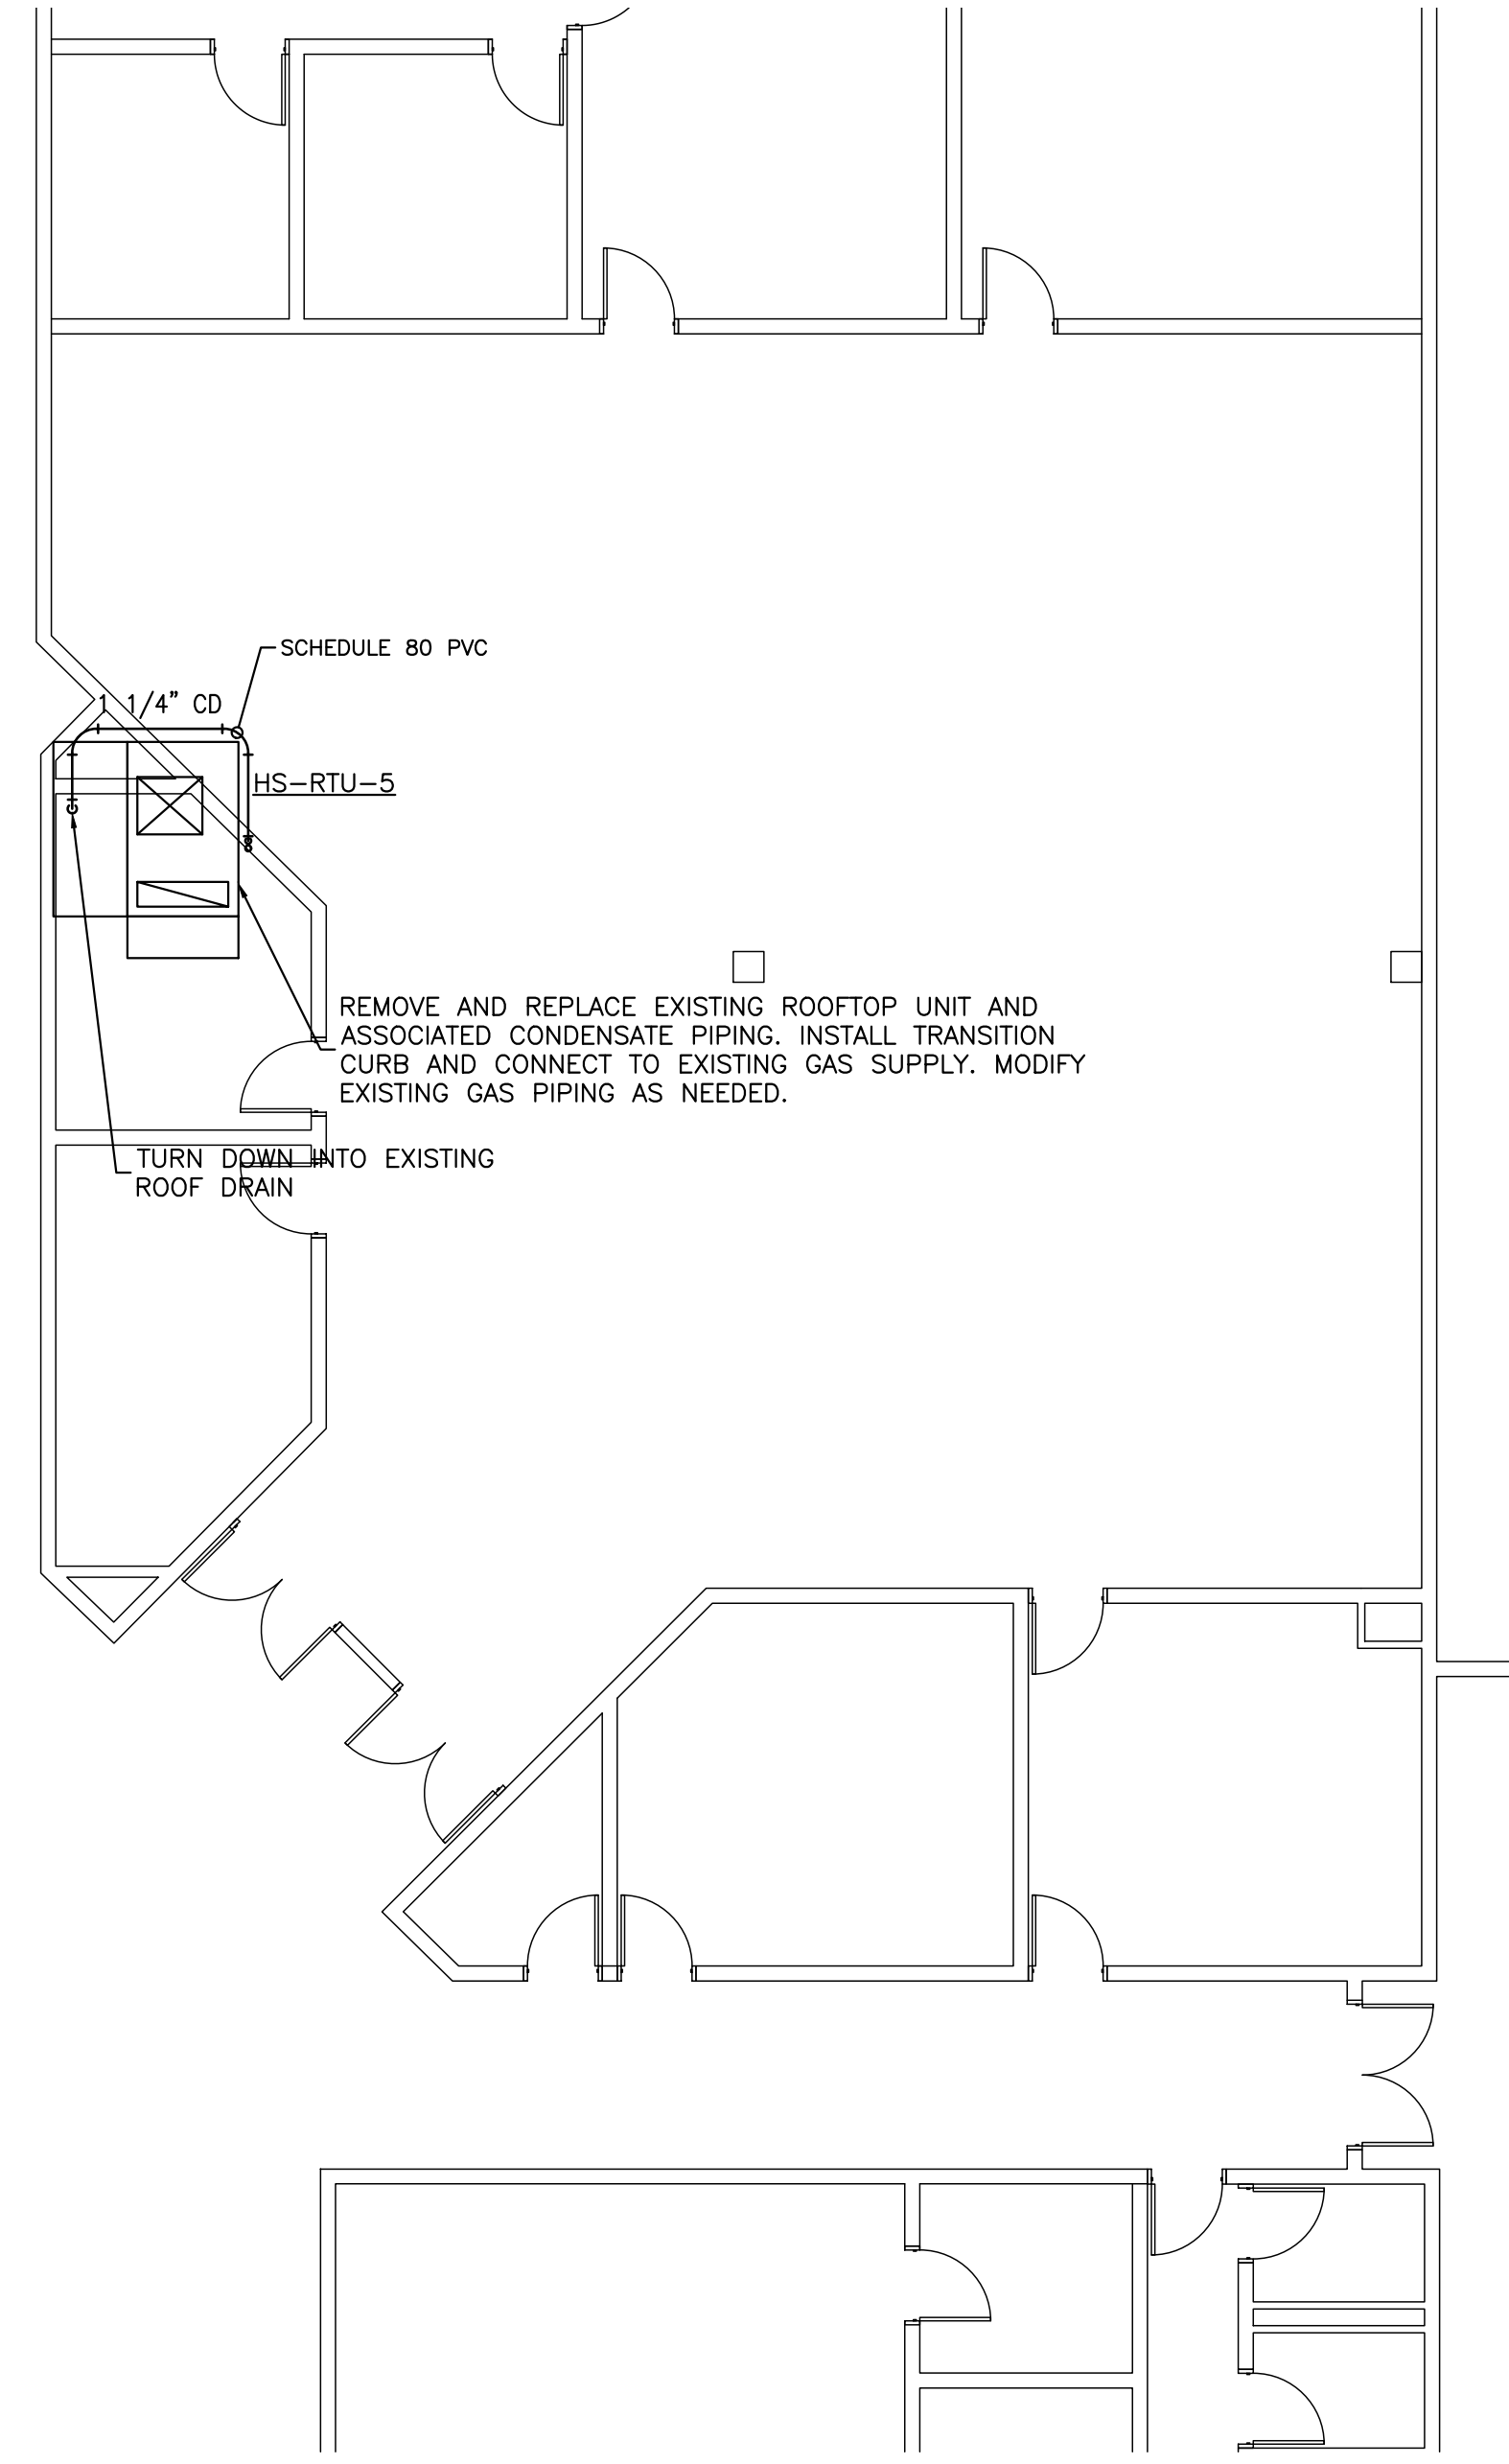
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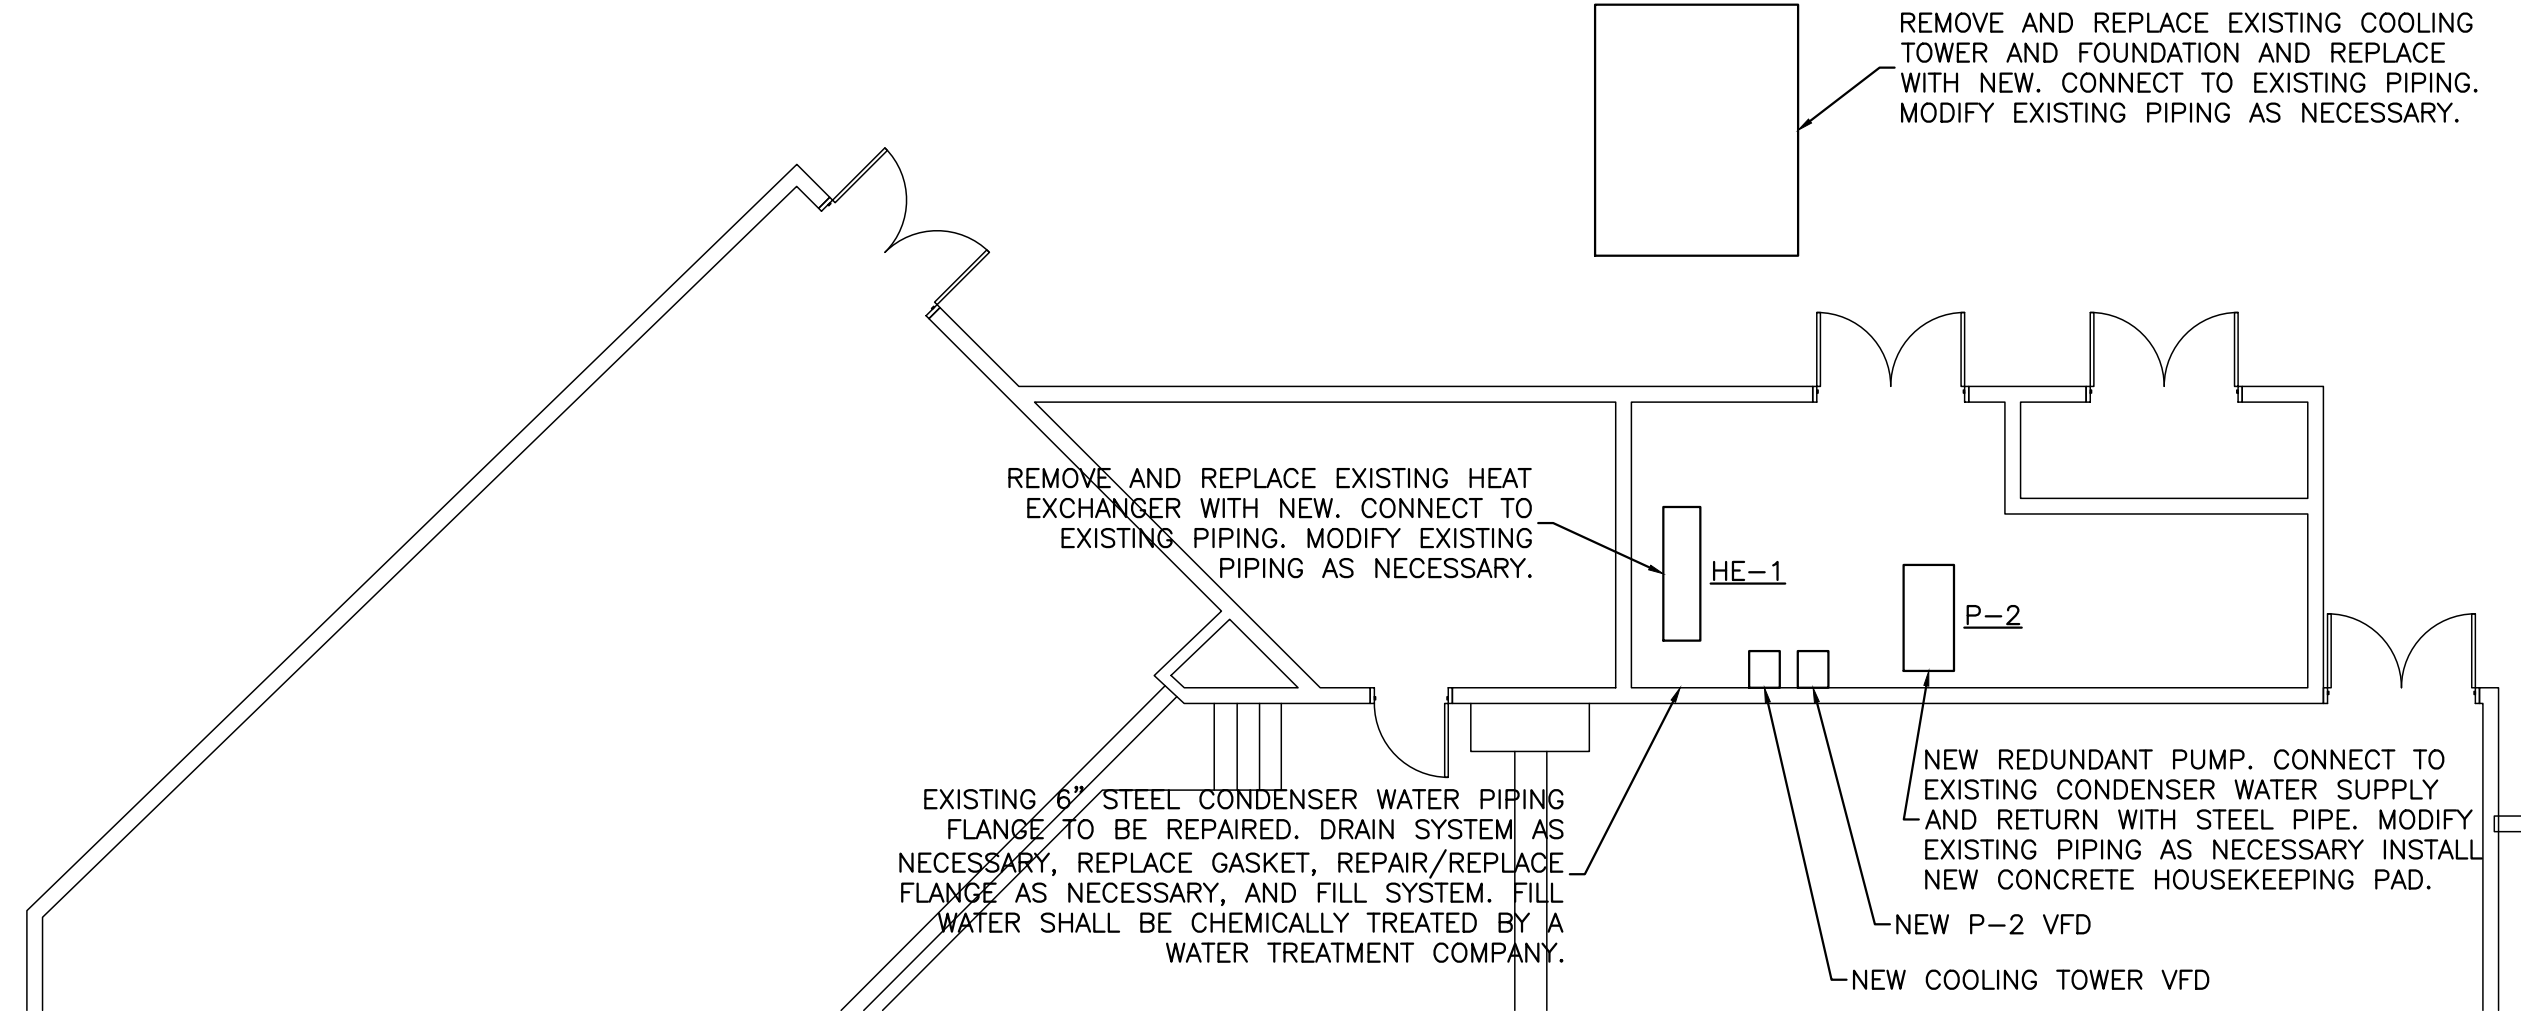


**2** HIGH SCHOOL MECHANICAL HVAC PLAN - LIBRARY  
SCALE: 1/8"=1'-0"



**3** HIGH SCHOOL MECHANICAL HVAC PLAN - GYM  
SCALE: 1/8"=1'-0"

NOTE:  
NEW GAS PIPING SHALL BE SCHEDULE 40 BLACK STEEL AND SHALL INCLUDE SHUTOFF VALVE AND DIRT LEG. PIPING SHALL BE PAINTED WITH A RUST PREVENTATIVE PRIMER AND TWO TOP COATS (YELLOW).



**1** HIGH SCHOOL MECHANICAL HVAC PLAN - COOLING PLANT  
SCALE: 1/8"=1'-0"

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**HIGH SCHOOL MECHANICAL HVAC PLAN**

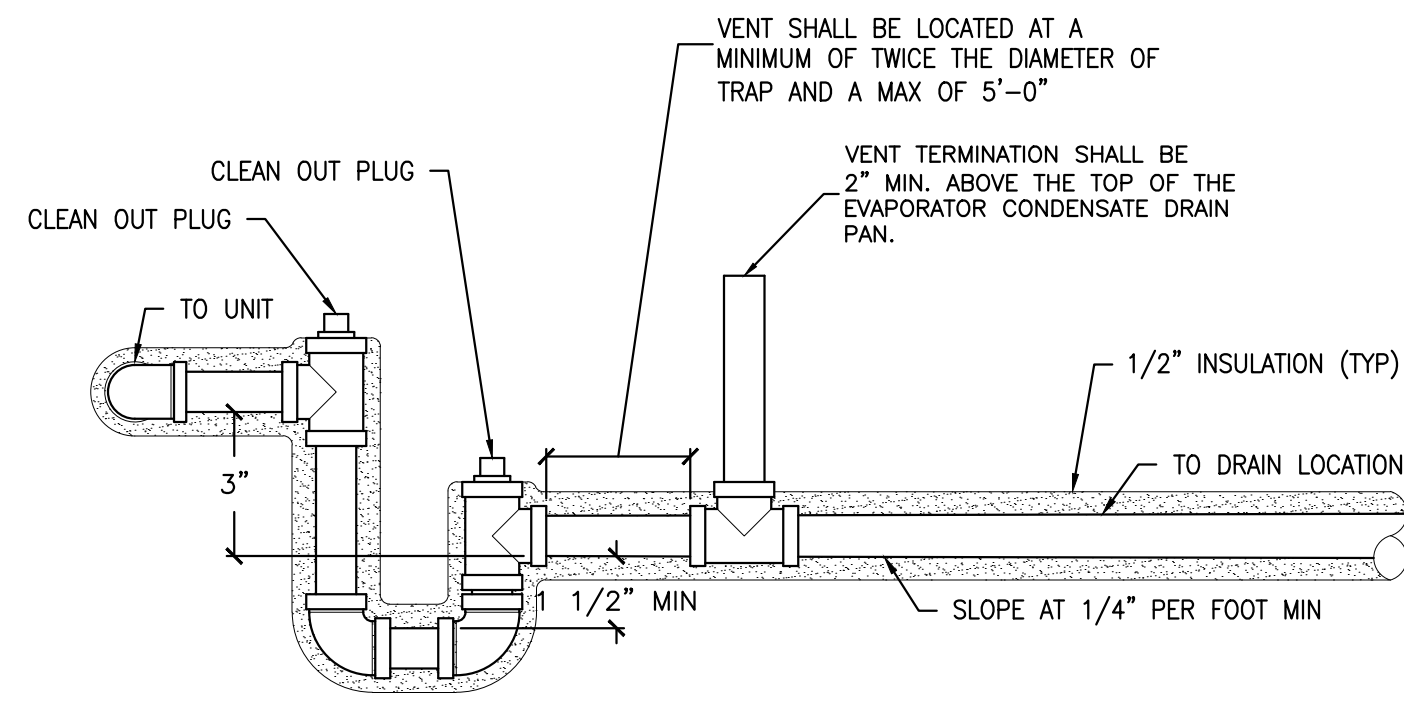
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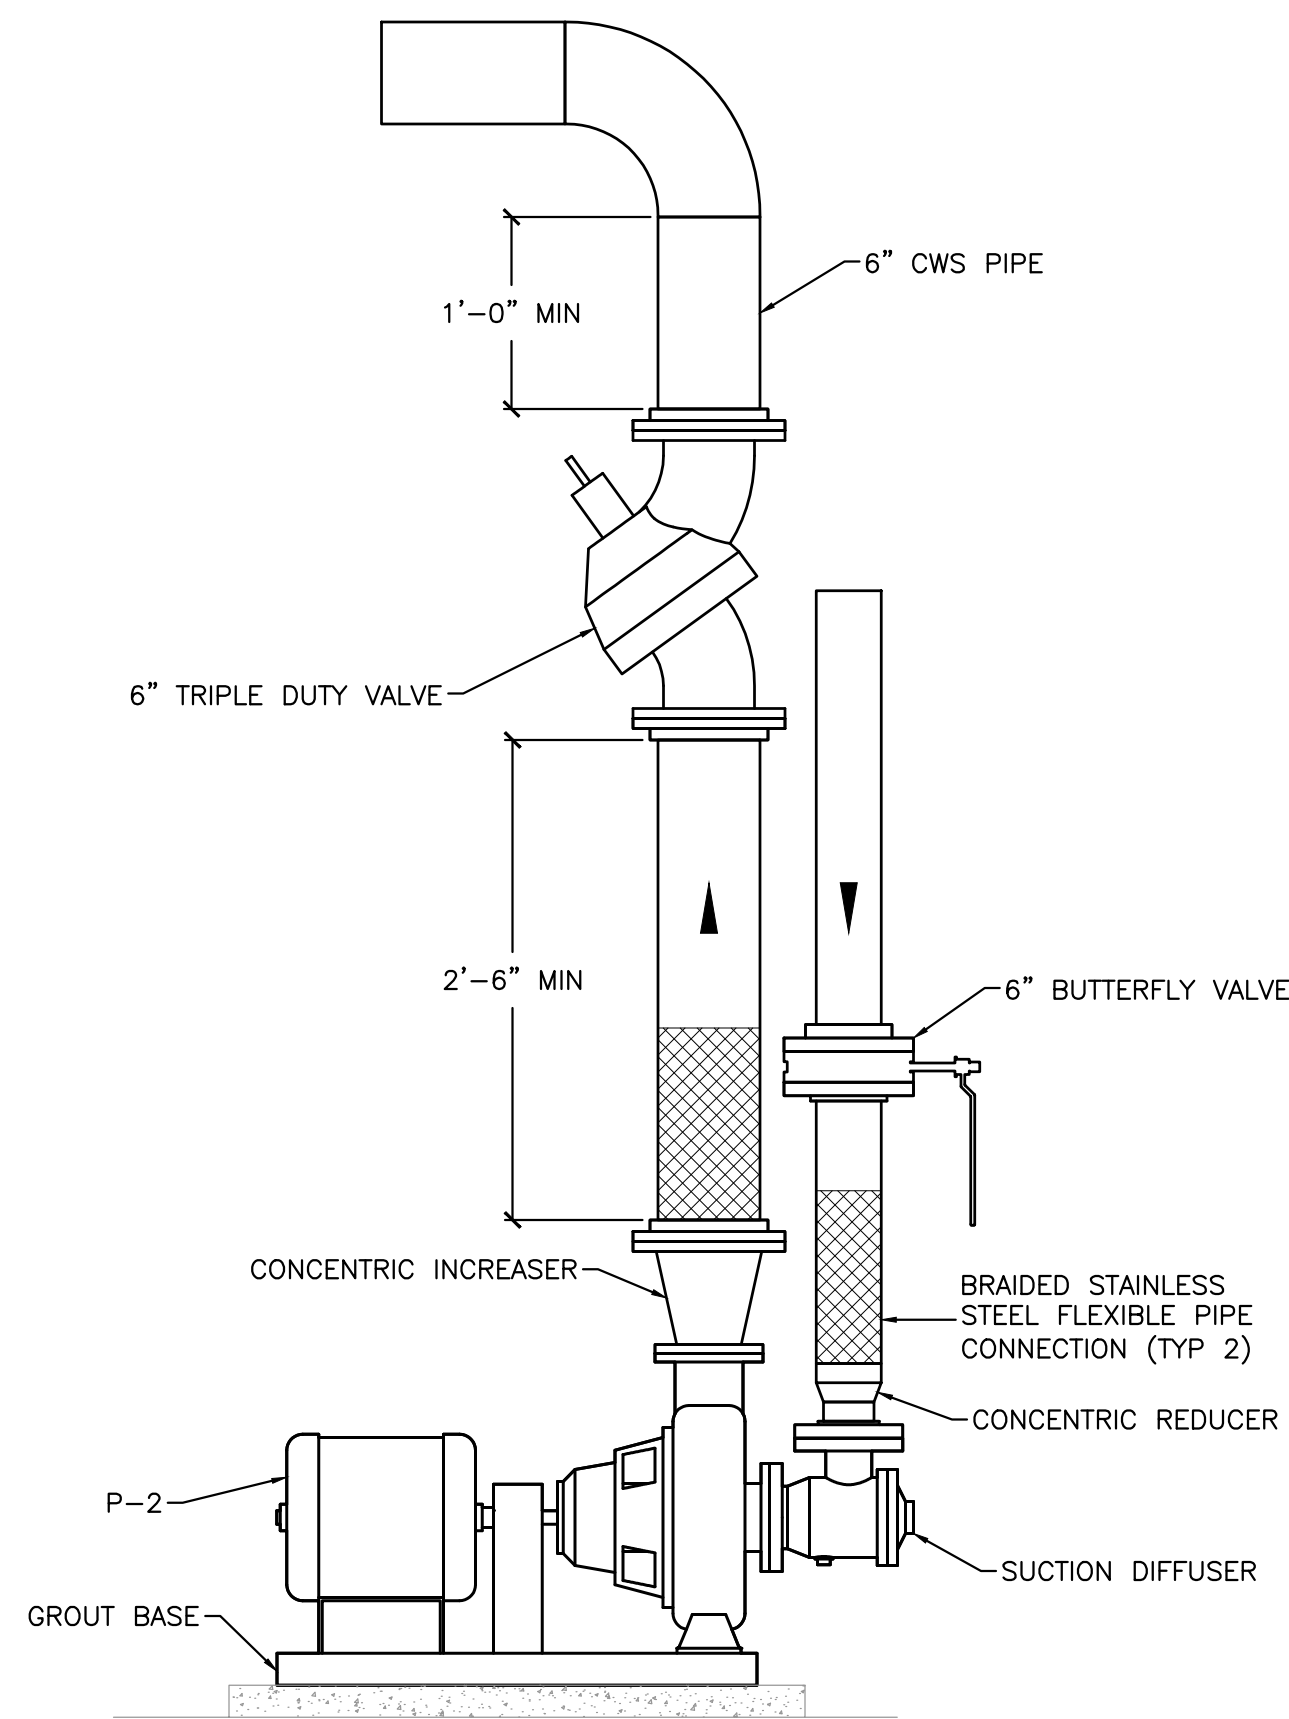
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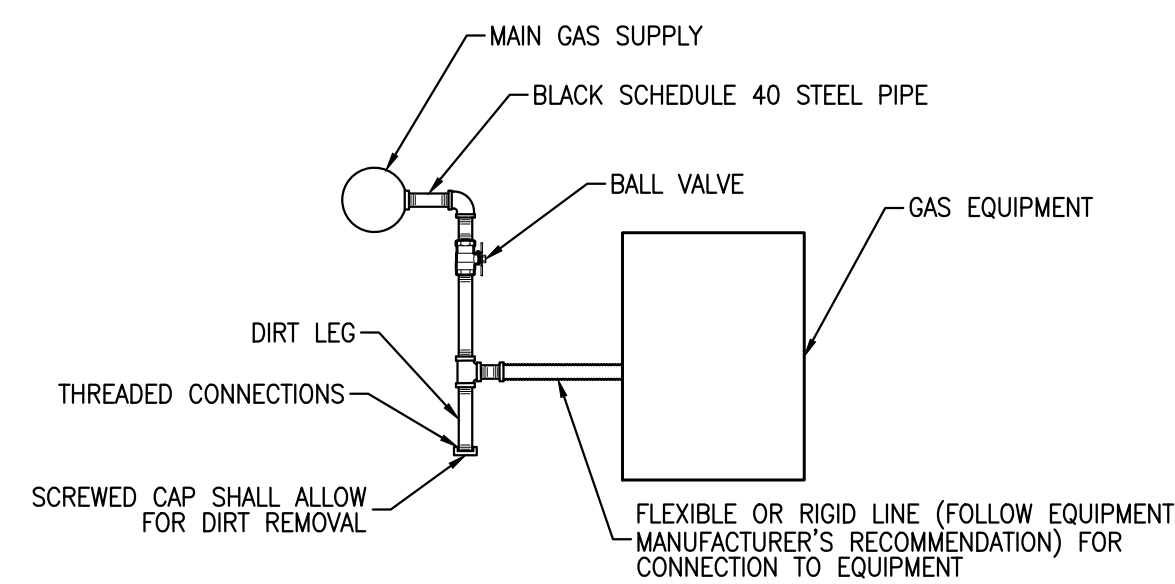





**1 CONDENSATE DETAIL**  
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**2 PUMP DETAIL**  
SCALE: NTS




**5 GAS CONNECTION DETAIL**  
SCALE: NTS




**NOTE:**

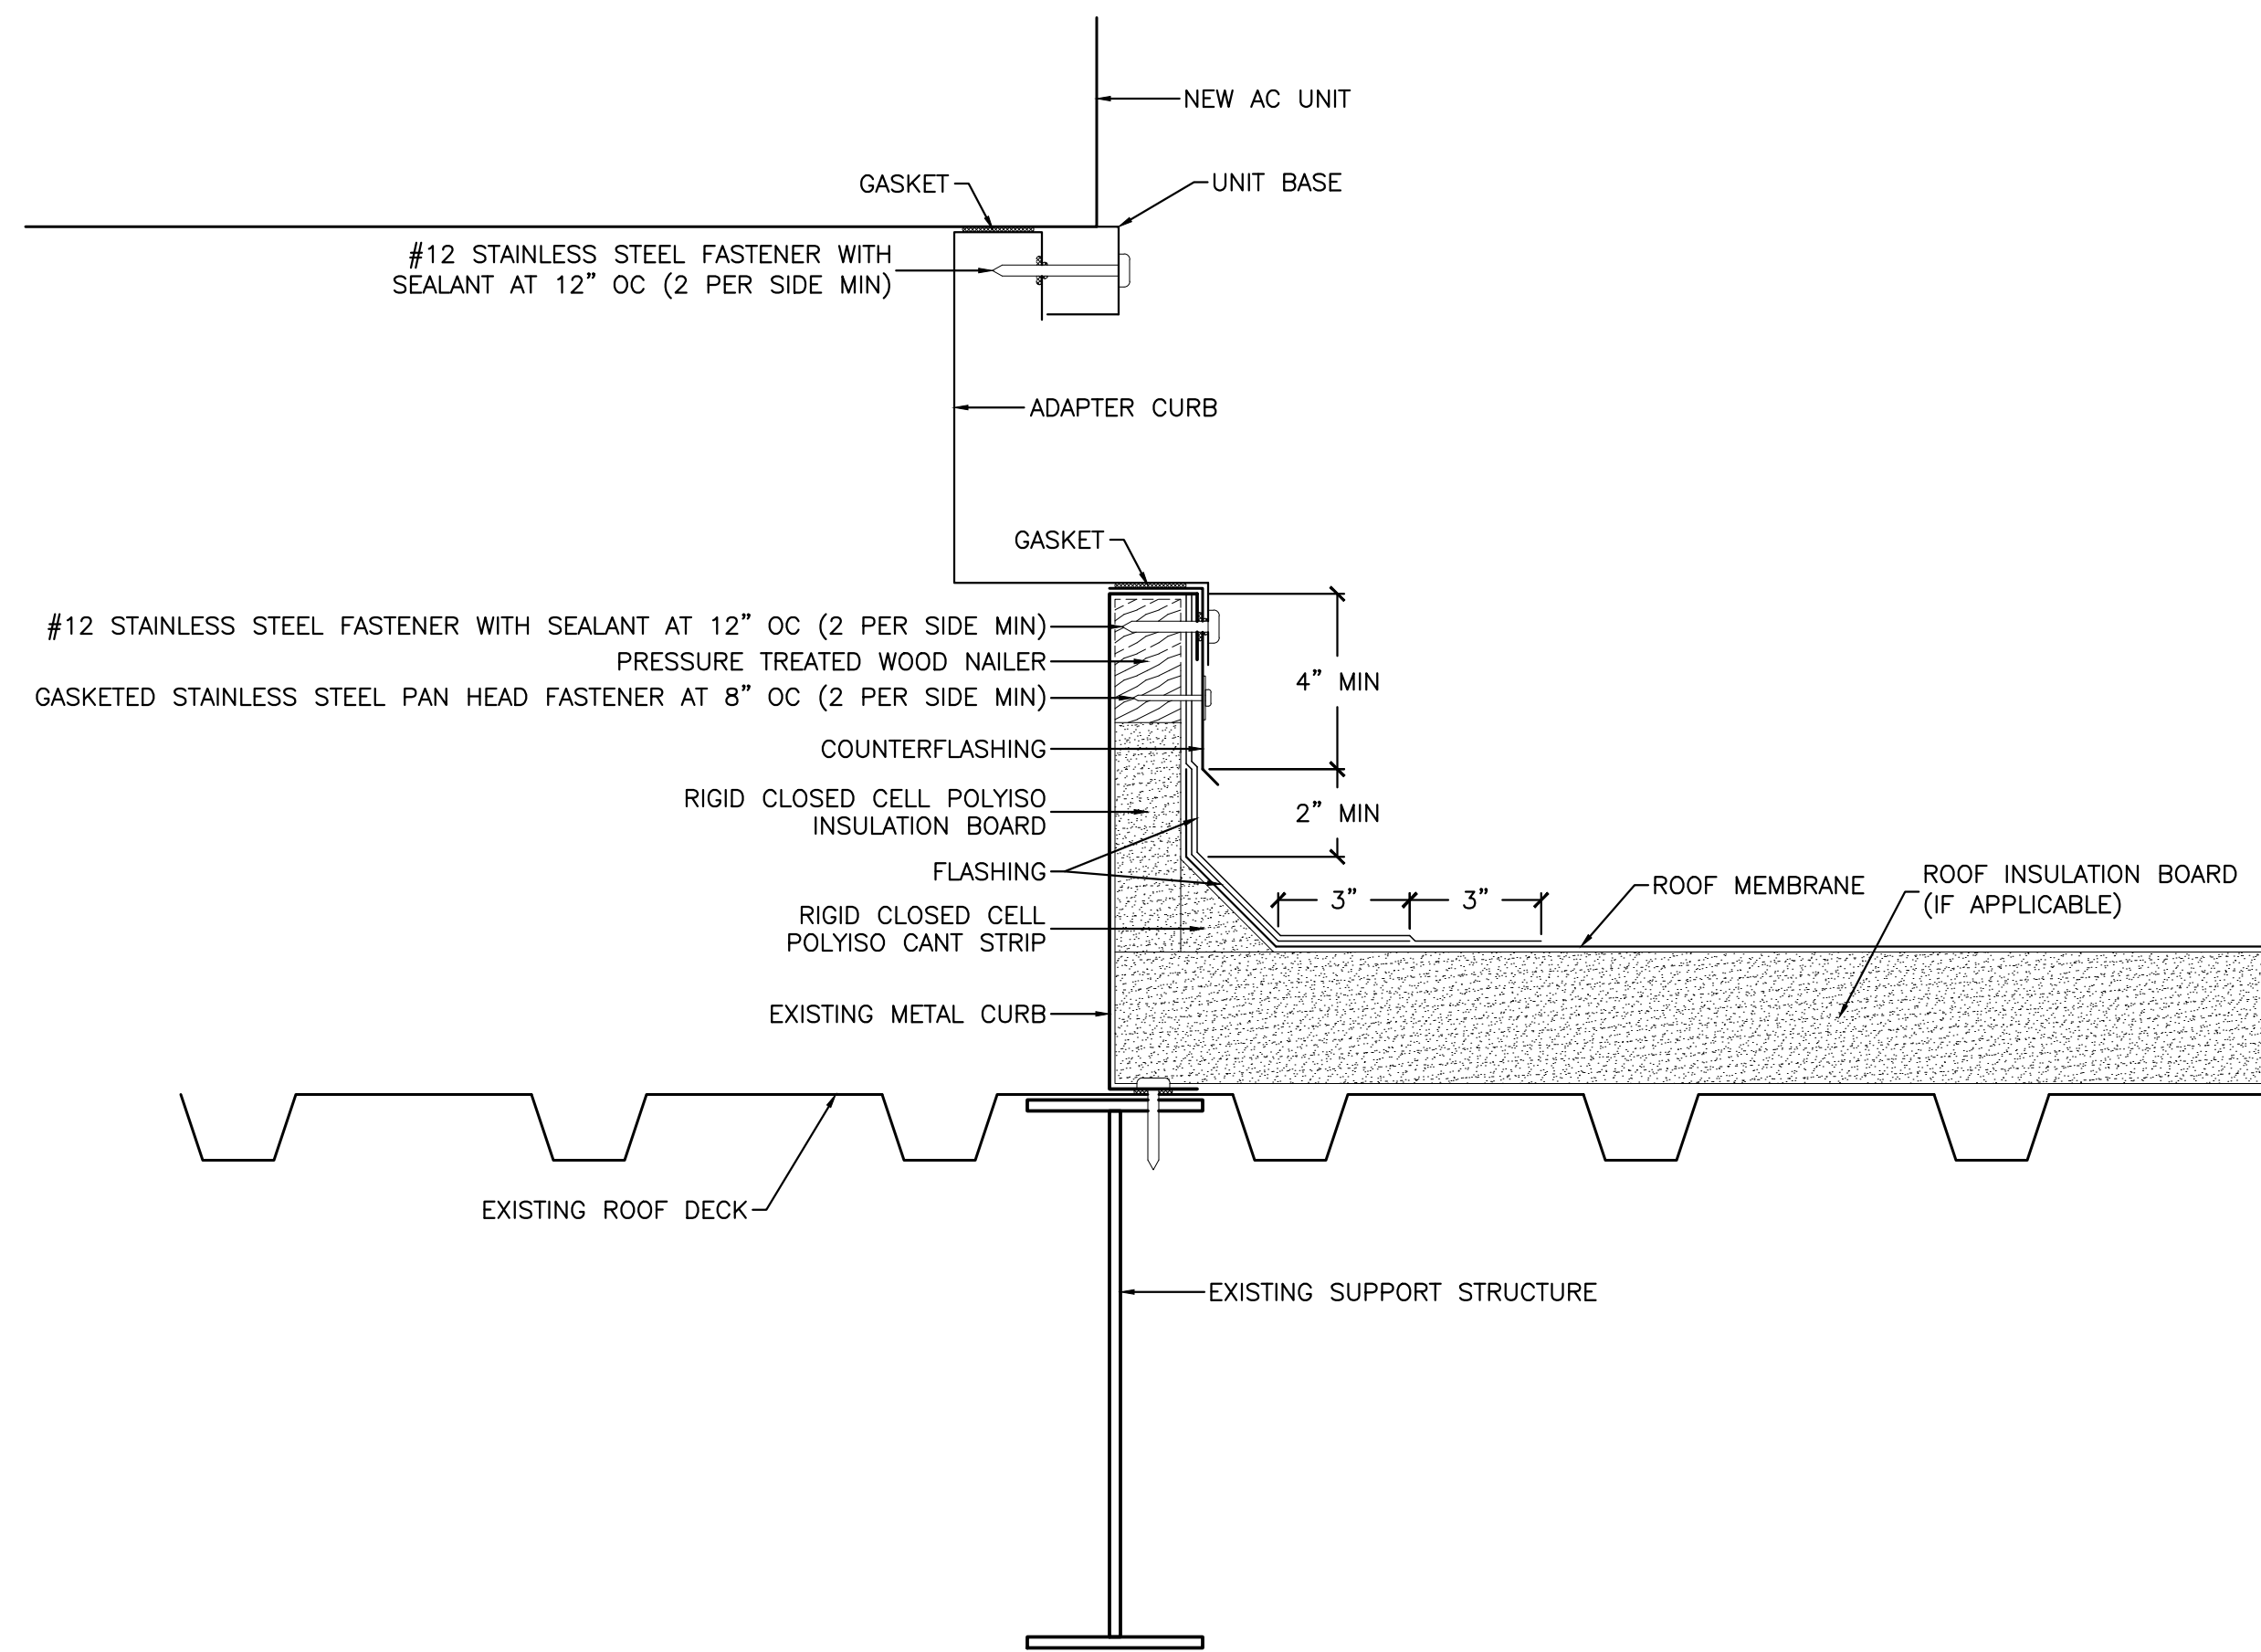1. THE CONSTRUCTION SHOWN REPRESENTS THE MINIMUM REQUIREMENTS FOR THIS PROJECT. IT IS NOT A SUBSTITUTE FOR THE ROOFING SYSTEM MANUFACTURER'S INSTALLATION STANDARDS OR THE ROOFING CONTRACTOR'S STANDARDS. ALL WORK SHALL BE FULLY COORDINATED WITH THE ROOFING CONTRACTOR AND SHALL BE PERFORMED IN A MANNER THAT WILL NOT AFFECT ANY NEW OR EXISTING ROOF WARRANTY.
2. THE AC UNIT SHALL NOT BE SET UNTIL THE ROOF MEMBRANE AND FLASHING HAVE BEEN INSTALLED.

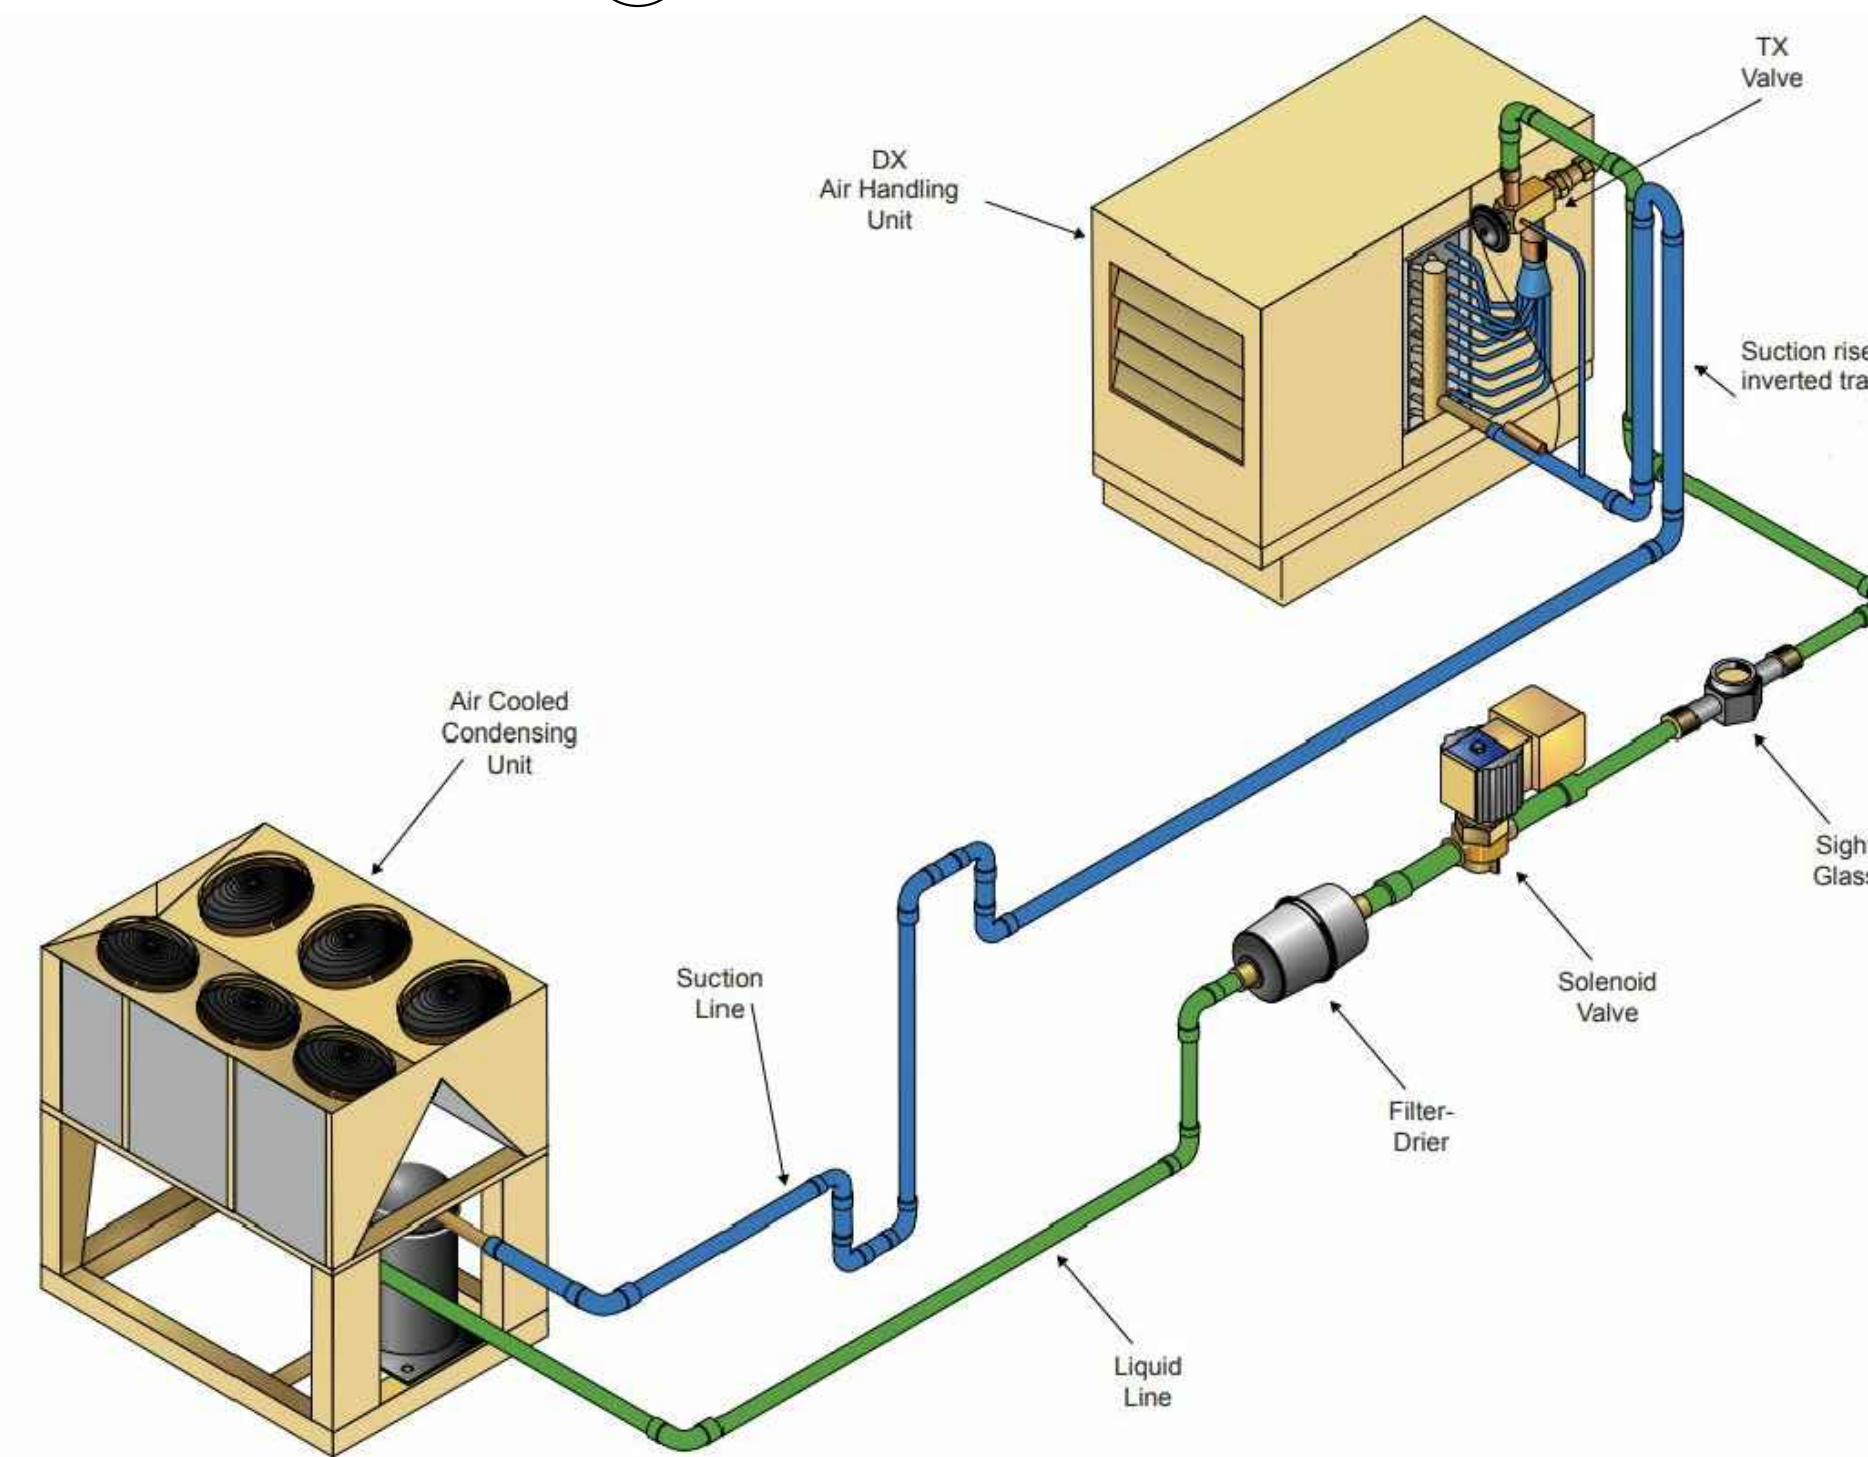**3 ROOF CURB DETAIL**  
SCALE: NTS




**4 REFRIGERANT PIPING DETAIL**  
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12602 HWY 57, 4725 BULLDOG LN,  
& 12424 HWY 57  
VANCLEAVE, MISSISSIPPI 39565
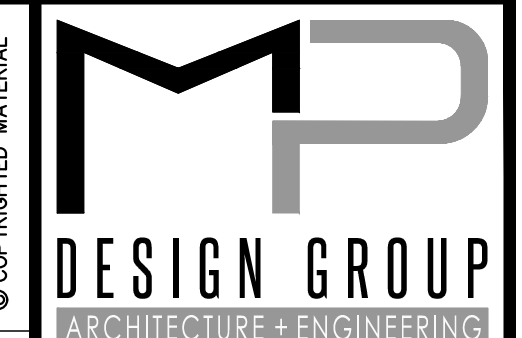
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**MECHANICAL HVAC DETAILS**

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PACKAGE ROOF TOP UNIT SCHEDULE

TAG	MAKE	MODEL	CFM	OA	ESP	RPM	COOLING CAPACITY					GAS HEAT INPUT (MBH)	V/PH	INDOOR FAN HP	INDOOR FAN FLA	OUTDOOR FAN FLA	COMPRESSOR AMPS	FLA	MCA	MOCP	LBS	NOTES
							NET TOTAL (MBH)	NET SENSIBLE (MBH)	EDB (°F)	EWB (°F)	OA (°F)											
HS-RTU-1	DAIKIN	MPS026G	8000	1200	0.60	1162	273.280	197.034	80.0	67.0	95.0	300	460/3	5	6.6	(3) 2.0	(3) 12.2	50.1	53.2	60	4010	2,4,5,6,7,8,9,10,11,12,13,14,15,16,17,18,19,20,21
HS-RTU-2	DAIKIN	MPS026G	8000	1200	0.60	1162	273.280	197.034	80.0	67.0	95.0	300	460/3	5	6.6	(3) 2.0	(3) 12.2	50.1	53.2	60	4010	2,4,5,6,7,8,9,10,11,12,13,14,15,16,17,18,19,20,21
HS-RTU-3	DAIKIN	MPS026G	8000	1200	0.60	1162	273.280	197.034	80.0	67.0	95.0	300	460/3	5	6.6	(3) 2.0	(3) 12.2	50.1	53.2	60	4010	2,4,5,6,7,8,9,10,11,12,13,14,15,16,17,18,19,20,21
HS-RTU-4	DAIKIN	MPS026G	8000	1200	0.60	1162	273.280	197.034	80.0	67.0	95.0	300	460/3	5	6.6	(3) 2.0	(3) 12.2	50.1	53.2	60	4010	1,4,5,6,7,8,9,10,11,12,13,14,15,16,17,18,19,20,21
HS-RTU-5	DAIKIN	DSP010A	4000	600	0.60	1504	128.365	98.082	80.0	67.0	95.0	N/A	460/3	8	6.8	(2) 1.8	4.5 & 7.9	21.0	23.0	30	2171	3,4,5,6,7,8,9,10,11,12,13,14,15,16,17,18,19,20,21
1 WITH TRANSITION CURB FOR COLEMAN MODEL ZS-20N30B4H2AAB1B1 2 WITH TRANSITION CURB FOR YORK MODEL DM240N24D4BUA1C 3 WITH TRANSITION CURB FOR TRANE MODEL TSC120A4E0A11 4 WITH RETURN AIR SMOKE DETECTOR 5 WITH CONVENIENCE OUTLET 6 WITH 2-POSITION, MOTORIZED OUTDOOR AIR DAMPER 7 WITH HINGED ACCESS PANELS 8 WITH HAIL GUARD 9 WITH BAS COMPATIBLE THERMOSTAT AND HUMIDITY SENSOR 10 WITH MERV 13 FILTERS 11 WITH HOT GAS REHEAT AND DEHUMIDIFICATION CONTROL 12 WITH NON-FUSED DISCONNECT 13 WITH 5 YEAR COMPRESSOR WARRANTY 12 WITH 10 YEAR HEAT EXCHANGER WARRANTY 14 WITH LOW-AMBIENT CONTROL 15 WITH FACTORY START UP 16 WITH THROUGH THE BASE ELECTRICAL & GAS 17 WITH BACnet COMMUNICATION CONTROLLER 18 WITH CONDENSATE OVERFLOW SWITCH 19 WITH FILTER SWITCH 20 WITH FACTORY CONDENSER COIL CORROSION PROTECTION COATING 21 WITH MATCHED GLOBAL PLASMA SOLUTIONS (GPS-IMOD) NEEDLEPOINT BI-POLAR IONIZATION UNIT MOUNTED IN CABINET, UPSTREAM OF COOLING COIL																						

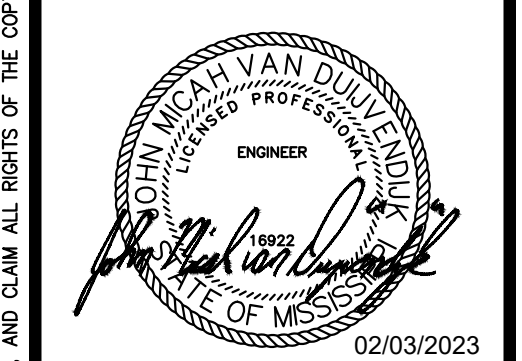AIR HANDLER SCHEDULE

TAG	MAKE	MODEL	CFM	OA	ESP	RPM	HEAT (KW)	V/PH	FAN HP	FAN FLA	FAN LRA	HEATER FLA	MCA	MOCP	LBS	NOTES
LE-AHU-1	DAIKIN	BCVD0401	4000	500	1.0	1252	39	460/3	5	6.2	N/A	46.9	66.3	70	340	1,2,3,4,6,8,9,10
LE-AHU-2	DAIKIN	BCVD0401	4000	500	1.0	1252	39	460/3	5	6.2	N/A	46.9	66.3	70	340	1,2,3,4,6,8,9,10
MS-AHU-1	DAIKIN	CAH018GDAM	8000	1200	1.5	1013	35 (SEPARATE FEED)	208/3	7.5	23.3	162.28	97.15 (SEPARATE FEED)	N/A	N/A	1955	1,2,3,5,6,7,8,9,10
MS-AHU-2	DAIKIN	CAH018GDAM	8000	1200	1.5	1013	35 (SEPARATE FEED)	208/3	7.5	23.3	162.28	97.15 (SEPARATE FEED)	N/A	N/A	1955	1,2,3,5,6,7,8,9,10
1 WITH CONDENSATE OVERFLOW SWITCH 2 VERTICAL CONFIGURATION 3 WITH THERMAL EXPANSION VALVE 4 WITH SINGLE POINT ELECTRICAL CONNECTION 5 WITH SECONDARY DRAIN PAN 6 MOUNT ON NIS VIBRATION ISOLATION 7 WITH WARREN TECHNOLOGY MODEL CBK, 22.5"x16" ELECTRIC DUCT HEATER 8 WITH MATCHED GLOBAL PLASMA SOLUTIONS (GPS-IMOD) NEEDLEPOINT BI-POLAR IONIZATION UNIT MOUNTED IN CABINET, UPSTREAM OF COOLING COIL 9 WITH MERV 13 FILTERS 10 MANUFACTURED IN THE USA																

CONDENSING UNIT SCHEDULE

TAG	MAKE	MODEL	TONNAGE	LIQUID	SUCTION	V/PH	FAN FLA	COMPRESSOR FLA	MCA	MOCP	LBS	NOTES
LE-CU-1	DAIKIN	RCS10H120C	10	5/8"	1-5/8"	208/3	(2) 3.9	34.8	49.0	80	565	1,2,3,4,5,6,7,8
LE-CU-2	DAIKIN	RCS10H120C	10	5/8"	1-5/8"	208/3	(2) 3.9	34.8	49.0	80	565	1,2,3,4,5,6,7,8
MS-CU-1	DAIKIN	RCS020D	20	(2) 5/8"	(2) 1-3/8"	208/3	(2) 4.2	(2) 37.6	93.6	125	1895	1,2,3,4,5,6,7,8
MS-CU-2	DAIKIN	RCS020D	20	(2) 5/8"	(2) 1-3/8"	208/3	(2) 4.2	(2) 37.6	93.6	125	1895	1,2,3,4,5,6,7,8
1 WITH FILTER/DRYER 2 SECURE TO CONCRETE PAD 3 WITH CONVENIENCE OUTLET 4 WITH LOW AMBIENT CONTROL 5 WITH 5 YEAR COMPRESSOR WARRANTY 6 WITH FACTORY CONDENSER COIL CORROSION PROTECTION COATING AND HAIL GUARD 7 MANUFACTURED IN THE USA 8 WITH FACTORY START UP												

PUMP SCHEDULE


TAG	MAKE	MODEL	MAX GPM	MIN GPM	HEAD (FT)	HP	RPM	EFF. @100%	INLET (IN)	OUTLET (IN)	IMPELLER (IN)	V/PH	LBS	NOTES
P-2	TACO	FI4013D	465	117	130	30	1760	75	5	4	11.35	460/3	1065	1,2,3,4,5
1 SECURE TO NEW CONCRETE PAD AND GROUT BASE 2 WITH ODP MOTOR 3 125 PSI PRESSURE CLASS 4 WITH VFD 5 MANUFACTURED IN THE UNITED STATES														

PLATE HEAT EXCHANGER SCHEDULE

TAG	MAKE	MODEL	HOT SIDE				COLD SIDE				LBS	NOTES
			GPM	EWT	LWT	PD (FT)	GPM	EWT	LWT	PD (FT)		
HE-1	TACO	PF31-191-4-NH	465	103.8	92	4.6	690	88	96	10.0	1875	1,2,3,4
1 WITH AISI 304 STAINLESS STEEL PLATES 2 WITH NBR HT GASKETS 3 MANUFACTURED IN THE UNITED STATES 4 WITH FLANGED CONNECTIONS												


COOLING TOWER SCHEDULE

TAG	MAKE	MODEL	GPM	EWT	LWT	WB	V/PH	HP	FAN FLA	BASIN (KW)	LENGTH	WIDTH	LBS	INLET PD (FT)	NOTES
CT-1	EVAPCO	AT19-3111	690	98	88	81	480/3	10	12.4	8	10'-5 1/2"	8'-5 1/2"	8350	6.0	1,2,3,4,5,6,7,8,9,10,11,12,13,14,15,16,17,18
1 ALL STAINLESS STEEL CONSTRUCTION 2 WITH VIBRATION LIMIT SWITCH 3 MANUFACTURED IN THE UNITED STATES 4 WITH STRUCTURAL DESIGN FOR IBC COMPLIANCE FOR HIGH WIND/HURRICANE PRONE REGIONS (159 MPH) 5 WITH VARIABLE FREQUENCY DRIVE AND CONTROL SYSTEM 6 WITH ELECTRIC BASIN HEATER 7 WITH STAINLESS STEEL BASIN 8 WITH 5 YEAR COMPLETE PRODUCT WARRANTY 9 WITH INVERTER-DUTY TEFC MOTORS FOR VFD 10 WITH NEMA 4X STAINLESS STEEL CONTROL PANEL 11 WITH EXTERNAL SERVICE PLATFORM WITH LADDER 12 WITH FAN MOTOR SPACE HEATERS 13 WITH CONTACTOR, TRANSFORMER, & DISCONNECT FOR HEATER 14 WITH EVAPAK FILL 15 WITH 4 FOOT LADDER EXTENSION 16 WITH WATER LEVEL CONTROL SYSTEM AND FLOAT VALVE 17 WITH FLANGED CONNECTIONS 18 WITH STAINLESS STEEL INTERNAL SERVICE PLATFORM															

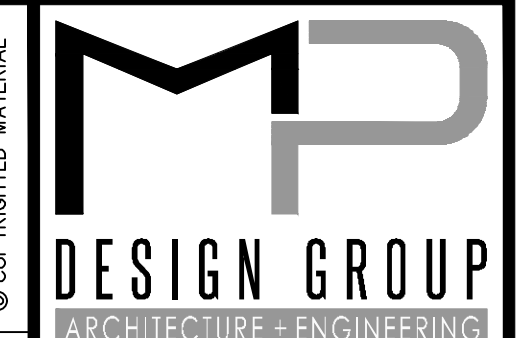

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**LOWER ELEMENTARY, MIDDLE, & HIGH SCHOOLS**  
 12602 HWY 57, 4725 BULLDOG LN,  
 & 12424 HWY 57  
 VANCLAVE, MISSISSIPPI 39565

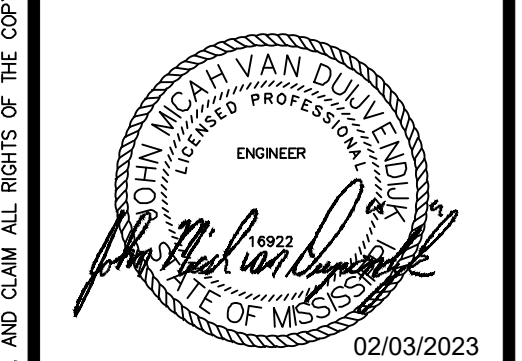SCALE: NONE  
 PROJECT NO: 0155.22.008  
 DRAWN BY: JMV  
 CHECKED BY: JMV

**MECHANICAL HVAC SCHEDULES**

NO.	DATE	REVISION / SUBMITTAL
REV 0	02.03.2023	ISSUED FOR CONSTRUCTION

**MH601**

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LIGHTING SYMBOLS		
CEILING	WALL	DESCRIPTION
		LED, FLUORESCENT OR H.I.D. LIGHT FIXTURE. LETTER DENOTES FIXTURE TYPE. SEE LUMINARE SCHEDULE.
		LED OR FLUORESCENT STRIP LIGHT FIXTURE. LETTER DENOTES FIXTURE TYPE. SEE LUMINARE SCHEDULE.
		LED OR FLUORESCENT LIGHT FIXTURE. LETTER DENOTES FIXTURE TYPE. SEE LUMINARE SCHEDULE.
		"EXIT" LIGHT FIXTURE. DIRECTIONAL ARROWS AS INDICATED. SHADED QUADRANT INDICATE FACE(S). SEE LUMINARE SCHEDULE.
		EMERGENCY BATTERY PACK FIXTURE. LETTER DENOTES FIXTURE TYPE. SEE LUMINARE SCHEDULE.
		H.I.D. FLOODLIGHT FIXTURE. LETTER DENOTES FIXTURE TYPE. SEE LUMINARE SCHEDULE.

POWER SYMBOLS					
FLOOR	WALL	CEIL.	COUNTR.	QUAD.	DESCRIPTION
					DUPLEX OUTLET; GFCI=GFCI PROTECTION, WP=WEATHER PROOF COVER, IG=ISOLATED GROUND.
					SPECIAL OUTLET
					480/277V PANELBOARD
					208/120V PANELBOARD
					DISCONNECT SWITCH, AS=FRAME SIZE, AT=FUSE SETTING (NF=NON FUSED), #P=NUMBER POLES, NR=NEMA ENCLOSURE RATING (NEMA 1 UNLESS OTHERWISE NOTED)
					COMBINATION STARTER/DISCONNECT SWITCH, MP=MAX PROTECTION RATING, SS=STARTER SIZE, #P=NUMBER POLES, NR=NEMA ENCLOSURE RATING.
					MAGNETIC MOTOR STARTER. SS=STARTER SIZE, NR=NEMA ENCLOSURE RATING (NEMA 1 UNLESS OTHERWISE NOTED)
					MOTOR, SINGLE-PHASE. HP=DENOTES HORSEPOWER
					MOTOR, THREE-PHASE. HP=DENOTES HORSEPOWER
					JUNCTION BOX
					JUNCTION BOX, WALL MOUNTED
					TRANSFORMER

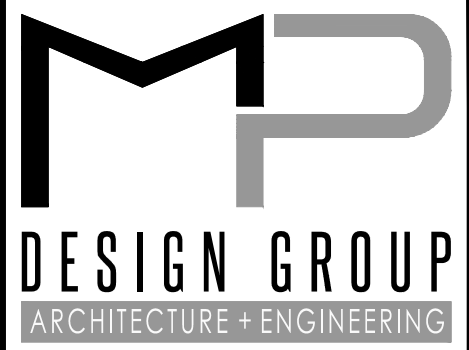
SYSTEM DEVICES			
FLOOR	WALL	CEIL.	DESCRIPTION
			TELEPHONE OUTLET, FLUSH MOUNTED
			COMBINATION DATA/TELEPHONE OUTLET, FLUSH MOUNTED
			CABLE TELEVISION OUTLET, FLUSH MOUNTED
			FIRE ALARM, COMBINATION AUDIO/VISUAL ANNUNCIATION UNIT. CANDELA AS INDICATED. WALL MOUNTED 7"-6" AFF UNLESS OTHERWISE NOTED, CEILING MOUNTED.
			STROBE, WALL MOUNTED 7"-6" AFF UNLESS OTHERWISE NOTED. CEILING MOUNTED CANDELA AS INDICATED.
			FIRE ALARM PULL STATION. WALL MOUNTED 48" AFF.
			HEAT DETECTOR CEILING MOUNTED.
			SMOKE DETECTOR CEILING MOUNTED.
			DUCT SMOKE DETECTOR, WITH SAMPLING TUBE MOUNTED IN HVAC DUCT.
			FLOW SWITCH
			CONTROL MODULE
			TAMPER SWITCH
			FIRE ALARM CONTROL PANEL (FACP)
			TRANSCIVER
			FIRE ALARM REMOTE ANNUNCIATOR PANEL.
			VARIABLE FREQUENCY DRIVE
			TELEPHONE BACK BOARD PANEL

WIRING SYMBOLS	
	DESCRIPTION
	WIRING (IN CONDUIT) CONCEALED IN CEILING OR WALL
	WIRING (IN CONDUIT) RUN EXPOSED
	WIRING UNDERGROUND (SITE WORK)
	TELECOMMUNICATION RACEWAY (SITE WORK)
	HOMERUN TO PANELBOARD WITH NOMENCLATURE (LETTERS), CIRCUIT NUMBERS (NUMBERS), NUMBER OF CIRCUITS (NUMBER OF ARROWS), EACH CIRCUIT TO HAVE GROUND.
	ELECTRICAL MANHOLE
	TELECOMMUNICATION MANHOLE
	GROUND CONNECTION
	SINGLE-POLE TOGGLE SWITCH.
	WEATHER PROOF BUTTON SWITCH.
	THREE-WAY BUTTON SWITCH.
	SLIDE DIMMER FLUORESCENT.
	SWITCH, MOTOR RATED
	SWITCH, MOTION SENSOR, LITHONIA WSX SERIES OR APPROVED EQUAL
	PHOTO CELL
	OCCUPANCY SENSOR, LITHONIA LIGHTING CEILING MOUNTED 360 DEGREE PASSIVE DUAL TECHNOLOGY MOTION SENSOR, OR APPROVED EQUAL
	CONDUIT STUBBED OUT
	GROUNDING CONNECTION BAR
	10' 3/4" COPPER CLAD GROUND ROD.

REFERENCE SYMBOLS	
	DESCRIPTION
	SPECIFIC NOTE REFERENCE.
	FEEDER REFERENCE.
	DETAIL/SECTION REFERENCE: "1" DENOTES DETAIL. "A" DENOTES SECTION "E1" DENOTES DRAWING NUMBER WHERE DETAIL/SECTION IS TAKEN "E2" DENOTES DRAWING NUMBER WHERE DETAIL/SECTION IS DRAWN


SPECIAL SYSTEMS	
	DESCRIPTION
	SPEAKER, CEILING MOUNT.
	INTERCOM CALL STATION.
	FLOOR MOUNTED MICROPHONE OUTLET ACE BACKSTAGE HALF STAGE POCKET OR EQUAL.
	WALL MOUNTED VOLUME CONTROL 70 VOLT.
	MAGNETIC DOOR CONTACT. SECURITY SYSTEM
	GLASS BREAK SENSOR. SECURITY SYSTEM
	MOTION DETECTOR. SECURITY SYSTEM.
	SECURITY SYSTEM PANEL.
	KEYPAD SECURITY SYSTEM.
	OVERHEAD PROJECTOR

ONE-LINE SYMBOLS	
	DESCRIPTION
	METER ENCLOSURE
	METER
	CIRCUIT BREAKER
	SWITCH, SINGLE POLE-SINGLE THROW
	FUSE
	FUSED SWITCH
	FUSED SWITCH
	DRY TYPE TRANSFORMER
	PANELBOARD
	CURRENT TRANSFORMER
	POTENTIAL TRANSFORMER
	LIGHTING CONTACTOR
	GROUND FAULT MONITORING
	KIRK-KEY MECHANICAL INTER-LOCK
	GROUND SYSTEM TEST WELL WITH GROUND ROD CONNECTION
	EXOTHERMIC WELD GROUND ROD CONNECTION
	EXOTHERMIC WELD CONNECTION
	4-WAY SF6 SWITCH
	6-WAY SF6 SWITCH
	TYPICAL DUAL CIRCUIT AIR BREAK TRANSFORMER DESIGN
	TRANSFORMER STATION NUMBER BUILDING NUMBER OR LOCATION
	LOAD BREAK SF6 SWITCH
	MOTOR STARTER (NUMBER INDICATES NEMA SIZE)
	UNDERVOLTAGE RELAY
	VOLT METER
	AMMETER
	TRANSIENT VOLTAGE SURGE SUPPRESSION



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 & 12424 HWY 57  
 VANCLAVE, MISSISSIPPI 39565

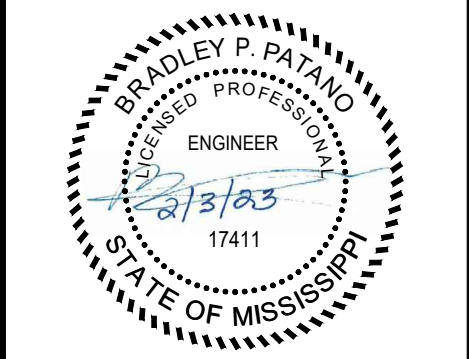SCALE: NTS  
 PROJECT NO: 0155.22.008  
 DRAWN BY: DLM  
 CHECKED BY: KDB

ELECTRICAL SYMBOL SCHEDULE		
NO.	DATE	REVISION / SUBMITTAL
REV 0	02.03.2023	ISSUED FOR CONSTRUCTION

NO.	DATE	REVISION / SUBMITTAL

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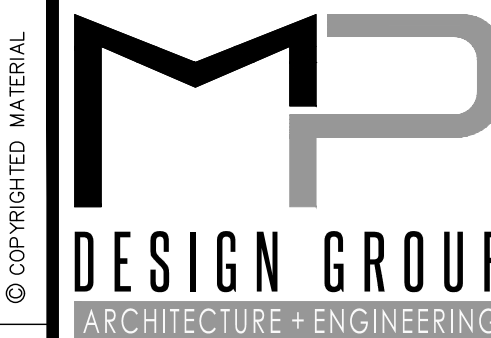
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### GENERAL NOTES

- EQUIPMENT SHALL BE MOUNTED ON MATERIALS SUITABLE FOR THE ENVIRONMENT WHICH IT IS INSTALLED WITH THE APPROPRIATE NEMA ENCLOSURE RATING.
- WORKING CLEARANCES FOR ELECTRICAL EQUIPMENT SHALL BE IN COMPLIANCE WITH ARTICLE 110 AND 408.
- THE DEDICATED ELECTRICAL SPACE EXTENDED FROM THE FLOOR TO THE STRUCTURAL CEILING WITH THE WIDTH AN DEPTH OF THE PANEL-BOARD OR SWITCHBOARD, MUST BE CLEAR OF ALL PIPING, DUCTS, EQUIPMENT FOREIGN TO THE ELECTRICAL OR ARCHITECTURAL APPURTENANCES IN ACCORDANCE WITH THE NEC 110 & 408. COORDINATE INSTALLATION OF ELECTRICAL EQUIPMENT WITH OTHER TRADES PRIOR TO ROUGHING IN EQUIPMENT.
- ALL ELECTRICAL EQUIPMENT AND THE RESULTANT INSTALLATION OF SUCH EQUIPMENT, DEVICES, ETC., SHALL BE IN STRICT COMPLIANCE WITH THE NATIONAL ELECTRIC CODE, NFPA 70, ALL APPLICABLE LOCAL, STATE AND FEDERAL CODES AND THE STANDARD FOR ELECTRICAL SAFETY IN THE WORKPLACE NFPA 70E.
- DRAWINGS AND SPECIFICATIONS FORM A COMPLETE SET OF DOCUMENTS FOR THE WORK IN THIS PROJECT. NEITHER IS COMPLETE WITHOUT THE OTHER. ANY ITEM MENTIONED IN ONE SHALL BE BINDING AS MENTIONED IN BOTH.
- CONTRACTOR SHALL TAKE RESPONSIBILITY FOR FIELD VERIFICATION OF ALL DIMENSIONS AND LOCATIONS OF EXISTING, RELOCATED AND NEW EQUIPMENT AND SHALL BE RESPONSIBLE FOR COORDINATION WITH THE WORK OF OTHER TRADES NECESSARY TO THE PROJECT.
- THESE DRAWINGS ARE INTENDED TO OUTLINE THE SCOPE OF WORK REQUIRED TO PROVIDE A COMPLETE AND OPERABLE PROJECT CONCLUSION. ALL MISCELLANEOUS COMPONENTS, PARTS, FASTENERS, SPLICES AND OTHER INCIDENTAL ITEMS NECESSARY TO PROVIDE A COMPLETED PROJECT SHALL BE PROVIDED WHETHER OR NOT SPECIFICALLY NOTED.
- CONTRACTOR SHALL NOTIFY THE ENGINEER IMMEDIATELY OF ANY CONFLICTS ARISING FROM DISCOVERED CONDITIONS AT ANY PHASE OF THE PROJECT.
- CONTRACTOR SHALL NOTIFY MISSISSIPPI ONE CALL TO DETERMINE THE LOCATION AND DEPTH OF UNDERGROUND UTILITIES PRIOR TO EXCAVATION.
- AT ANY LOCATION WHERE EXCAVATION OR ASSOCIATED WORK CAUSES DAMAGE TO EXISTING UNDERGROUND UTILITIES, CONTRACTOR SHALL RESTORE THE DAMAGED SYSTEM TO LIKE-NEW STATE.
- ALL BRANCH CIRCUITS SHALL HAVE A SEPARATE NEUTRAL AND GROUND.
- ALL ABOVE GROUND EXPOSED CONDUIT SHALL BE RIGID GALVANIZED STEEL.
- LOCATIONS OF OTHER EQUIPMENT SPECIFIED BY OTHER TRADES OR PROVIDED BY OWNER ARE APPROXIMATE. COORDINATE EXACT LOCATION IN FIELD PRIOR TO ROUGHING IN AND ROUTING CONDUIT.
- SEE ARCHITECTURAL REFLECTED CEILING PLANS AND ELEVATIONS FOR EXACT LOCATIONS FOR LIGHT FIXTURES IN LAY-IN OR DRYWALL CEILINGS, AND ON INTERIOR OR EXTERIOR WALLS.
- CONDUITS ARE NOT NECESSARILY SHOWN ON PLAN DRAWINGS FOR SAKE OF CLARITY. PROVIDE CONDUITS BETWEEN DEVICES AND TO PANELS PER REQUIREMENTS LISTED IN DIVISION 26 SPECIFICATIONS. INDICATE EXACT ROUTING OF CONDUIT ON PLAN DRAWINGS AS PART OF AS BUILD DOCUMENTATION TO BE SUBMITTED AFTER FINAL COMPLETION.
- FINAL CONNECTION TO ALL MOTORS SHALL BE WITH FLEXIBLE CONDUIT CONNECTION.
- ALL EXIT, NIGHT LIGHT, AND EMERGENCY FIXTURES SHALL BE CONNECTED TO LIGHT CIRCUIT AHEAD OF LOCAL SWITCH.
- GENERAL CONTRACTOR SHALL FIELD-VERIFY ALL EXISTING CONDITIONS PRIOR TO BEGINNING ANY WORK AND SHALL IMMEDIATELY NOTIFY THE ARCHITECT/ENGINEER OF ANY DISCREPANCIES. FAILURE TO DO SO INDICATES THAT THE CONTRACTOR ACCEPTS THE CONDITIONS AS THEY EXIST, AND SHALL PERFORM THE WORK REQUIRED AS SHOWN AND SPECIFIED.
- ELECTRICAL CONTRACTOR SHALL REVIEW MECHANICAL DRAWINGS AND SPECIFICATION TO OBTAIN LOCATIONS, WIRING REQUIREMENTS, CONTROL WIRING SCHEMES, INTERLOCK WIRING AND THERMOSTAT LOCATIONS.
- ALL DRAWINGS ARE DIAGRAMMATIC AND ARE INTENDED TO QUANTIFY THE MATERIALS SPECIFIED AND INDICATED THEIR INTENDED RELATIONSHIP TO EACH OTHER. THE DRAWINGS ARE NOT TO BE SCALED. THE VARIOUS SCALES USED ON THE DRAWINGS MAY NOT ALLOW FOR ALL FITTINGS, OFFSETS, AND ACCESSORIES THAT MAY BE REQUIRED TO COMPLETE THE WORK. THE CONTRACTOR SHALL CAREFULLY INVESTIGATE THE CONDITIONS THAT WOULD AFFECT THE WORK TO BE PERFORMED AND SHALL ARRANGE SUCH WORK AS NECESSARY TO COMPLY WITH THE INTENT OF THE CONSTRUCTION DOCUMENTS.
- ALL OPERABLE WALL MOUNTED DEVICES (SWITCHES, PULL STATIONS, ETC.) SHALL BE INSTALLED SO THAT THE OPERABLE COMPONENT IS A MAXIMUM OF 48" AFF AND IN ACCORDANCE WITH ADA AND ABA STANDARDS.


### DEMOLITION NOTES

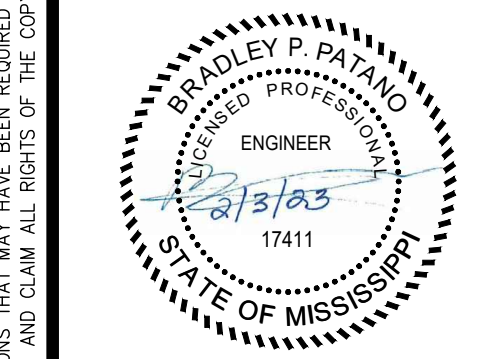- PLANS DO NOT ATTEMPT TO SHOW ALL DEMOLITION ITEMS. SOME LIGHT FIXTURES, SWITCHES/DIMMERS, EXIT LIGHTS, RECEPTACLES, TELEPHONE, DATA, MISC. OUTLETS, COMMUNICATION DEVICES (FIRE ALARM, PAGING/INTERCOM, NURSE CALL, SECURITY... ETC.) ARE SHOWN FOR INFORMATION PURPOSES AND GENERAL LAYOUT IN THESE AREAS TO BE RENOVATED. HOWEVER, THE ITEMS SHOWN ARE NOT NECESSARILY COMPLETE, ELECTRICAL CONTRACTOR (E.C.) TO FIELD VERIFY ALL DEMOLITION ITEMS AND PROVIDE REMOVAL OF ALL DEVICES ACCORDINGLY. SEE RELATED NOTES ON MAINTAINING SERVICE TO NON-DEMOLITION AREAS.
- E.C. SHALL REMOVE ALL EXISTING LIGHT FIXTURES, SWITCHES/DIMMERS, EXIT LIGHTS, RECEPTACLES, TELEPHONE, DATA, MISC. OUTLETS, WIRING TROUGHS, DUCTS, FILM ILLUMINATORS, COMMUNICATION DEVICES (FIRE ALARM, PAGING/INTERCOM, SECURITY,... ETC.) IN DEMOLITION AREAS. REMOVE CONDUIT/WIRE BACK TO PANEL(S) UNLESS RE-USED FOR NEW AND/OR RELOCATED WORKS. EXISTING RACEWAYS, CONDUITS AND CABLE DUCTS WITH ADEQUATE CAPACITY FOR NEW AND/OR EXISTING LOADS MAY BE RE-USED. SIMILARLY FOR COMMUNICATION SYSTEM CONDUIT/WIRE (REMOVE BACK TO CONTROL PANEL(S) IF NOT RE-USED). FIXTURES NOT INDICATED FOR RE-USE SHALL BE DELIVERED TO A LOCATION TO BE SPECIFIED BY OWNER. ALL FIXTURES UPSTREAM OR DOWNSTREAM OF DEMOLISHED FIXTURES AND ON THE SAME CIRCUITS SHALL BE RECONNECTED TO MAINTAIN SERVICE, PROVIDE NEW CONDUIT/WIRE AS REQUIRED.
- DAMAGE TO EXISTING MATERIALS/EQUIPMENT WILL BE REPAIRED AT NO ADDITIONAL COST TO OWNER. RE-SUPPORT ANY REMAINING CONDUIT OR DEVICE THAT WERE SUPPORTED BY WALLS/MILLWORK BEING REMOVED.
- NON-DEMOLITION AREAS: DEMOLITION WORKS SHALL NOT AFFECT AREAS NOT INCLUDED IN DEMOLITION. E.C. SHALL BE RESPONSIBLE FOR THE CONTINUITY OF ALL SERVICES (POWER, TELEPHONE, FIRE ALARM, DATA, PAGING, INTERCOM, ETC.) IN NON-DEMOLITION AREAS. ALL SERVICES SHALL BE MAINTAINED AT ALL TIMES. E.C. SHALL MAINTAIN SERVICE BY EXTENDING, RE-ROUTING AND/OR RECONNECTING ANY CIRCUITS AFFECTED BY DEMOLITION.
- E.C SHALL FIELD INVESTIGATE EXISTING ELECTRICAL INSTALLATION. ALL EXISTING INSTALLATION IN THE RENOVATION AREAS THAT ARE TO REMAIN BUT ARE NOT CURRENTLY IN COMPLIANCE WITH CURRENT CODES SHALL BE CORRECTED BY E.C., INCLUDING BUT NOT LIMITED TO THE FOLLOWING:
  - UN-SUPPORTED CONDUIT AND JUNCTION BOXES LAYING ON TOP OF CEILING TILES, CONDUIT AND/OR JUNCTION BOXES SUPPORTED ONLY BY TIE-WIRE - RAISE AND SUPPORT CONDUIT WITH STRAP PER SPECS. PROVIDE NEW CONDUIT/WIRE AS REQUIRED.
  - CIRCUITS WITHOUT A SEPARATE GREEN GROUNDING WIRE - INSTALL A GREEN GROUNDING WIRE FOR EVERY RECEPTACLE OUTLET AND DEVICES. INSTALLATION OF THE GREEN GROUNDING WIRE MAY REQUIRE THE REMOVAL AND RE-INSTALLATION OF THE EXISTING WIRES. PROVIDE NEW WIRE AS REQUIRED.
  - FIXTURES IMPROPERLY SUPPORTED OR INADEQUATELY SUPPORTED BY DEVICE BOXES - PROVIDE PROPER SUPPORT PER N.E.C.
  - EMERGENCY AND NORMAL POWER CIRCUITS IN THE SAME CONDUIT - PROVIDE SEPARATION OF EMERGENCY AND NORMAL CIRCUITS AND INSTALL IN SEPARATE CONDUIT.
- ALL EXISTING ABANDONED AND/OR UN-USED CONDUIT/WIRE, SWITCHES/STARTERS, JUNCTION BOXES, COMMUNICATION SYSTEM AND DEVICES IN PROJECT AREAS SHALL BE REMOVED BACK TO PANELS AND/OR CONTROL PANELS. ALL ITEMS DEMOLISHED BY E.C. SHALL BE REMOVED BACK TO PANELS AND/OR CONTROL PANELS.
- SEE ARCHITECTURAL DRAWINGS FOR ADDITIONAL SCOPE OF DEMOLITION WORK.
- ALL WORK SHALL BE DONE IN TOTAL COORDINATION WITH THE BUILDING ELECTRICAL MAINTENANCE STAFF TO AVOID ANY INTERRUPTION TO EXISTING CIRCUITS IN USE.
- ALL OPENINGS IN PARTITIONS AND CEILING SHALL BE FIRE SEALED.
- CONTRACTOR TO PROVIDE OSHA APPROVED TEMPORARY LIGHTING AND POWER AS REQUIRED FOR THE DURATION OF THE PROJECT.



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**VANCLEAVE SCHOOLS HVAC UPGRADES**  
**LOWER ELEMENTARY, MIDDLE,**  
**& HIGH SCHOOLS**  
 12602 HWY 57, 4725 BULLDOG LN,  
 & 12424 HWY 57  
 VANCLEAVE, MISSISSIPPI 39565

SCALE: NTS  
 PROJECT NO: 0155.22.008  
 DRAWN BY: DLM  
 CHECKED BY: KDB

### ELECTRICAL NOTES

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**E002**  
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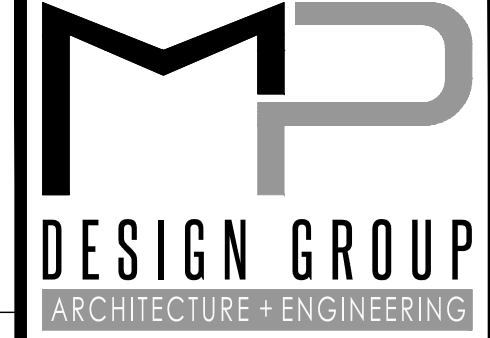
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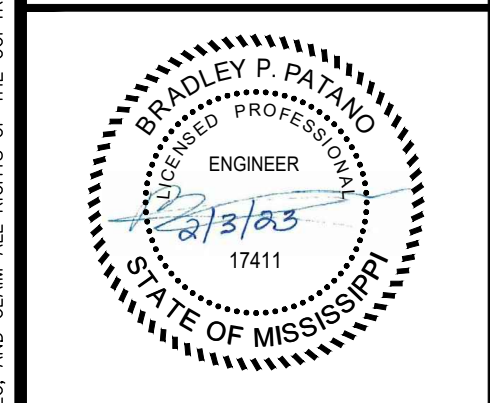
ABBREVIATIONS									
<b>A</b>	AMPERE(S)	E.C.	ELECTRICAL CONTRACTOR	KCMIL	THOUSAND CIRCULAR MILS	ø	PHASE	UG	UNDERGROUND
AC	ALTERNATING CURRENT	EEB	ELECTRICAL EQUIPMENT BUILDING	KV	KILOVOLT	PNL	PANEL	UL	UNDERWRITER'S LABORATORIES
A/C	AIR CONDITIONING	EF	EXHAUST FAN	KVA	KILOVOLT AMPERES	PR	PAIR		
AF	AMPERE FRAME	EL	ELEVATION	KW	KILOWATT	PE	PHOTO ELECTRIC		
AFF	ABOVE FINISHED FLOOR	EM	EMERGENCY			PIR	PRIMARY		<b>V</b>
AFG	ABOVE FINISHED GRADE	ESD	EMERGENCY SHUTDOWN			PI	PASSIVE INFRARED	V	VOLTS
AIC	AMPERES INTERRUPTING CAPACITY	EWC	ELECTRIC WATER COOLER	LBS.	POUNDS	PT	POTENTIAL TRANSFORMER	VAC	VOLTAGE, ALTERNATING CURRENT
ALUM	ALUMINUM	EXIST	EXISTING	LEV	LEVEL	PVC	POLYVINYL CHLORIDE	VDC	VOLTAGE, DIRECT CURRENT
AT	AMPERE TRIP			LTG.	LIGHTING	PWR	POWER		
AWG	AMERICAN WIRE GAGE			LV	LOW VOLTAGE				<b>W</b>
AHU	AIR HANDLING UNIT	FC	FOOT CANDLE					W	WATTS, WIRE, WIDTH
		FF	FINISHED FLOOR			REC	RECEPTACLE	WP	WEATHERPROOF
		FLA	FULL LOAD AMPS	MCB	MAIN CIRCUIT BREAKER	REQ'D.	REQUIRED		
		FL	FLUORESCENT	MISC	MISCELLANEOUS	RGS	RIGID GALVANIZED STEEL		
<b>C</b>	CONDUIT	FREQ.	FREQUENCY	MLO	MAIN LUGS ONLY	RM	ROOM		<b>X</b>
CB	CIRCUIT BREAKER	FT.	FOOT; FEET	MTD	MOUNTED	RT	RAINTIGHT	XFMR	TRANSFORMER
CKT	CIRCUIT			MH	MOUNTING HEIGHT				
CL	CLASS	<b>G</b>	GROUND						
COND	CONDUCTOR(S)	GALV	GALVANIZED	<b>N</b>	NEUTRAL	SEC	SECONDARY		
CT	CURRENT TRANSFORMER	GFI	GROUND FAULT INTERRUPTER	NEC	NATIONAL ELECTRICAL CODE	SMK	SMOKE		
CU	COPPER	GND	GROUND	N.C.	NORMALLY CLOSED	SPC	SINGLE POINT CONNECTION		
COMM	COMMUNICATION			N.O.	NORMALLY OPEN	SR	SUNRISE		
CWP	CHILLED WATER PUMP			NF	NONFUSED	SS	SUNSET		
		HP	HORSEPOWER	NFPA	NATIONAL FIRE PROTECTION ASSOCIATION	STD	STANDARD		
		HPS	HIGH PRESSURE SODIUM	NL	UN SWITCHED NIGHT LIGHT	SUPVR	SUPERVISORY		
DC	DIRECT CURRENT	HV	HIGH VOLTAGE	NTS	NOT TO SCALE	SWBD	SWITCHBOARD		
DET.	DETECTOR	HZ	HERTZ						<b>T</b>
				<b>O</b>					
		<b>J</b>	JUNCTION BOX	OC	ON CENTER				
		JB		OL	OVERLOAD CONTACT	TYP	TYPICAL		

FEEDER SCHEDULE									
TYPE THHN/THWN INSUL. COPPER CONDUCTOR AMPACITY BASED ON (75° TEMP. RATING) IN RIGID METAL CONDUIT DRY INTERIOR LOCATIONS: EMT WITH CAST COMPRESSION FITTINGS WET EXTERIOR LOCATIONS: RGS WITH CAST FITTINGS UNDERGROUND INSTALLATIONS: SCHEDULE 80 PVC BASED ON 31% FILL CAPACITIES									
FEEDER DESIGNATION	3PH+G PHASE + GND. CONDUCTORS AND CONDUIT SIZE	FEEDER DESIGNATION	3PH+N+G PHASE + NEUTRAL + GND. CONDUCTORS AND CONDUIT SIZE	FEEDER DESIGNATION	2 WIRE + GND. OR 1 WIRE + NEUTRAL + GND. CONDUCTORS AND CONDUIT SIZE				
(20)	3#12+#12 GND., 3/4" C	(20N)	4#12+#12 GND., 3/4" C	(20S)	2#12+#12 GND., 3/4" C				
(30)	3#10+#10 GND., 3/4" C	(30N)	4#10+#10 GND., 3/4" C	(30S)	2#10+#10 GND., 3/4" C				
(50)	3#8+#10 GND., 1" C	(50N)	4#8+#10 GND., 1" C	(50S)	2#8+#10 GND., 1" C				
(65)	3#6+#8 GND., 1" C	(65N)	4#6+#8 GND., 1 1/4" C	(65S)	2#6+#8 GND., 1" C				
(85)	3#4+#8 GND., 1 1/4" C	(85N)	4#4+#8 GND., 1 1/4" C	(85S)	2#4+#8 GND., 1 1/4" C				
(100)	3#3+#8 GND., 1 1/4" C	(100N)	4#3+#8 GND., 1 1/2" C	(100S)	2#3+#8 GND., 1 1/4" C				
(115)	3#2+#6 GND., 1 1/2" C	(115N)	4#2+#6 GND., 1 1/2" C	(115S)	2#2+#6 GND., 1 1/2" C				
(130)	3#1+#6 GND., 1 1/2" C	(130N)	4#1+#6 GND., 2" C	(130S)	2#1+#6 GND., 1 1/2" C				
(150)	3#1/0+#6 GND., 2" C	(150N)	4#1/0+#6 GND., 2" C	(150S)	2#1/0+#6 GND., 2" C				
(175)	3#2/0+#6 GND., 2" C	(175N)	4#2/0+#6 GND., 2 1/2" C	(175S)	2#2/0+#6 GND., 2" C				
(200)	3#3/0+#6 GND., 2" C	(200N)	4#3/0+#6 GND., 2 1/2" C	(200S)	2#3/0+#6 GND., 2" C				
(230)	3#4/0+#4 GND., 2 1/2" C	(230N)	4#4/0+#4 GND., 3" C	(230S)	2#4/0+#4 GND., 2 1/2" C				
(255)	3#250+#4 GND., 2 1/2" C	(255N)	4#250+#4 GND., 3" C	(255S)	2#250+#4 GND., 2 1/2" C				
(285)	3#300+#4 GND., 3" C	(285N)	4#300+#4 GND., 3" C	(285S)	2#300+#4 GND., 3" C				
(310)	3#350+#3 GND., 3" C	(310N)	4#350+#3 GND., 4" C	(310S)	2#350+#3 GND., 3" C				
(335)	3#400+#3 GND., 3" C	(335N)	4#400+#3 GND., 4" C	(335S)	2#400+#3 GND., 4" C				
(380)	3#500+#3 GND., 4" C	(380N)	4#500+#3 GND., 4" C	(380S)	2#500+#3 GND., 4" C				
(400)	2 SETS(3#3/0+#3 GND., 2" C)	(400N)	2 SETS(4#3/0+#3 GND., 2 1/2" C)						
(420)	3#600+#2 GND., 4" C	(420N)	4#600+#2 GND., 4" C						
(460)	2 SETS(3#4/0+#2 GND., 2" C)	(460N)	2 SETS(4#4/0+#2 GND., 2 1/2" C)						
(510)	2 SETS(3#250+#1 GND., 2 1/2" C)	(510N)	2 SETS(4#250+#1 GND., 3" C)						
(570)	2 SETS(3#300+#4 GND., 2 1/2" C)	(570N)	2 SETS(4#300+#4 GND., 3" C)						
(620)	2 SETS(3#350+#1/0 GND., 3" C)	(620N)	2 SETS(4#350+#1/0 GND., 3" C)						
(760)	2 SETS(3#500+#1/0 GND., 3" C)	(760N)	2 SETS(4#500+#1/0 GND., 4" C)						
(840)	2 SETS(3#600+#2/0 GND., 4" C)	(840N)	2 SETS(4#600+#2/0 GND., 4" C)						
(855)	3 SETS(3#300+#2/0 GND., 2 1/2" C)	(855N)	3 SETS(4#300+#2/0 GND., 3" C)						
(1005)	3 SETS(3#400+#3/0 GND., 3" C)	(1005N)	3 SETS(4#400+#3/0 GND., 3" C)						
(1240)	4 SETS(3#350+#4/0 GND., 3" C)	(1240N)	4 SETS(4#350+#4/0 GND., 4" C)						
(1650)	5 SETS(3#400+#250 GND., 3" C)	(1650N)	5 SETS(4#400+#250 GND., 4" C)						
(2010)	6 SETS(3#400+#350 GND., 3" C)	(2010N)	6 SETS(4#400+#350 GND., 4" C)						
(2660)	7 SETS(3#500+#450 GND., 4" C)	(2660N)	7 SETS(4#500+#400 GND., 4" C)						
(3040)	8 SETS(3#500+#500 GND., 4" C)	(3040N)	8 SETS(4#500+#500 GND., 4" C)						
(4180)	11 SETS(3#500+#700 GND., 4" C)	(4180N)	11 SETS(4#500+#700 GND., 4" C)						



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**VANCLEAVE SCHOOLS HVAC UPGRADES**  
**LOWER ELEMENTARY, MIDDLE, & HIGH SCHOOLS**  
 12602 HWY 57, 4725 BULLDOG LN,  
 & 12424 HWY 57  
 VANCLEAVE, MISSISSIPPI 39565

SCALE: NTS  
 PROJECT NO: 0155.22.008  
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**ELECTRICAL ABBREVIATIONS & FEEDER SCHEDULE**


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**1** ELECTRICAL DEMO PLAN-LOWER ELEMENTARY SCHOOL  
 SCALE: 1/32" = 1'




**DRAWING E004 NOTES**

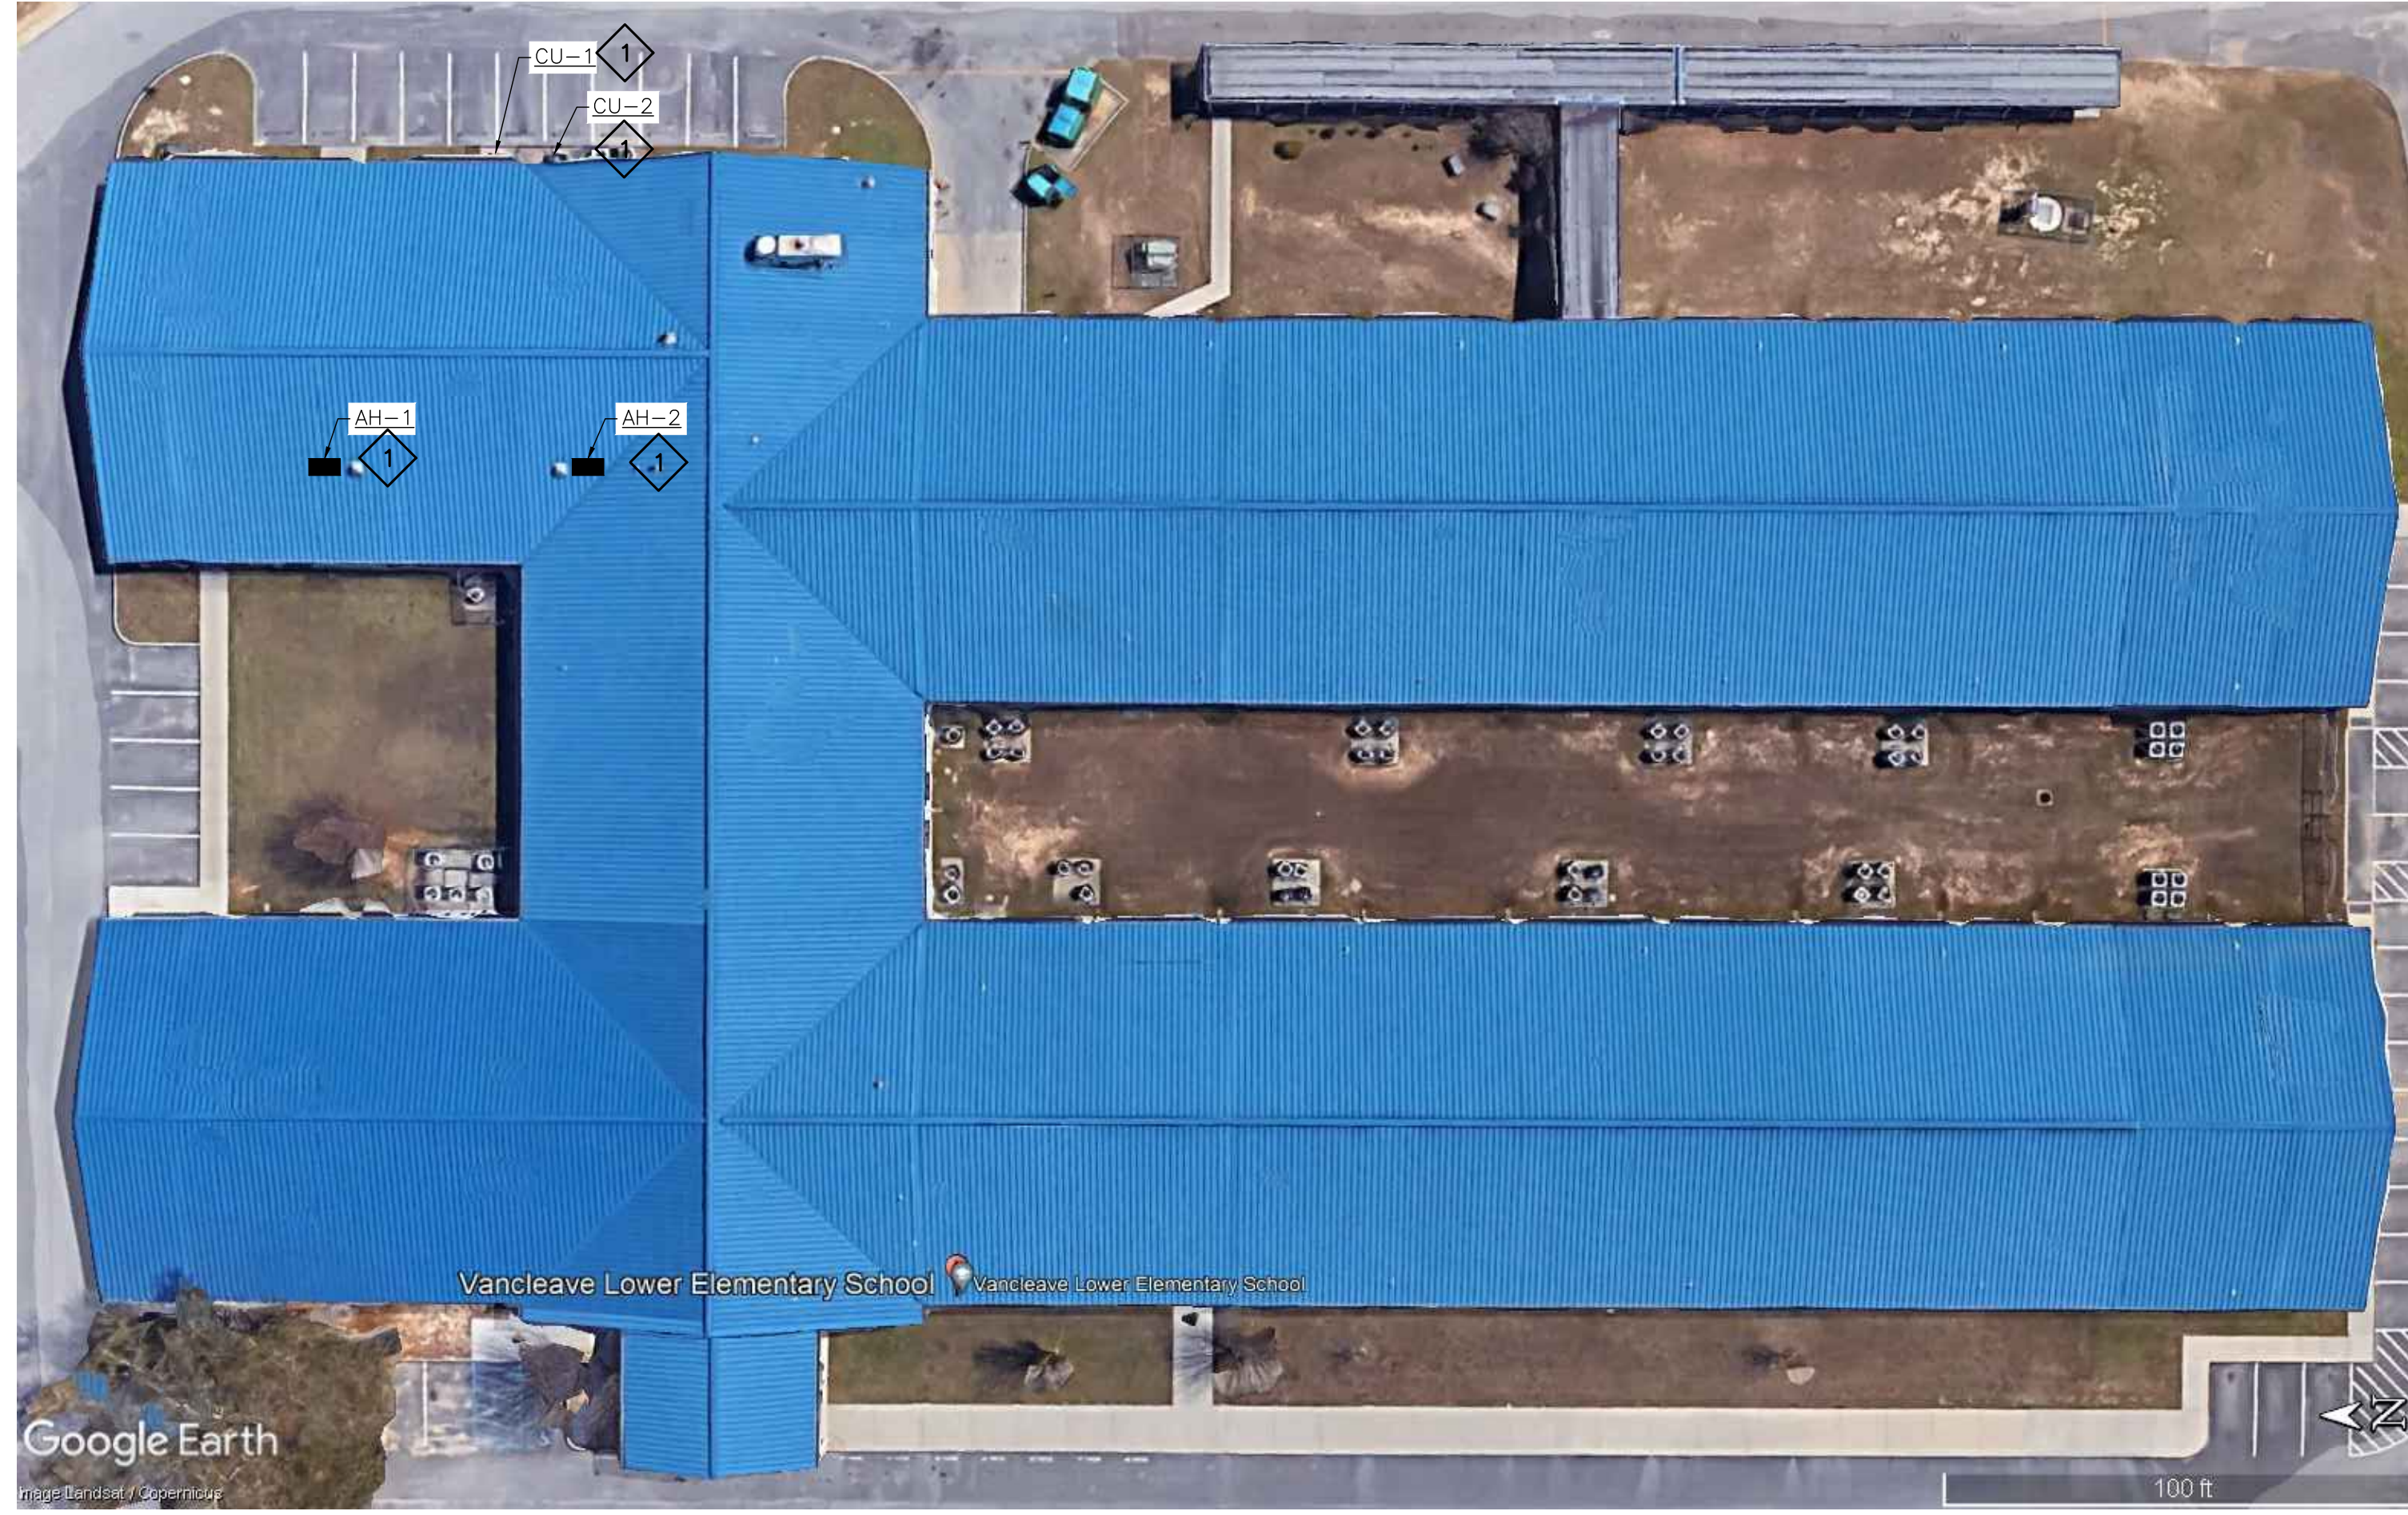1. CONTRACTOR SHALL COORDINATE WITH OWNER PRIOR TO DISPOSING ALL DEMOLISHED EQUIPMENT.

**DRAWING E004 SPECIFIC NOTES**

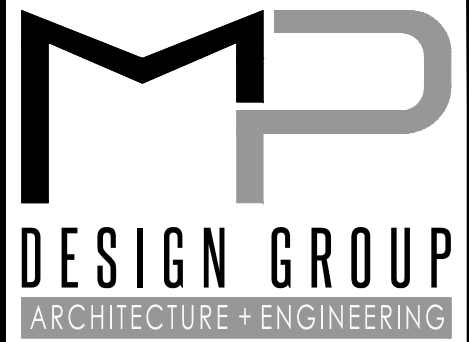**1** CONTRACTOR SHALL DEMOLISH EXISTING SAFETY SWITCH. CONTRACTOR SHALL DEMOLISH FEEDER BETWEEN SAFETY SWITCH AND HVAC UNIT. CONTRACTOR SHALL DEMOLISH CONDUIT AND FEED BACK TO SOURCE. CONTRACTOR SHALL DEMOLISH ALL CONDUIT ABOVE GRADE. CONTRACTOR SHALL ABANDON CONDUIT 6" BELOW GRADE.



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**VANCLEAVE SCHOOLS HVAC UPGRADES**  
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 VANCLEAVE, MISSISSIPPI 39565

SCALE: AS SHOWN  
 PROJECT NO: 0155.22.008  
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**ELECTRICAL DEMO PLAN-  
 LOWER ELEMENTARY SCHOOL**

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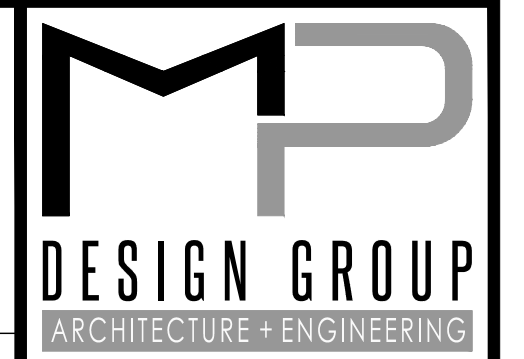
1 ELECTRICAL DEMO PLAN-MIDDLE SCHOOL  
 SCALE: 1/32" = 1'

**DRAWING E005 NOTES**

- CONTRACTOR SHALL COORDINATE WITH OWNER PRIOR TO DISPOSING ALL DEMOLISHED EQUIPMENT.

**DRAWING E005 SPECIFIC NOTES**

- CONTRACTOR SHALL DEMOLISH EXISTING SAFETY SWITCH. CONTRACTOR SHALL DEMOLISH FEEDER BETWEEN SAFETY SWITCH AND HVAC UNIT. CONTRACTOR SHALL DEMOLISH CONDUIT AND FEED FROM SWITCH TO SOURCE. CONTRACTOR SHALL DEMOLISH ALL CONDUIT ABOVE GRADE. CONTRACTOR SHALL ABANDON CONDUIT 6" BELOW GRADE.



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 & 12424 HWY 57  
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SCALE: AS SHOWN  
 PROJECT NO: 0155.22.008  
 DRAWN BY: DLM  
 CHECKED BY: KDB

**ELECTRICAL DEMO PLAN-  
 MIDDLE SCHOOL**

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**E005**

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**1 ELECTRICAL DEMO PLAN-HIGH SCHOOL**  
 SCALE: 1/32" = 1'



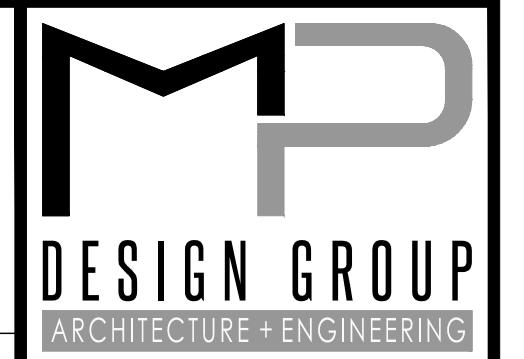
**DRAWING E006 NOTES**

1. CONTRACTOR SHALL COORDINATE WITH OWNER PRIOR TO DISPOSING ALL DEMOLISHED EQUIPMENT.

**DRAWING E006 SPECIFIC NOTES**


**1** CONTRACTOR SHALL DEMOLISH EXISTING SAFETY SWITCH. CONTRACTOR SHALL DEMOLISH FEEDER BETWEEN SAFETY SWITCH AND HVAC UNIT. CONTRACTOR SHALL DEMOLISH FEED FROM SOURCE TO SWITCH. CONTRACTOR SHALL DEMOLISH ALL CONDUIT ABOVE GRADE. CONTRACTOR SHALL ABANDON CONDUIT 6" BELOW GRADE.

**2** ALTERNATE 1: CONTRACTOR SHALL DEMOLISH EXISTING PANELBOARD MDP. CONTRACTOR SHALL PRESERVE FEEDER CABLE AND CONDUIT FOR CONNECTION TO NEW PANEL SEE E601 FOR EXISTING PANEL DETAILS. CONTRACTOR SHALL DEMOLISH SERVICE ENTRANCE CONDUCTOR. DEMOLISH SERVICE ENTRANCE CONDUIT AS REQUIRED.



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 Fernanda A. Silva, AIA

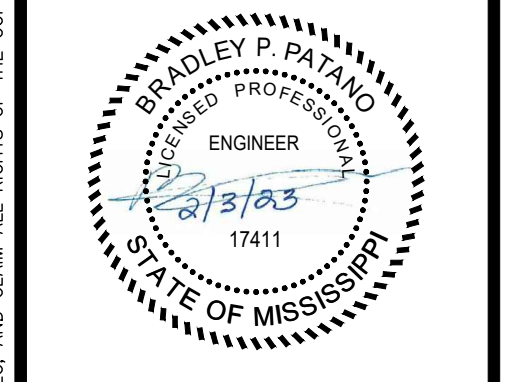

**VANCLEAVE SCHOOLS HVAC UPGRADES**  
**LOWER ELEMENTARY, MIDDLE, & HIGH SCHOOLS**  
 12602 HWY 57, 4725 BULLDOG LN,  
 & 12424 HWY 57  
 VANCLEAVE, MISSISSIPPI 39565

SCALE: AS SHOWN  
 PROJECT NO: 0155.22.008  
 DRAWN BY: DLM  
 CHECKED BY: KDB

**ELECTRICAL DEMO PLAN-  
 HIGH SCHOOL**

NO.	DATE	REVISION / SUBMITTAL
REV 0	02.03.2023	ISSUED FOR CONSTRUCTION

**E006**

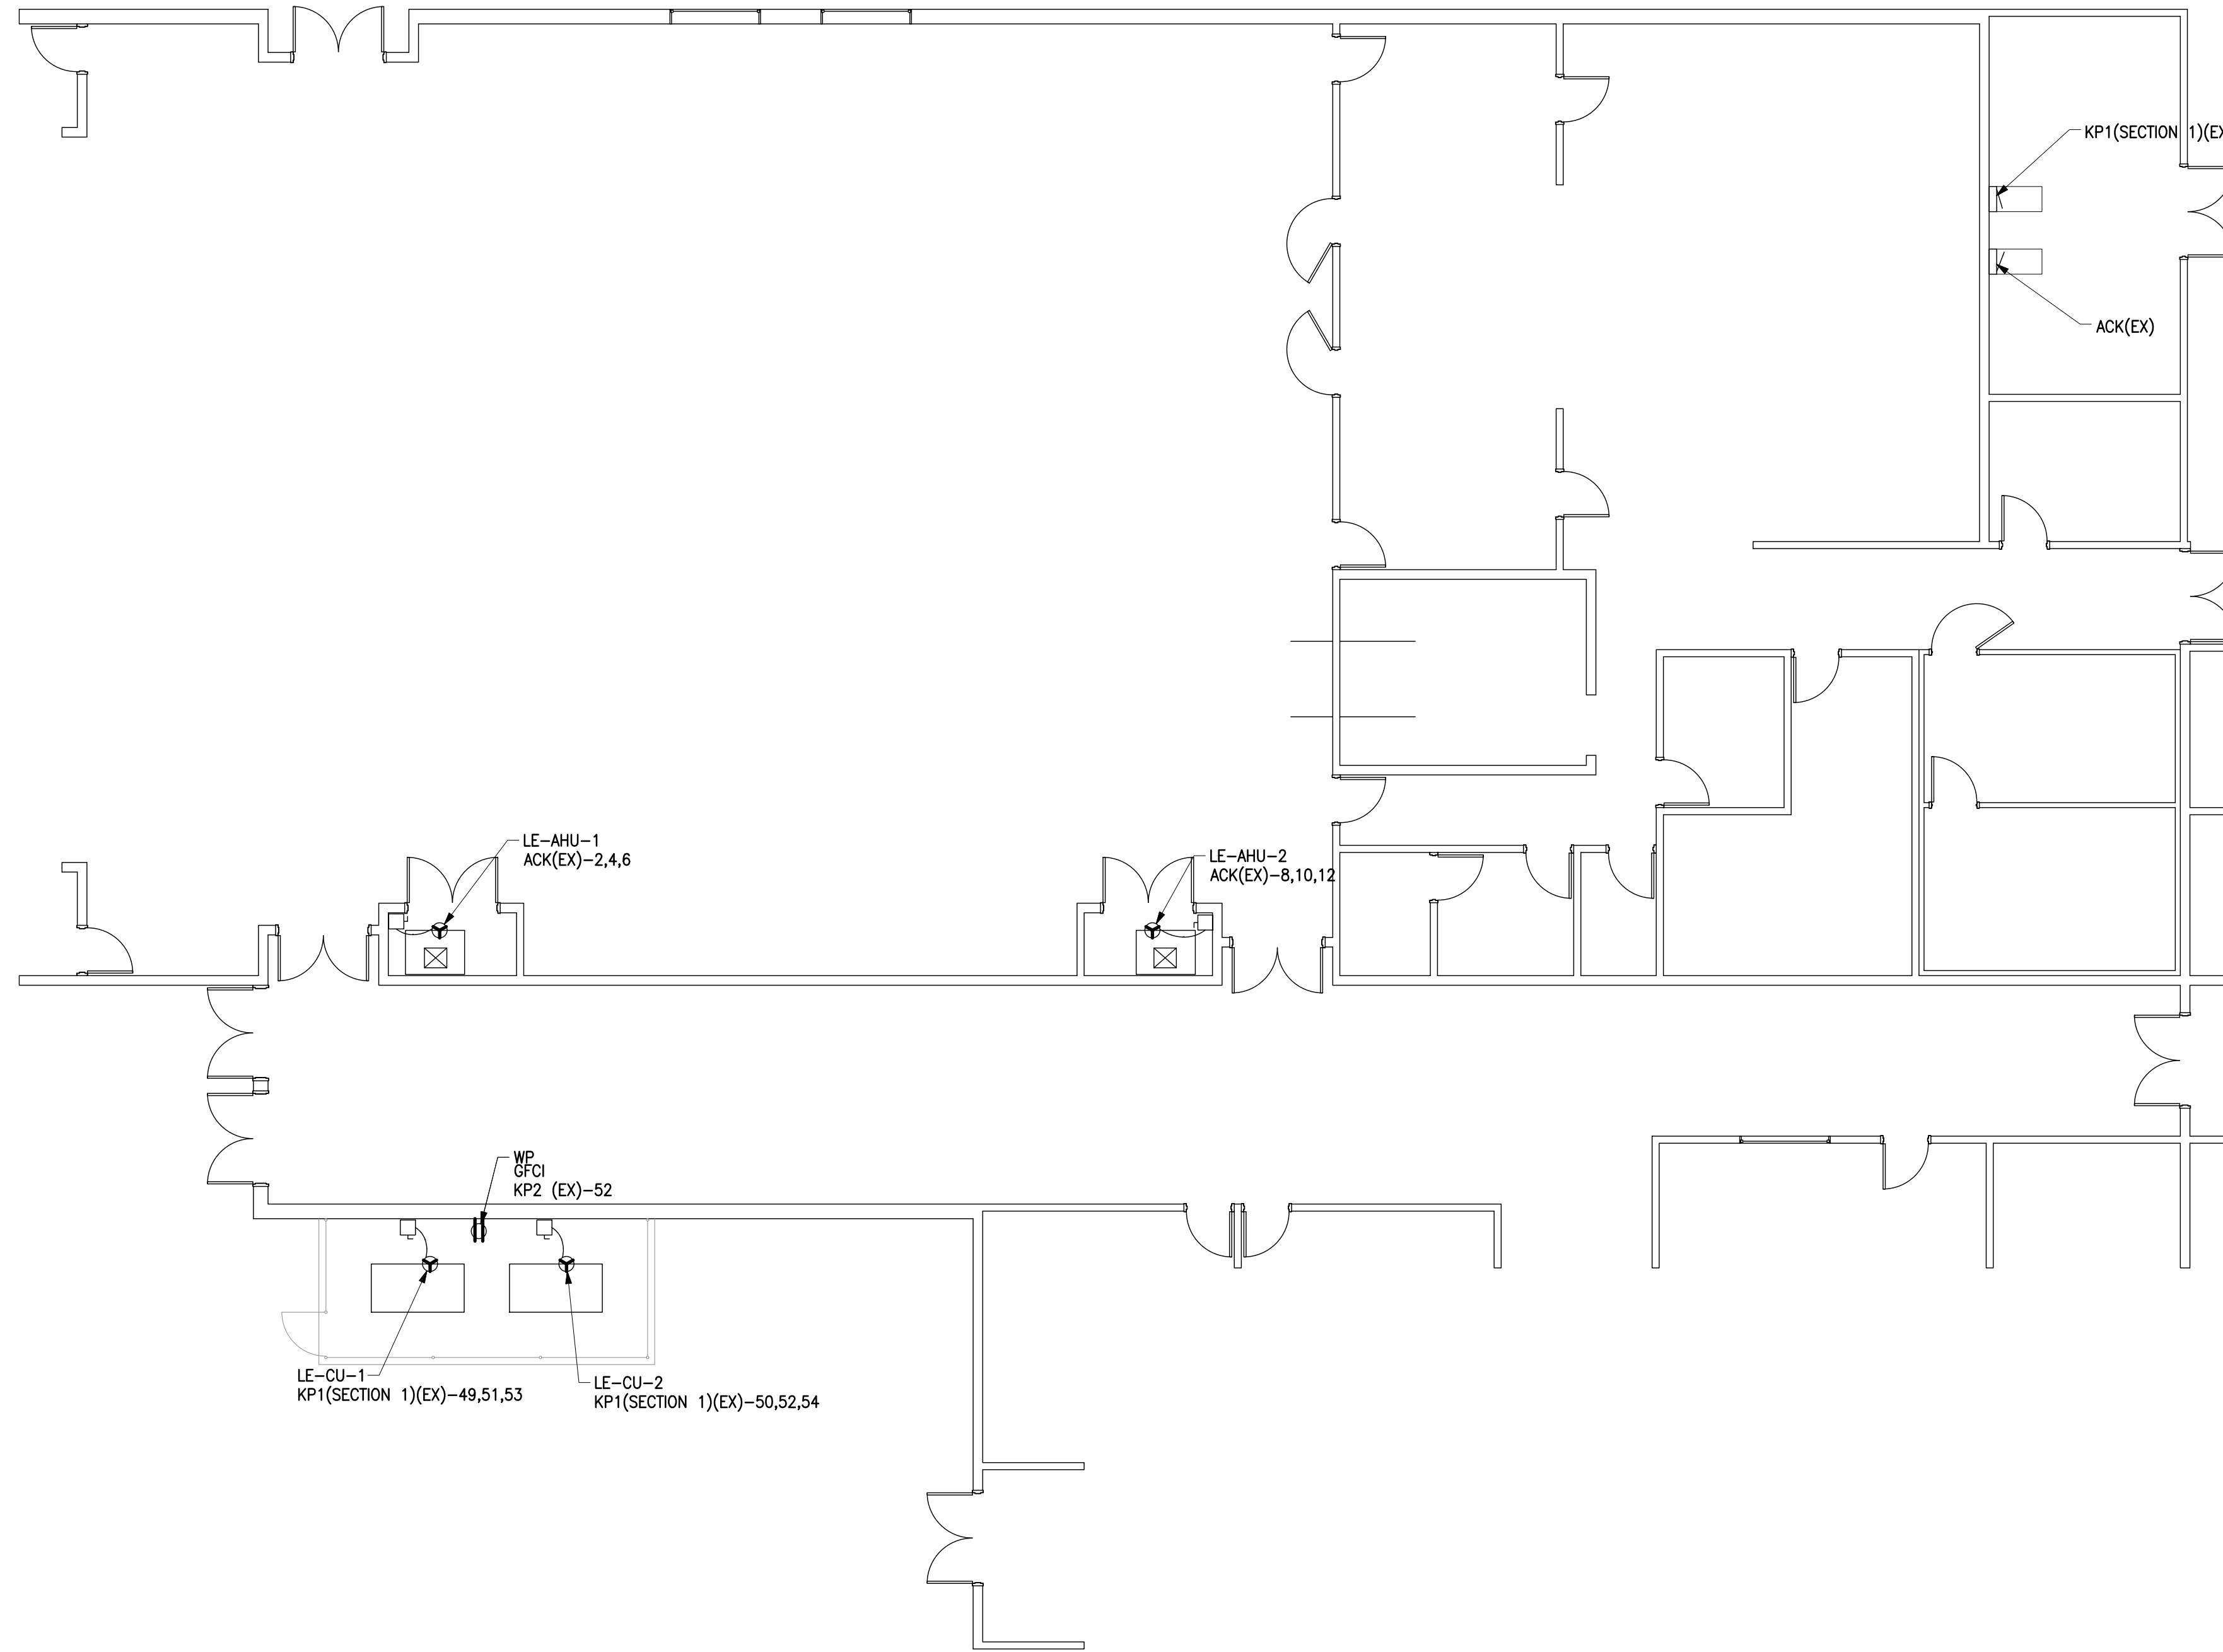
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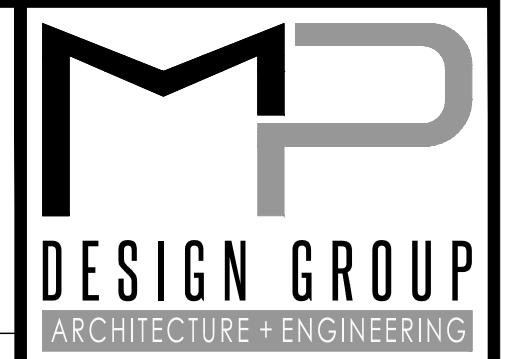
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**1** MECHANICAL POWER PLAN-LOWER ELEMENTARY SCHOOL  
 SCALE: 1/8" = 1'



**DRAWING E151 NOTES**

1. ALL SAFETY SWITCHES SHALL BE PROVIDED AND MOUNTED BY THE E.C. COORDINATE EXACT REQUIREMENTS WITH THE EQUIPMENT MANUFACTURER.
2. COORDINATE EXACT WIRING REQUIREMENTS WITH THE MECHANICAL CONTRACTOR PRIOR TO ROUGHING IN.
3. ALL SAFETY SWITCHES SHALL BE HEAVY DUTY. NEMA 1 - INDOORS, NEMA 12/3R - OUTDOORS.
4. ALL SMOKE DUCT DETECTORS AND DAMPER SMOKE DETECTORS SHALL BE PROVIDED AND INSTALLED BY THE CONTROLS CONTRACTOR. FIRE ALARM CONTRACTOR SHALL BE RESPONSIBLE FOR TYING INTO THE FIRE ALARM SYSTEM. CONTRACTOR SHALL REFERENCE MECHANICAL SHEETS FOR EXACT QUANTITY AND LOCATIONS.
5. CONTRACTOR SHALL REFERENCE SHEET E613 FOR WHERE TO FEED CONVENIENCE RECEPTACLE FROM.



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**VANLEAVE SCHOOLS HVAC UPGRADES**  
**LOWER ELEMENTARY, MIDDLE, & HIGH SCHOOLS**  
 12602 HWY 57, 4725 BULLDOG LN,  
 & 12424 HWY 57  
 VANLEAVE, MISSISSIPPI 39565

SCALE: AS SHOWN  
 PROJECT NO: 0155.22.008  
 DRAWN BY: DLM  
 CHECKED BY: KDB

**MECHANICAL POWER PLAN-  
 LOWER ELEMENTARY SCHOOL**

NO.	DATE	REVISION / SUBMITTAL
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**E151**

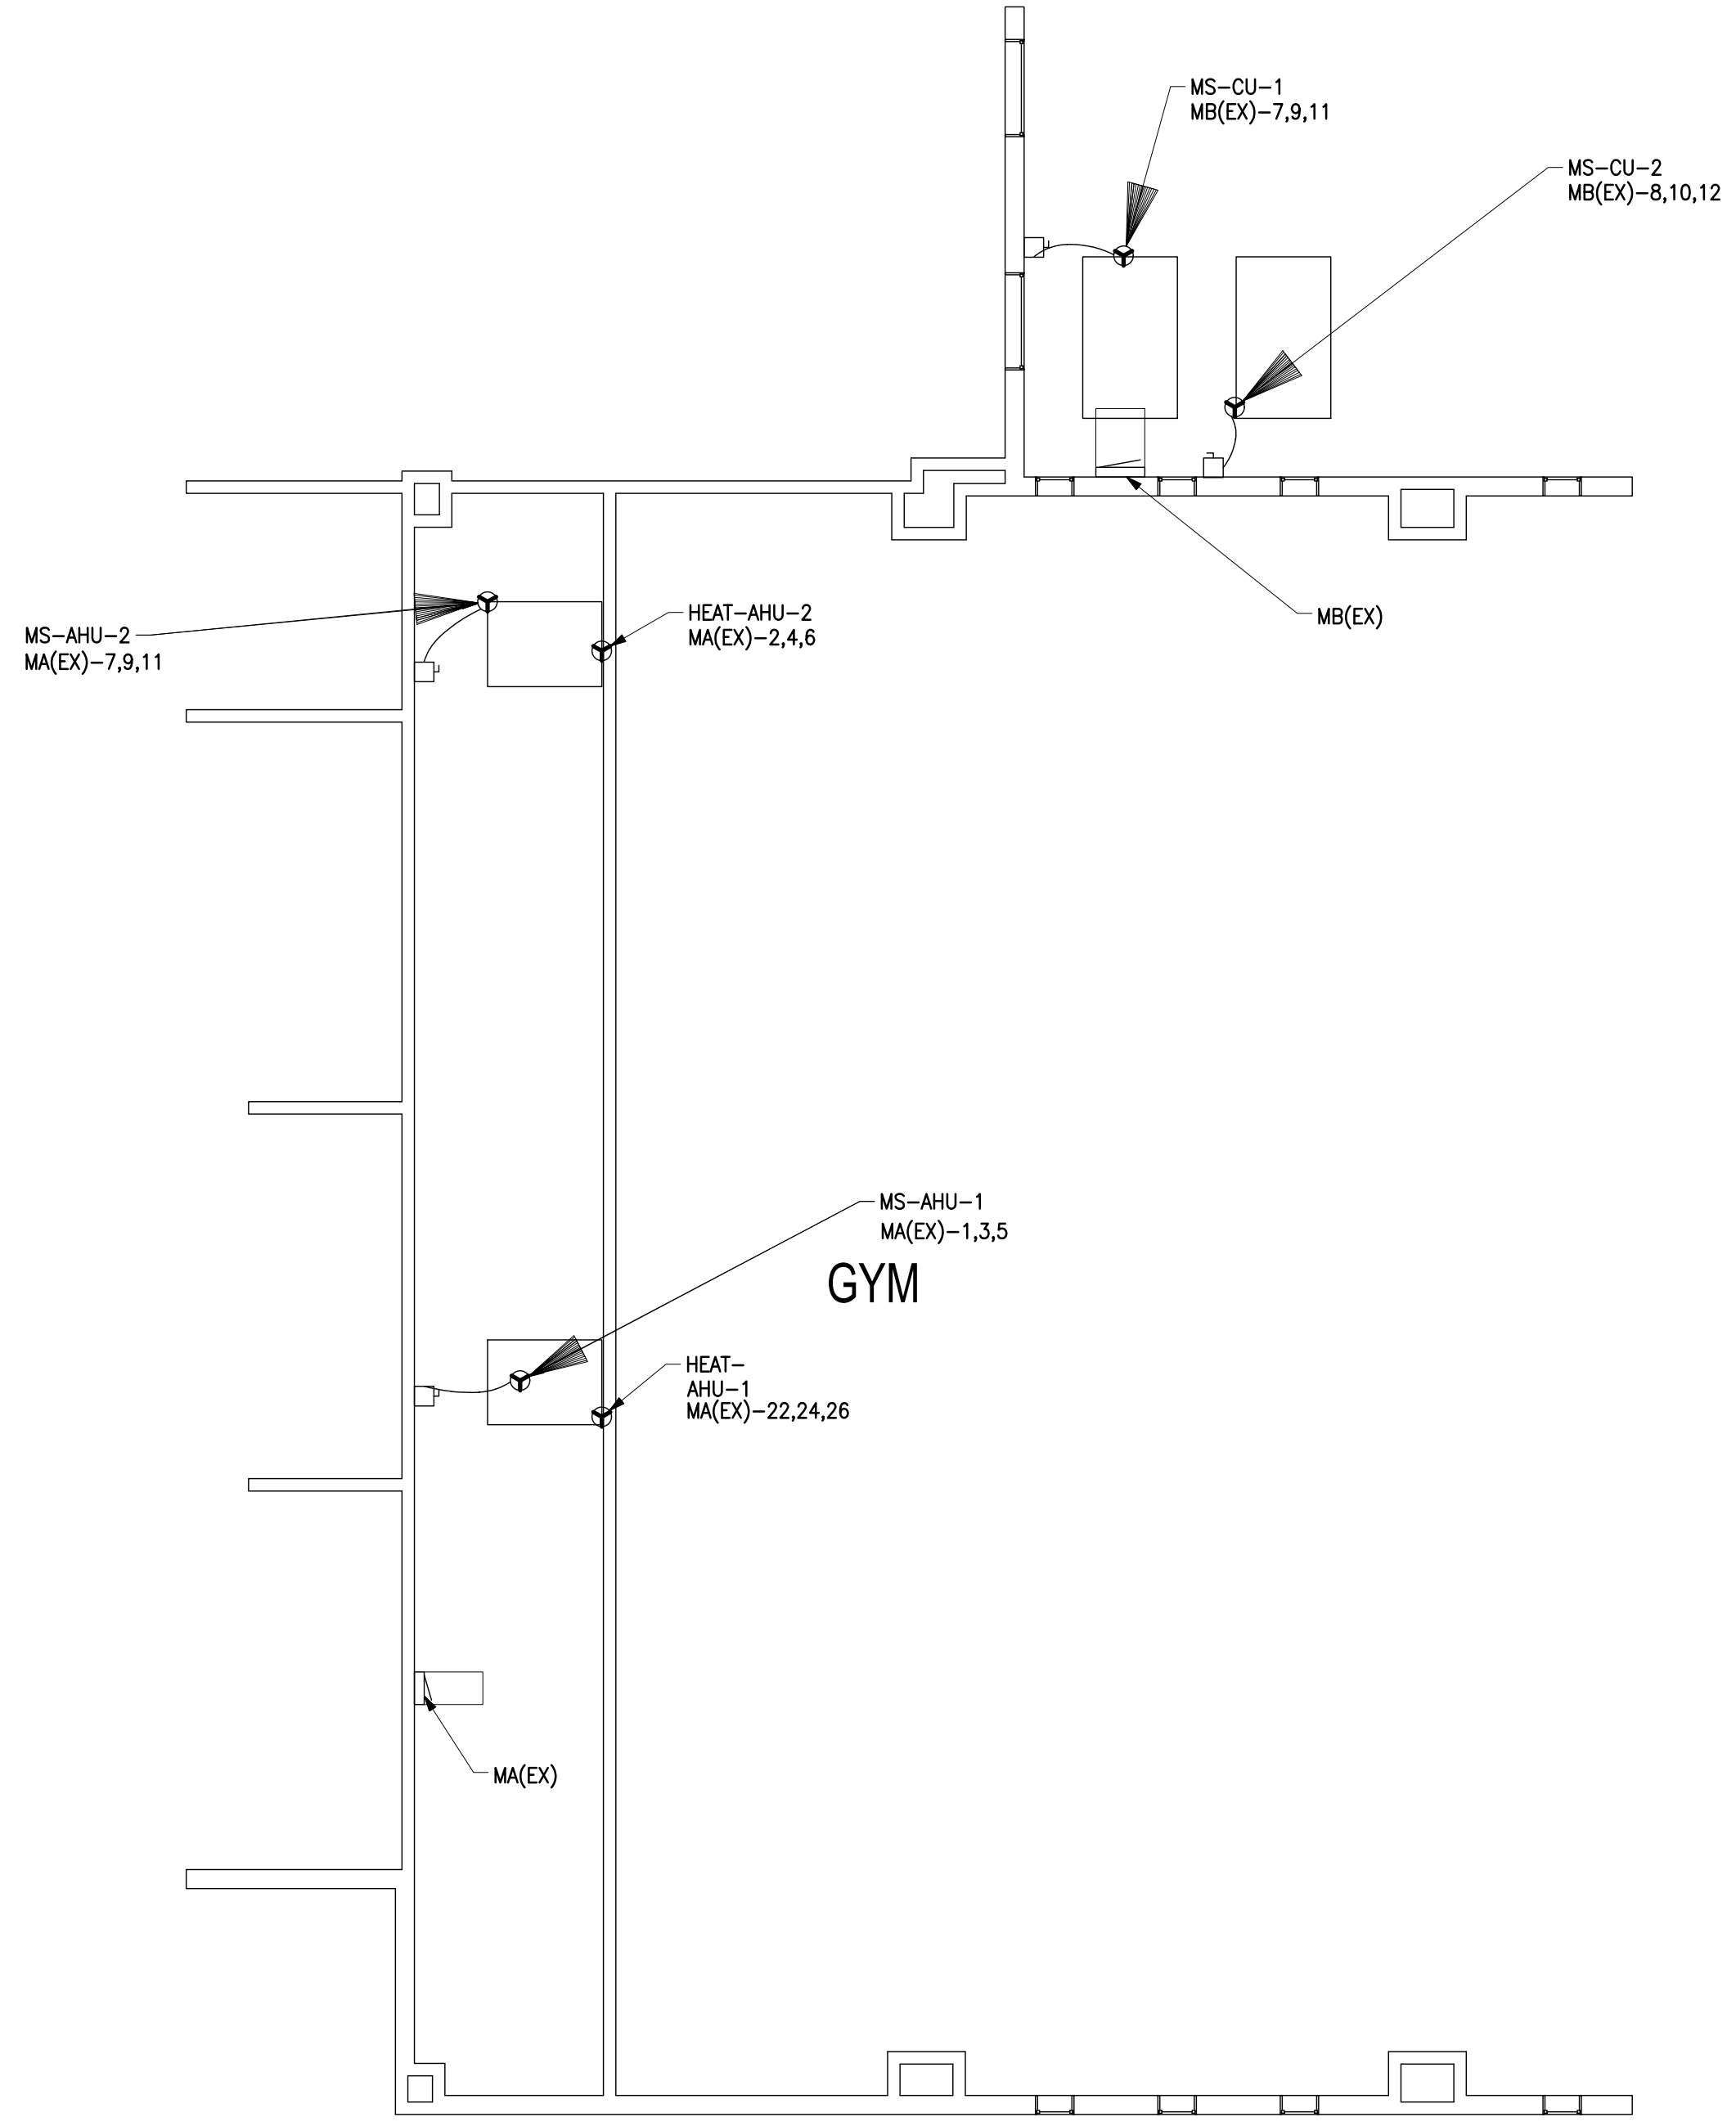
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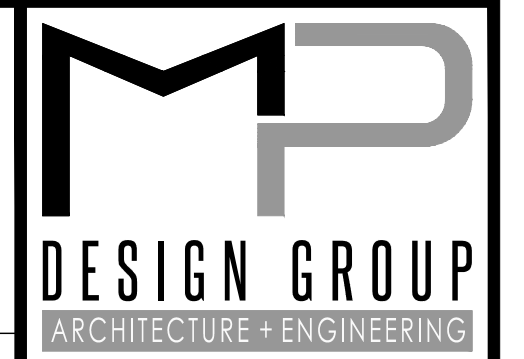


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1 MECHANICAL POWER PLAN-MIDDLE SCHOOL  
 SCALE: 1/8" = 1'



- DRAWING E152 NOTES**
1. ALL SAFETY SWITCHES SHALL BE PROVIDED AND MOUNTED BY THE E.C. COORDINATE EXACT REQUIREMENTS WITH THE EQUIPMENT MANUFACTURER.
  2. COORDINATE EXACT WIRING REQUIREMENTS WITH THE MECHANICAL CONTRACTOR PRIOR TO ROUGHING IN.
  3. ALL SAFETY SWITCHES SHALL BE HEAVY DUTY. NEMA 1 -- INDOORS, NEMA 12/3R -- OUTDOORS.
  4. ALL SMOKE DUCT DETECTORS AND DAMPER SMOKE DETECTORS SHALL BE PROVIDED AND INSTALLED BY THE CONTROLS CONTRACTOR. FIRE ALARM CONTRACTOR SHALL BE RESPONSIBLE FOR TYING INTO THE FIRE ALARM SYSTEM. CONTRACTOR SHALL REFERENCE MECHANICAL SHEETS FOR EXACT QUANTITY AND LOCATIONS.



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**VANCLEAVE SCHOOLS HVAC UPGRADES**  
**LOWER ELEMENTARY, MIDDLE, & HIGH SCHOOLS**  
 12602 HWY 57, 4725 BULLDOG LN,  
 & 12424 HWY 57  
 VANCLEAVE, MISSISSIPPI 39565

SCALE: AS SHOWN  
 PROJECT NO: 0155.22.008  
 DRAWN BY: DLM  
 CHECKED BY: KDB

**MECHANICAL POWER PLAN-  
 MIDDLE SCHOOL**

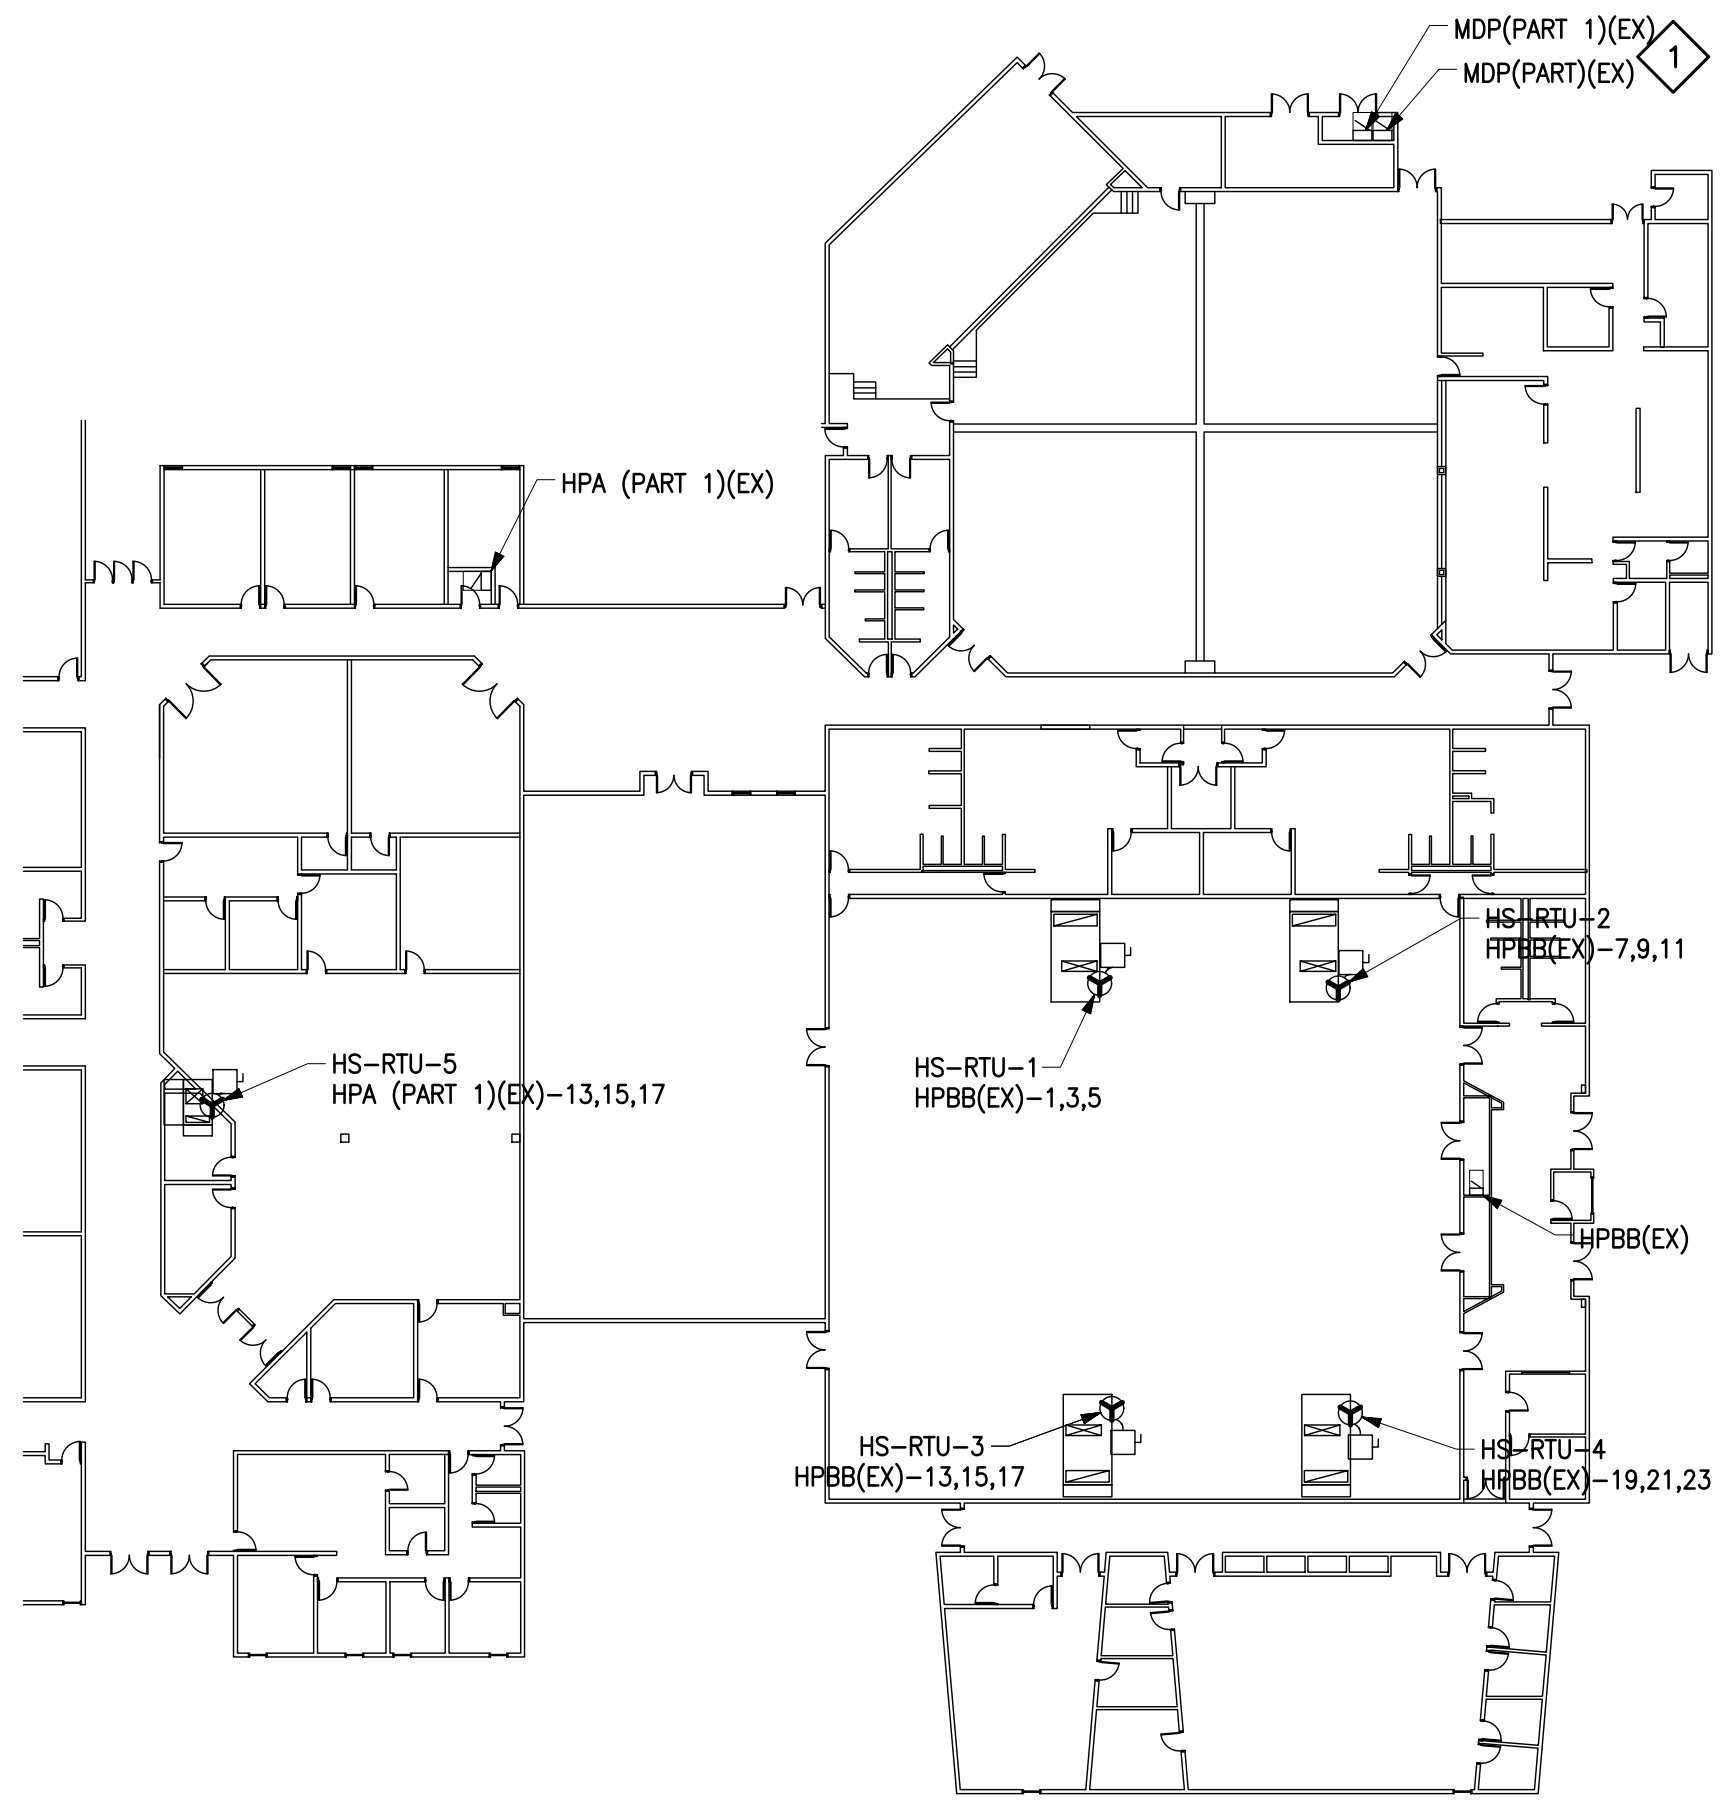
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**E152**  
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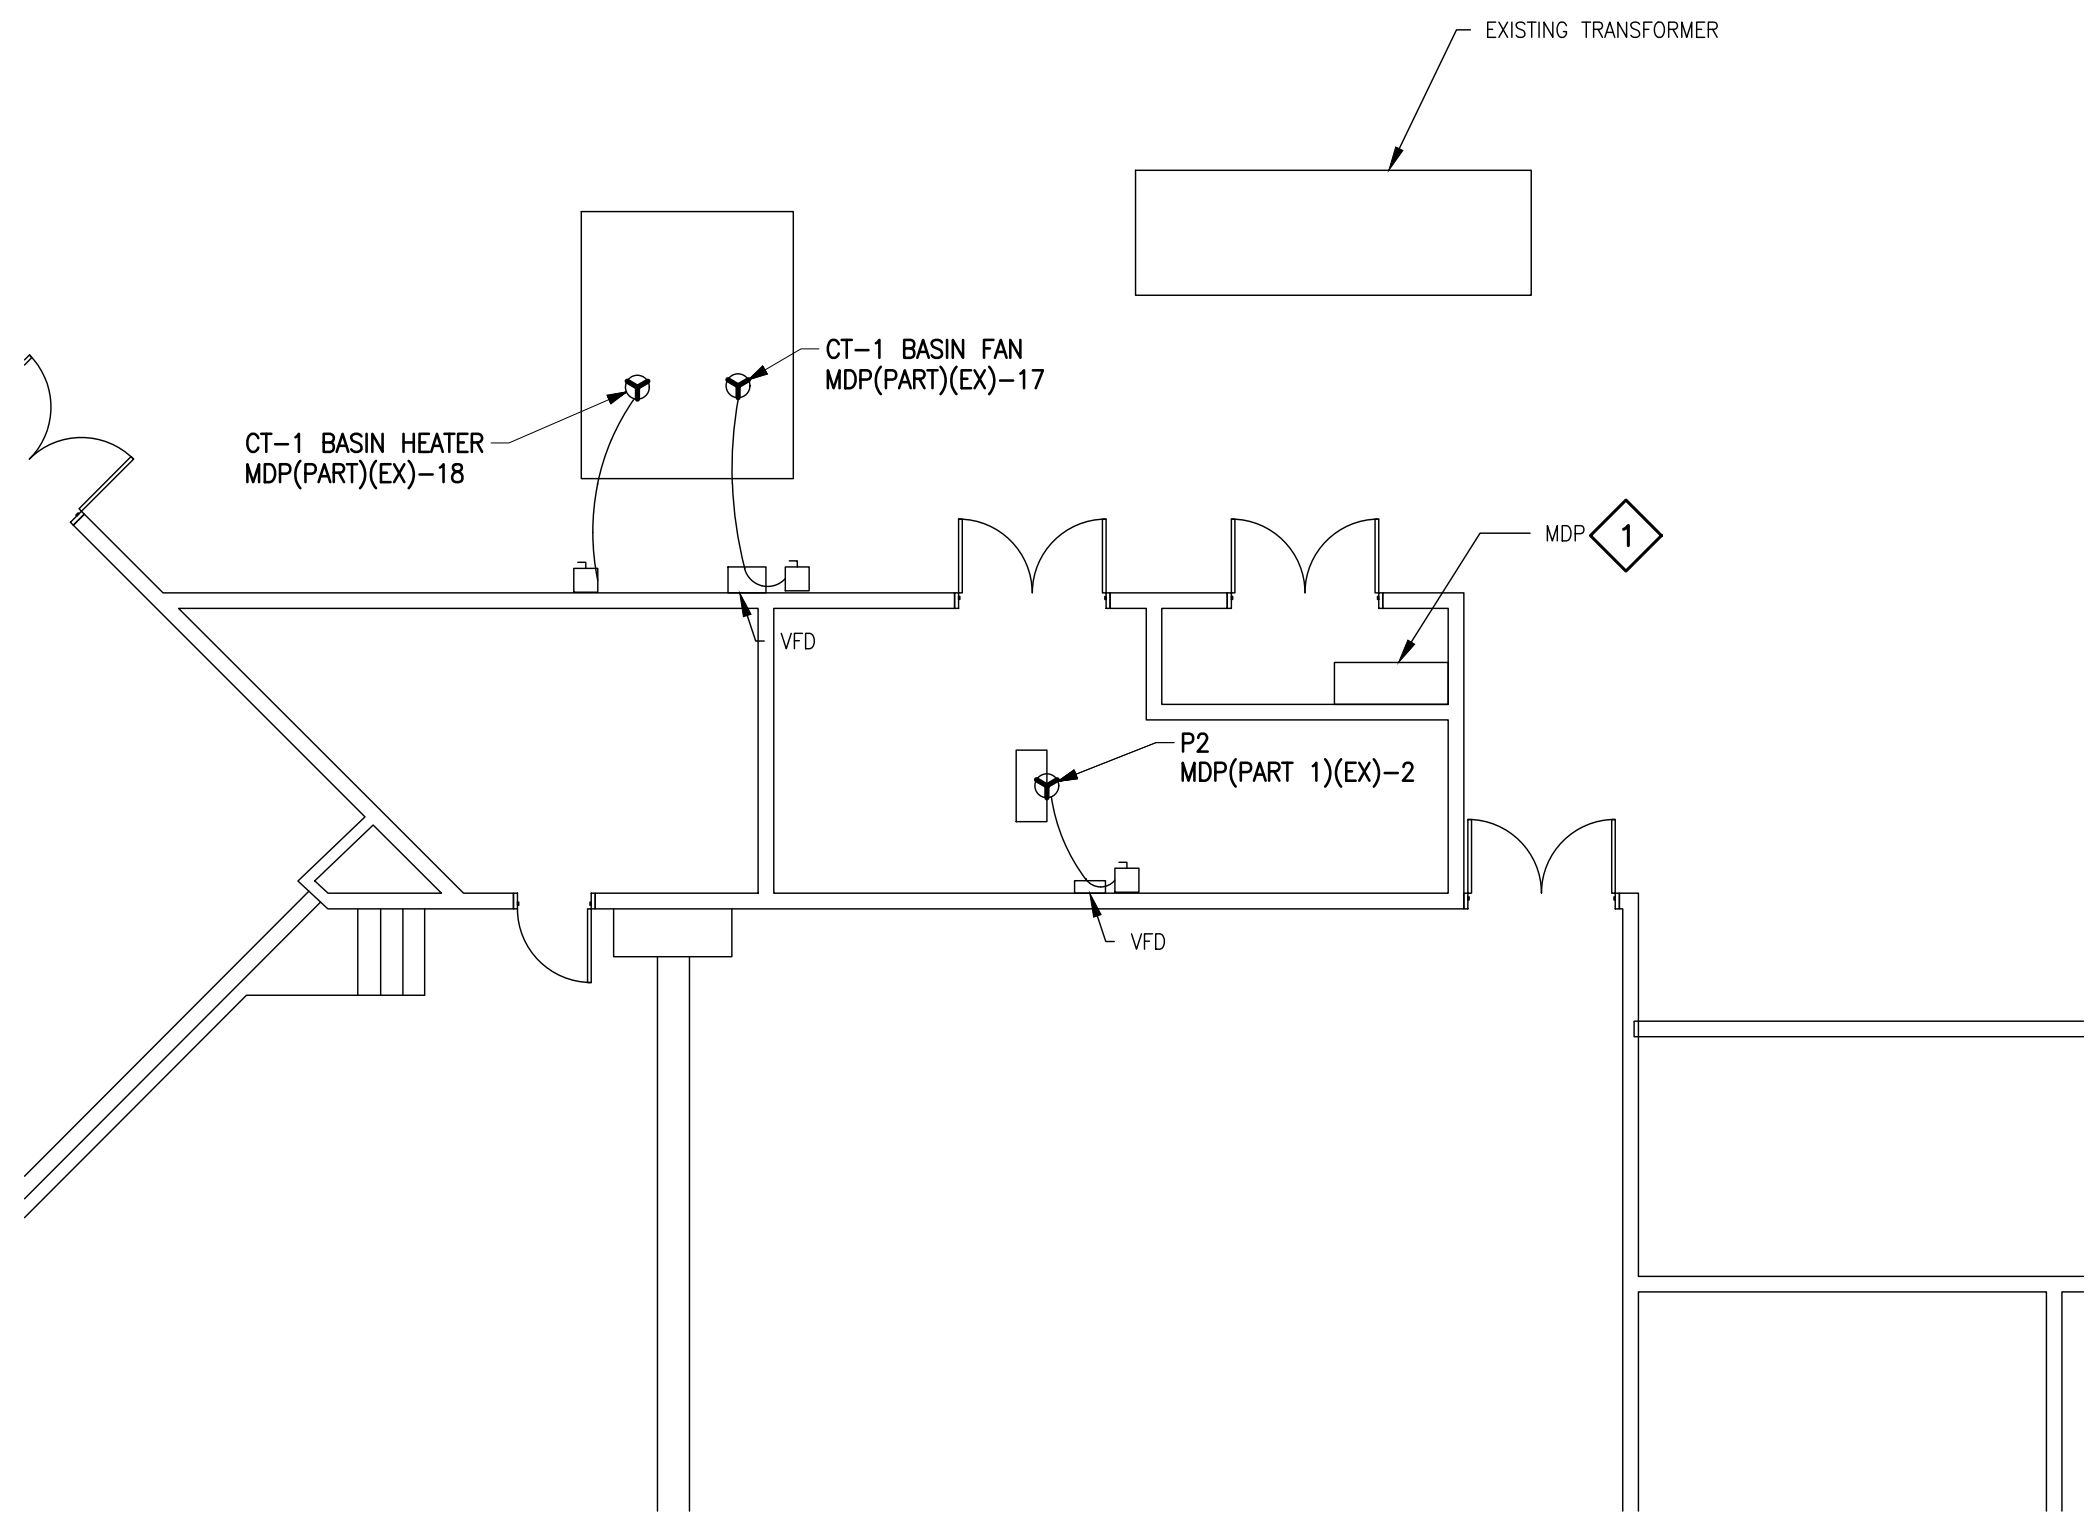
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1 MECHANICAL POWER PLAN-HIGH SCHOOL  
 SCALE: 1/32" = 1'



1 MECHANICAL/ELECTRICAL ROOMS ENLARGED-HIGH SCHOOL  
 SCALE: 1/8" = 1'




**DRAWING E153 NOTES**

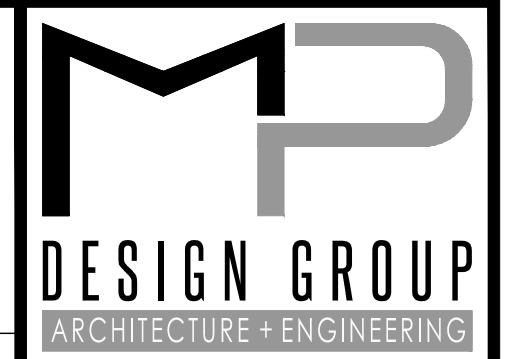- ALL SAFETY SWITCHES SHALL BE PROVIDED AND MOUNTED BY THE E.C. COORDINATE EXACT REQUIREMENTS WITH THE EQUIPMENT MANUFACTURER.
- COORDINATE EXACT WIRING REQUIREMENTS WITH THE MECHANICAL CONTRACTOR PRIOR TO ROUGHING IN.
- ALL SAFETY SWITCHES SHALL BE HEAVY DUTY. NEMA 1 - INDOORS, NEMA 12/3R - OUTDOORS.
- ALL SMOKE DUCT DETECTORS AND DAMPER SMOKE DETECTORS SHALL BE PROVIDED AND INSTALLED BY THE CONTROLS CONTRACTOR. FIRE ALARM CONTRACTOR SHALL BE RESPONSIBLE FOR TYING INTO THE FIRE ALARM SYSTEM. CONTRACTOR SHALL REFERENCE MECHANICAL SHEETS FOR EXACT QUANTITY AND LOCATIONS.
- CONTRACTOR SHALL REPLACE EXISTING MDP WITH NEW MDP AS ALTERNATE #1. CONTRACTOR SHALL PLACE NEW MDP IN EXISTING LOCATION. CONTRACTOR SHALL REFERENCE SHEET E611 FOR NEW MDP REQUIREMENTS.

**DRAWING E153 SPECIFIC NOTES**

1 ALTERNATE 1: CONTRACTOR SHALL PROVIDE AND INSTALL NEW SWITCHBOARD MDP. CONTRACTOR SHALL CONNECT EXISTING FEEDER CONDUCTOR TO NEW SWITCHBOARD. CONTRACTOR SHALL MODIFY FEEDER CONDUCTOR AND CONDUIT AS REQUIRED. CONTRACTOR SHALL FIELD COORDINATE EXISTING MDP SIZE AND MATCH WITH NEW MDP. SEE SHEET E611 FOR DETAILS.



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**VANLEAVE SCHOOLS HVAC UPGRADES**  
**LOWER ELEMENTARY, MIDDLE, & HIGH SCHOOLS**  
 12602 HWY 57, 4725 BULLDOG LN,  
 & 12424 HWY 57  
 VANLEAVE, MISSISSIPPI 39565

SCALE: AS SHOWN  
 PROJECT NO: 0155.22.008  
 DRAWN BY: DLM  
 CHECKED BY: KDB

**MECHANICAL POWER PLAN-  
 HIGH SCHOOL**

NO.	DATE	REVISION / SUBMITTAL
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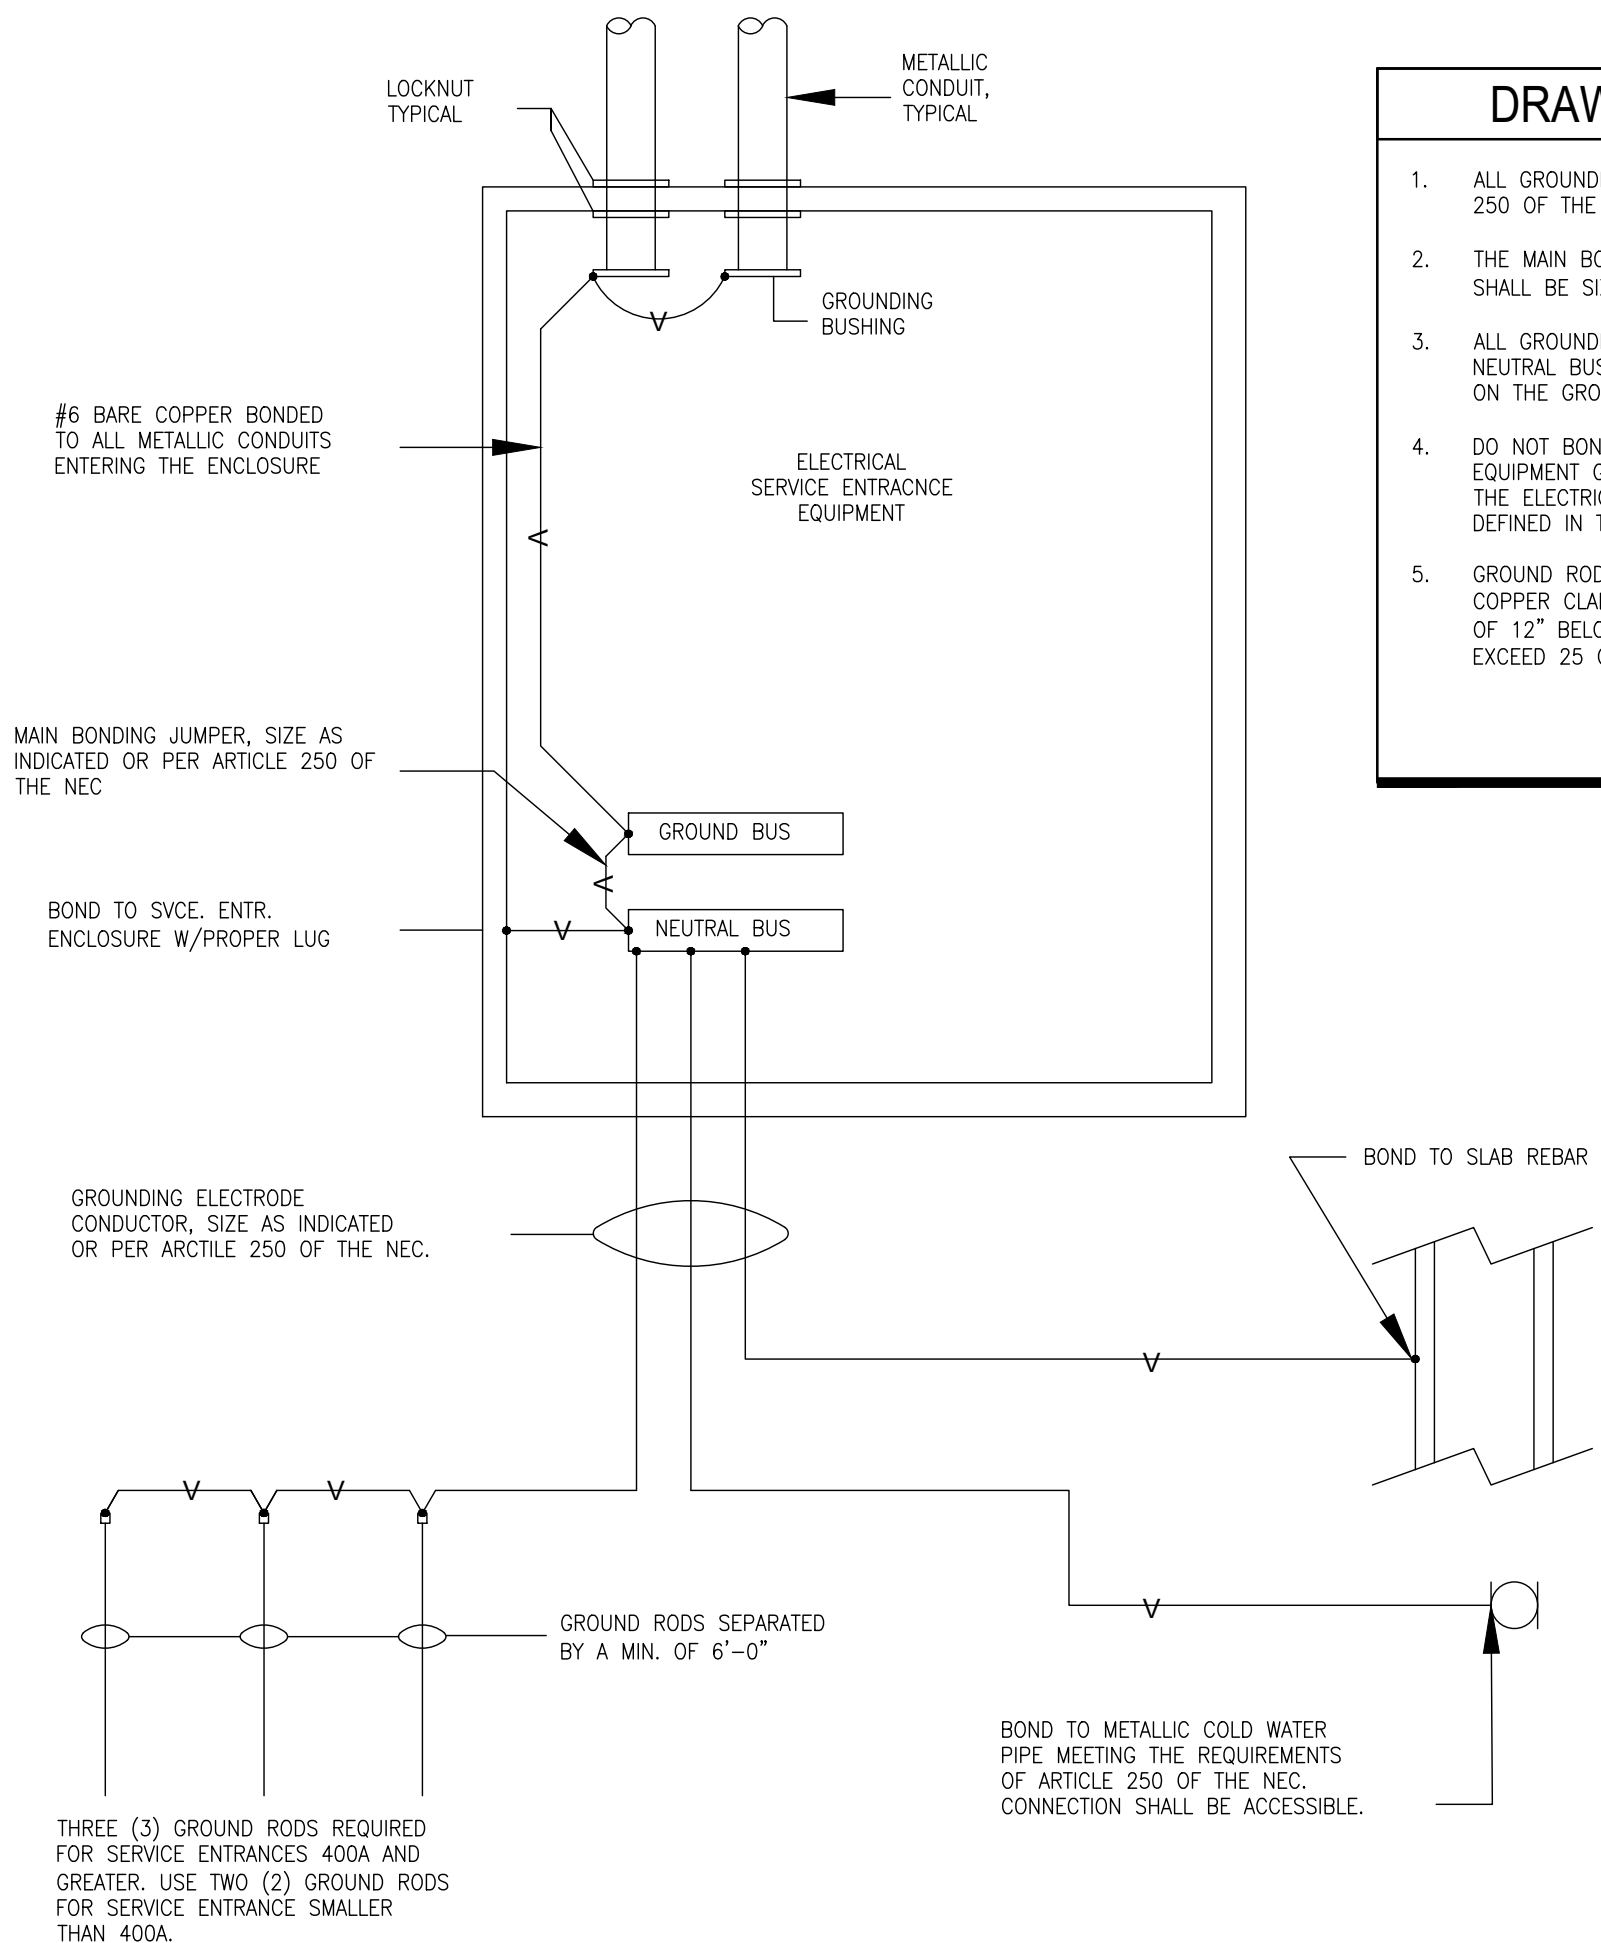
**E153**

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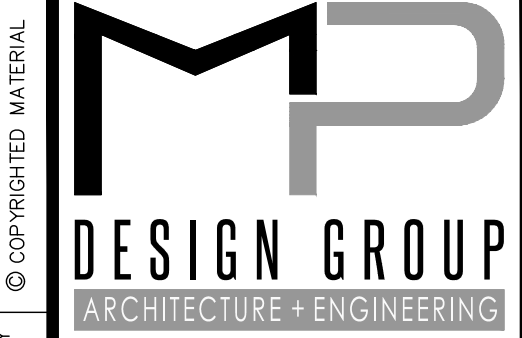
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- ### DRAWING E501 SPECIFIC NOTES
- ALL GROUNDING AND BONDING SHALL BE IN ACCORDANCE WITH ARTICLE 250 OF THE NEC.
  - THE MAIN BONDING JUMPER & THE GROUNDING ELECTRODE CONDUCTOR(S) SHALL BE SIZED AS INDICATED AND/OR PER NEC ARTICLE 250.
  - ALL GROUNDED (NEUTRAL) CONDUCTORS SHALL TERMINATE ON THE NEUTRAL BUS & ALL EQUIPMENT GROUNDING CONDUCTOR SHALL TERMINATE ON THE GROUND BUS. ONE LUG OR TERMINAL PER CONDUCTOR.
  - DO NOT BOND OR CONNECT THE GROUNDED (NEUTRAL) CONDUCTOR & THE EQUIPMENT GROUNDING CONDUCTOR TOGETHER AT ANY OTHER POINT IN THE ELECTRICAL SYSTEM EXCEPT AT SEPARATELY DERIVED SYSTEMS AS DEFINED IN THE NEC.
  - GROUND RODS USED FOR GROUNDING ELECTRODE SYSTEMS SHALL BE COPPER CLAD, 3/4"x10' MIN. AND SHALL BE INSTALLED WITH TOP A MIN. OF 12" BELOW FINISHED GRADE. RESISTANCE TO GROUND SHALL NOT EXCEED 25 OHMS PER NEC.

# 1 GROUNDING AND BONDING DETAIL

SCALE: NTS



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 VANLEAVE, MISSISSIPPI 39565

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**ELECTRICAL GENERAL DETAILS**

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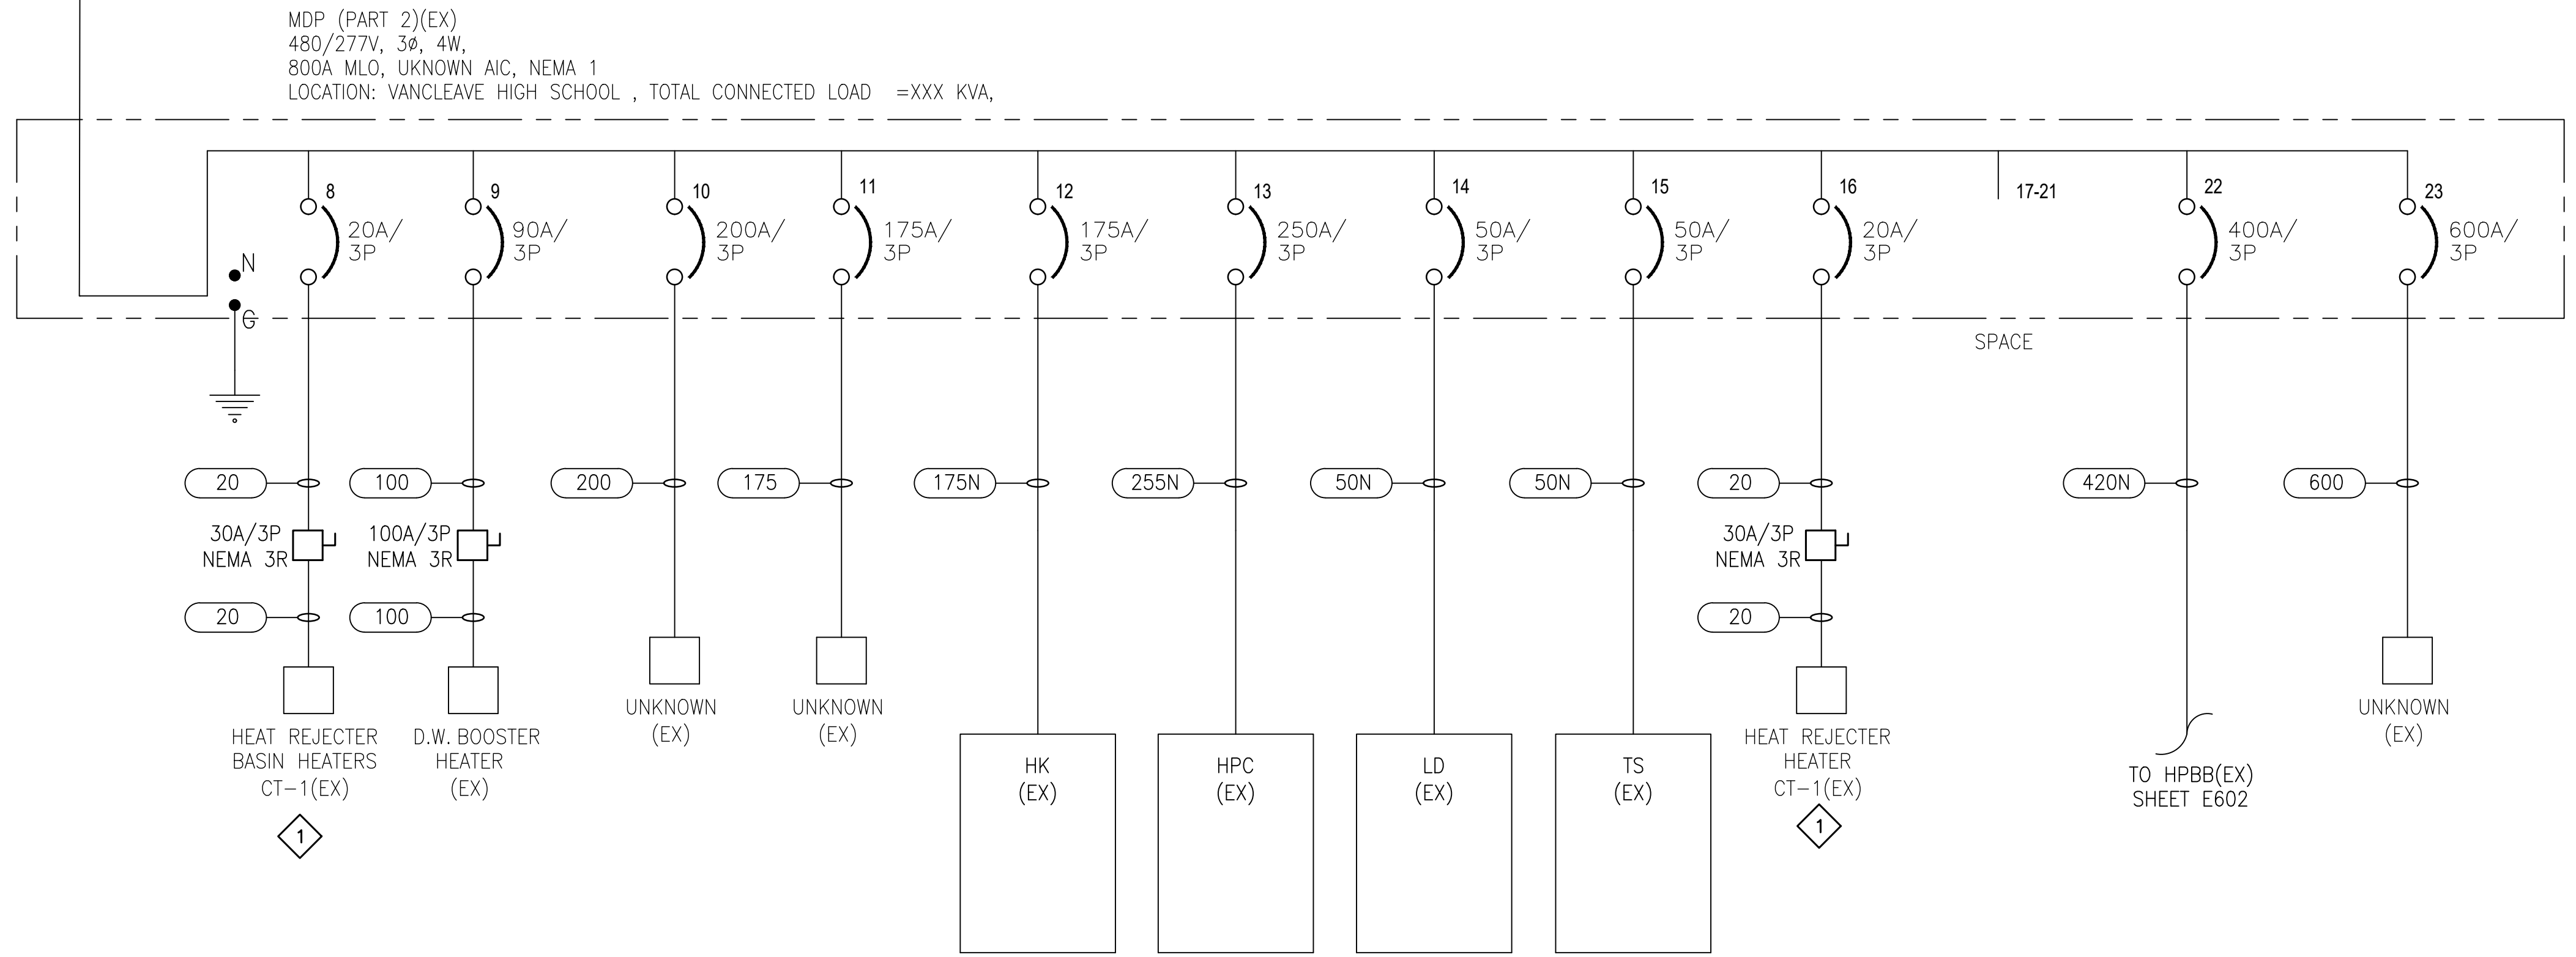
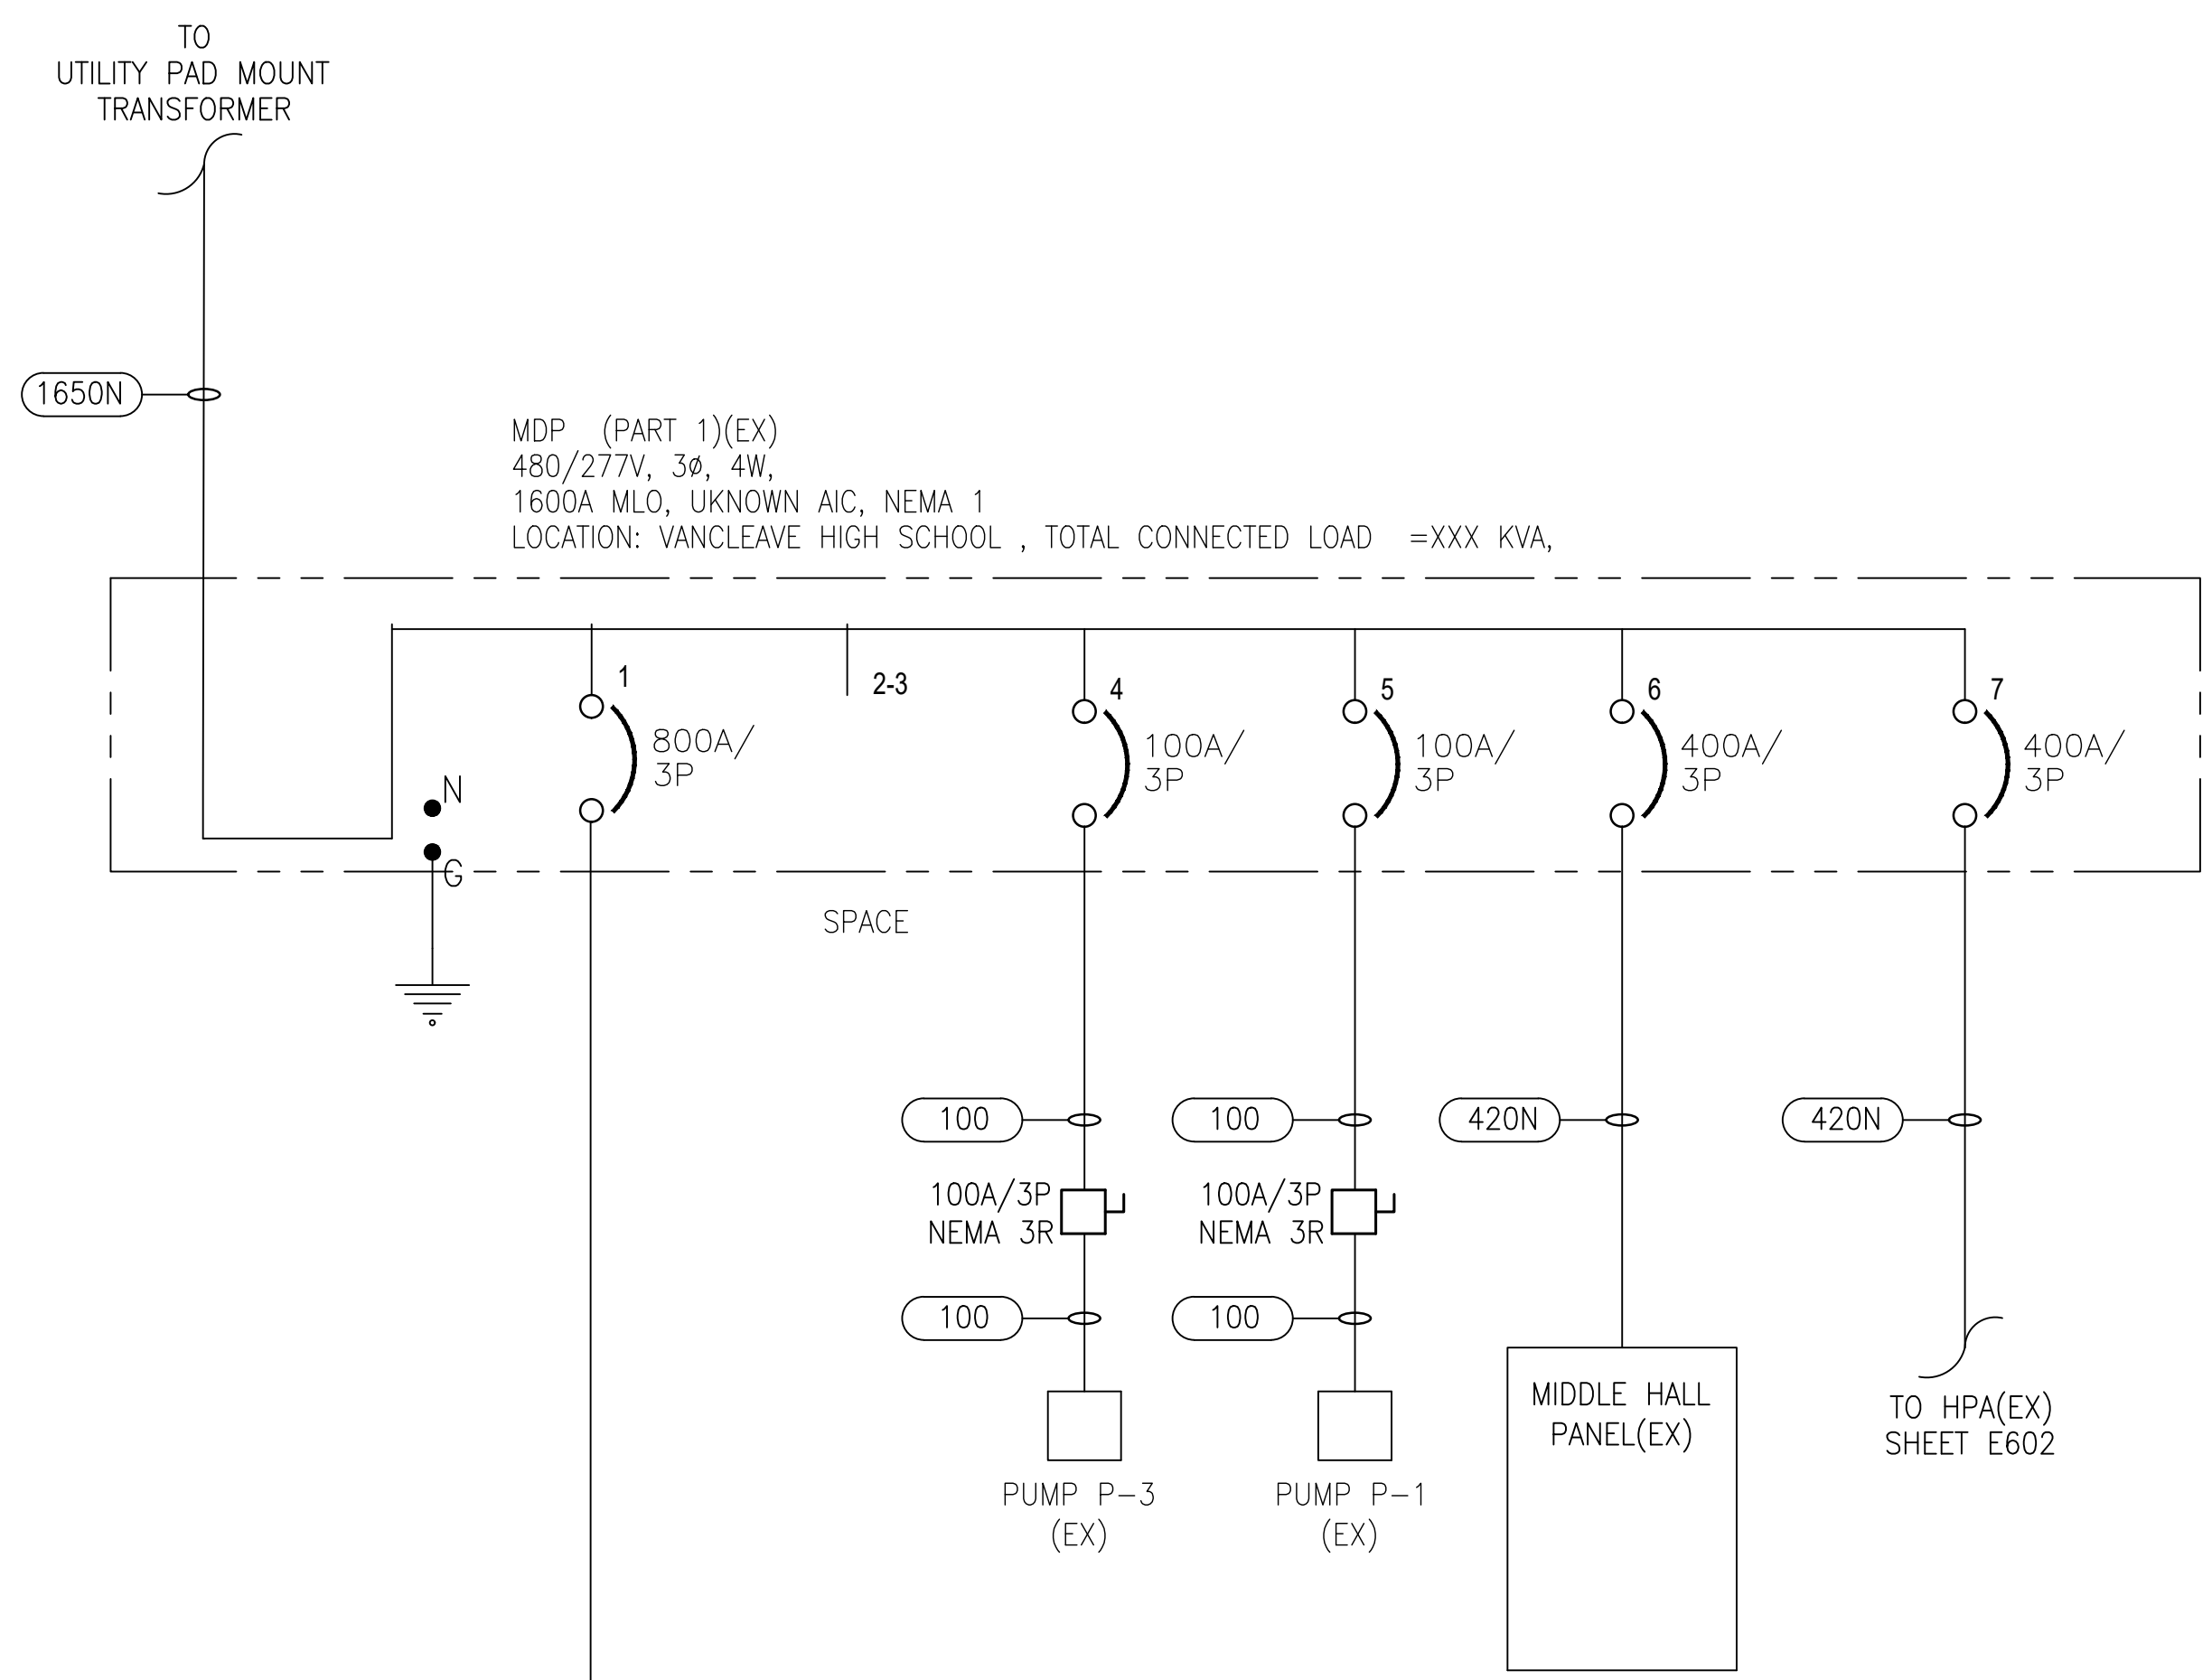
## E501

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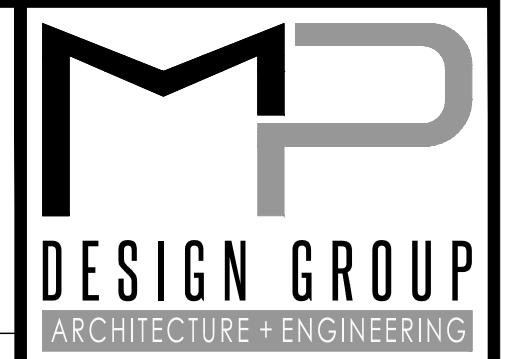


**DRAWING E601 NOTES**

- CONTRACTOR SHALL COORDINATE WITH OWNER PRIOR TO DISPOSING ALL DEMOLISHED EQUIPMENT.
- CONTRACTOR SHALL FILED VERIFY EXISTING PANEL BOARD SCHEDULE.

**DRAWING E601 SPECIFIC NOTES**

1 CONTRACTOR SHALL DEMOLISH EXISTING SAFETY SWITCH AND CONTROLS, CONTRACTOR SHALL DEMOLISH FEED FROM SOURCE TO DISCONNECT. CONTRACTOR SHALL DEMOLISH FEED FROM DISCONNECT TO EQUIPMENT. CONTRACTOR SHALL DEMOLISH ALL CONDUIT ABOVE GRADE. CONTRACTOR SHALL ABANDON CONDUIT 6" BELOW GRADE.



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**VANCLEAVE SCHOOLS HVAC UPGRADES**  
**LOWER ELEMENTARY, MIDDLE, & HIGH SCHOOLS**  
 12602 HWY 57, 4725 BULLDOG LN,  
 & 12424 HWY 57  
 VANCLEAVE, MISSISSIPPI 39565

SCALE: NTS  
 PROJECT NO: 0155.22.008  
 DRAWN BY: DLM  
 CHECKED BY: KDB

**ELECTRICAL ONE-LINE DIAGRAM**  
**DEMOLITION PLAN- HIGH SCHOOL**

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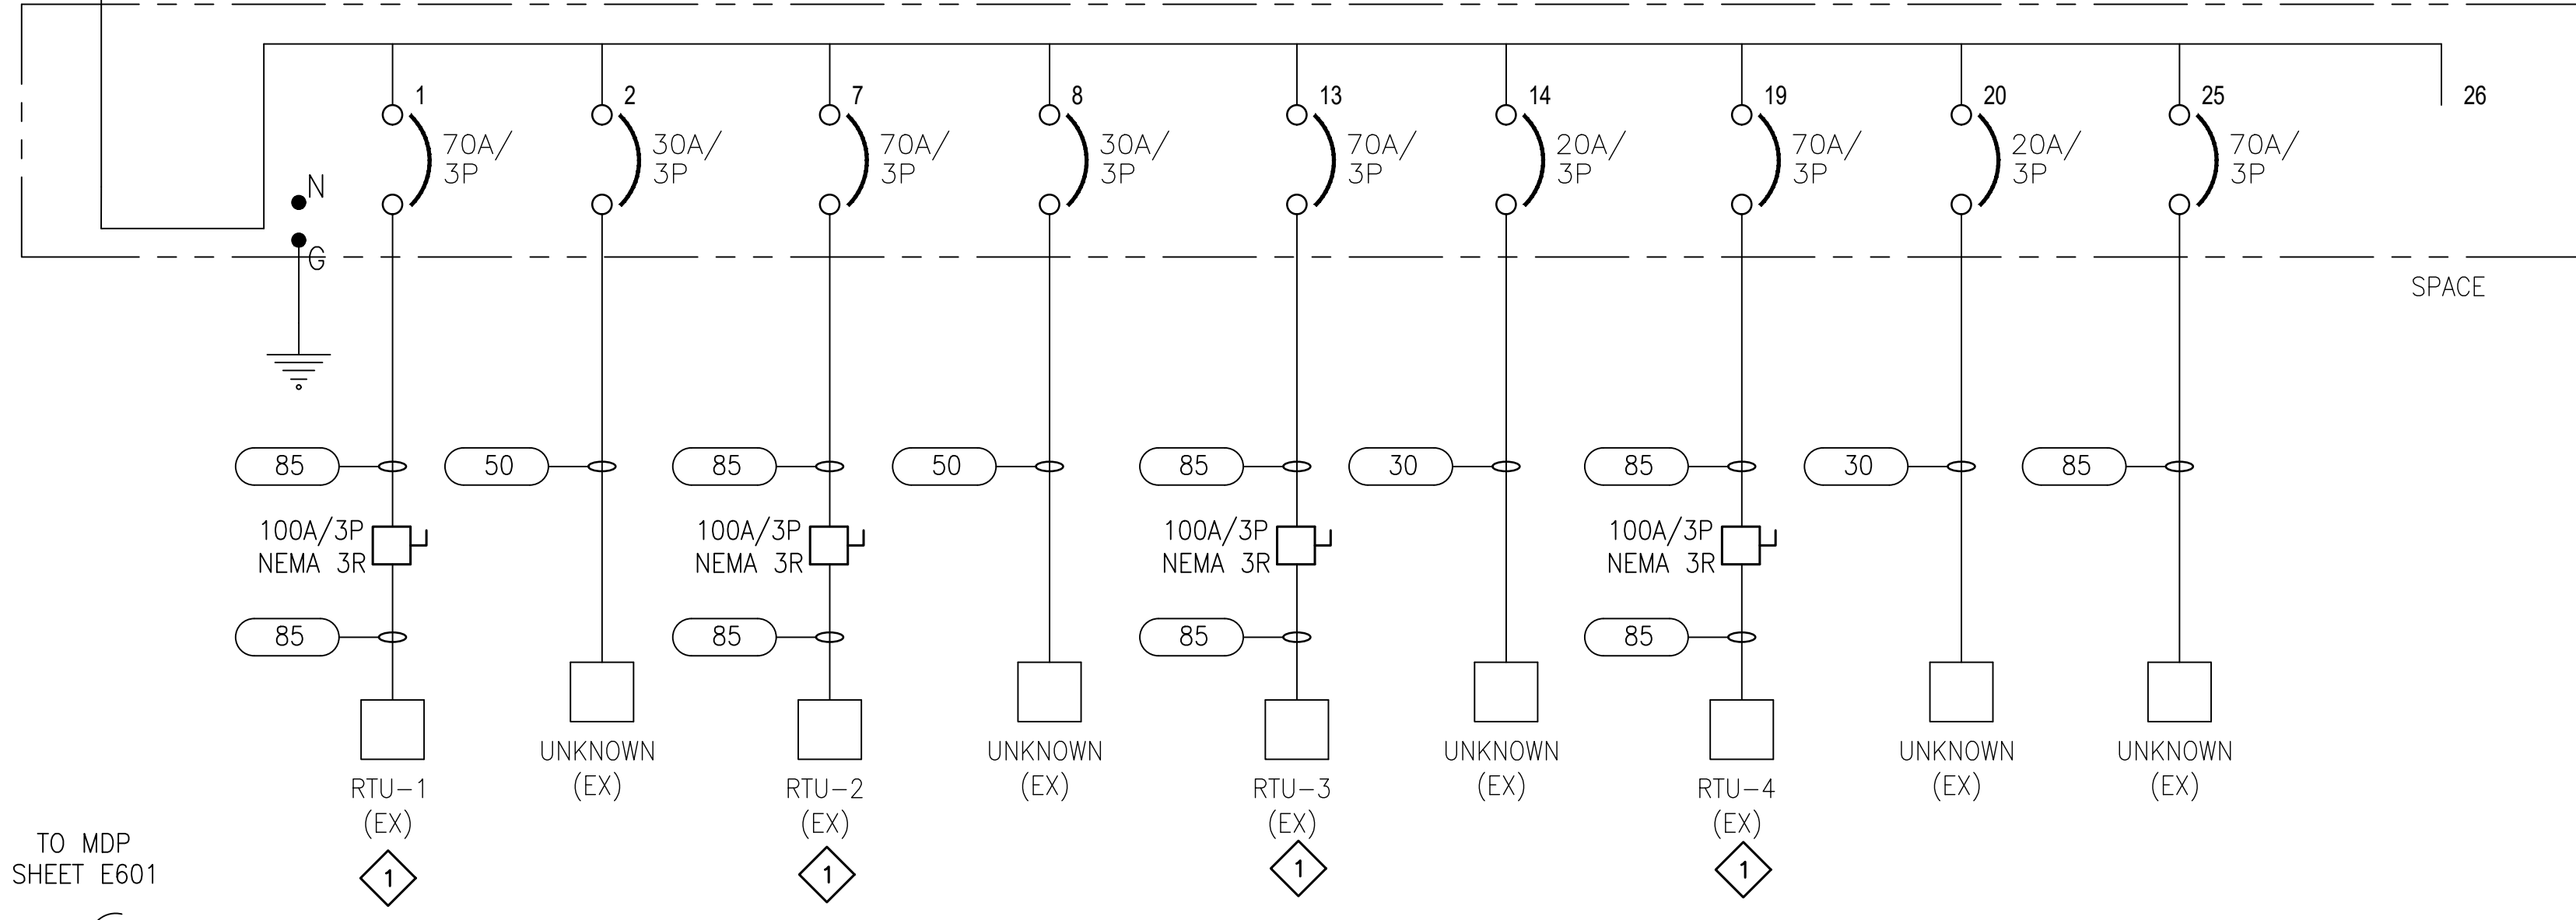
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TO MDP SHEET E601


HPBB (EX)  
 480/277V, 3Ø, 4W,  
 400A MLO, UNKNOWN AIC, NEMA 1  
 LOCATION: VANCLEAVE HIGH SCHOOL , TOTAL CONNECTED LOAD =XXX KVA,



TO MDP SHEET E601

420N

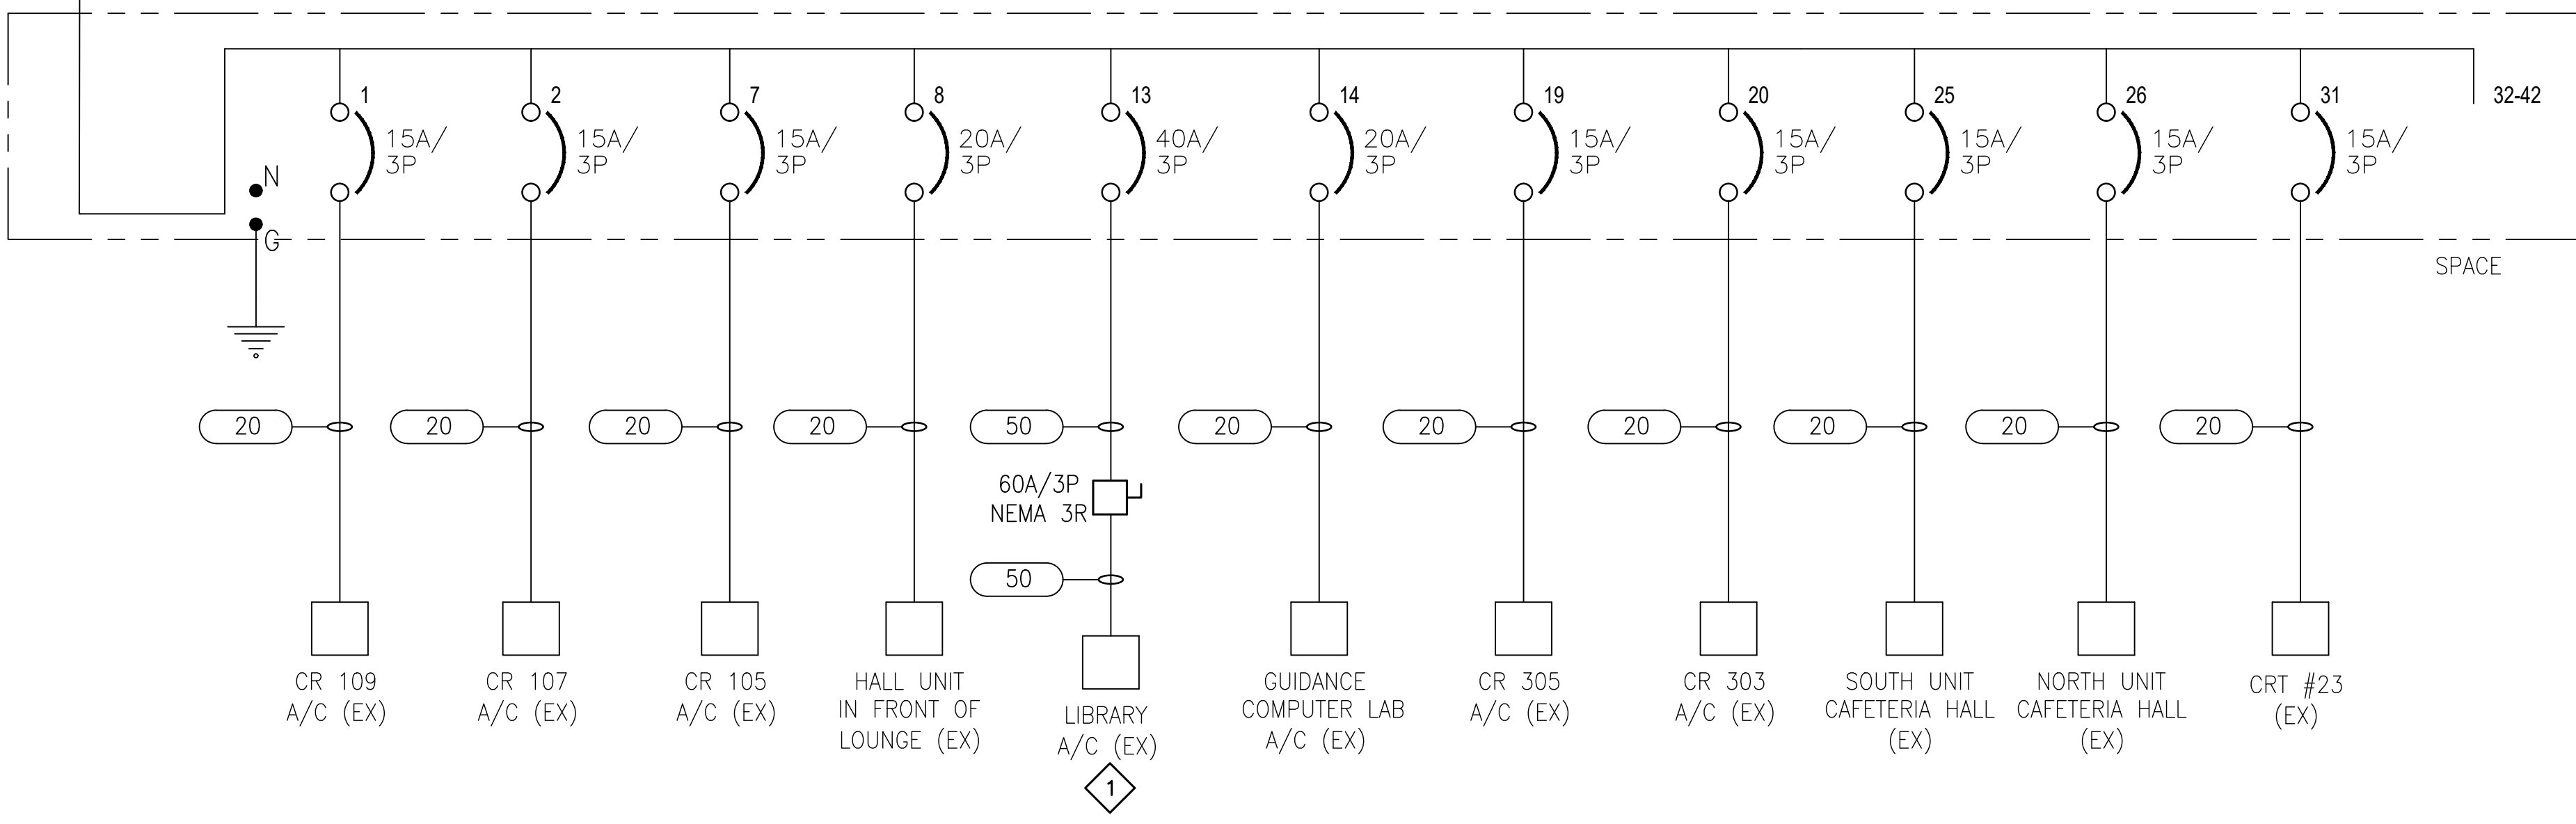HPA (PART 1)(EX)  
 480/277V, 3Ø, 4W,  
 400A MLO, UNKNOWN AIC, NEMA 1  
 LOCATION: VANCLEAVE HIGH SCHOOL , TOTAL CONNECTED LOAD =XXX KVA,




**DRAWING E602 NOTES**

1. CONTRACTOR SHALL COORDINATE WITH OWNER PRIOR TO DISPOSING ALL DEMOLISHED EQUIPMENT.
2. CONTRACTOR SHALL FILED VERIFY EXISTING PANEL BOARD SCHEDULE.


**DRAWING E602 SPECIFIC NOTES**

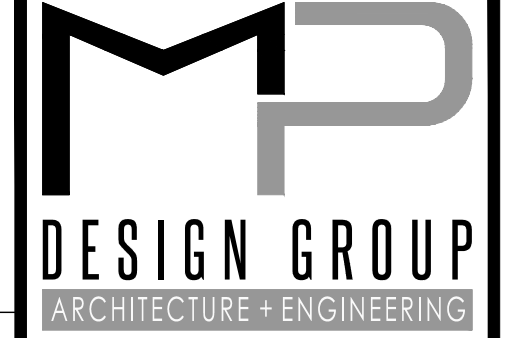1. CONTRACTOR SHALL DEMOLISH EXISTING SAFETY SWITCH AND CONTROLS, CONTRACTOR SHALL DEMOLISH FEED FROM SOURCE TO DISCONNECT. CONTRACTOR SHALL DEMOLISH FEED FROM DISCONNECT TO EQUIPMENT. CONTRACTOR SHALL DEMOLISH ALL CONDUIT ABOVE GRADE. CONTRACTOR SHALL ABANDON CONDUIT 6" BELOW GRADE.



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 & 12424 HWY 57  
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SCALE: NTS  
 PROJECT NO: 0155.22.008  
 DRAWN BY: DLM  
 CHECKED BY: KDB

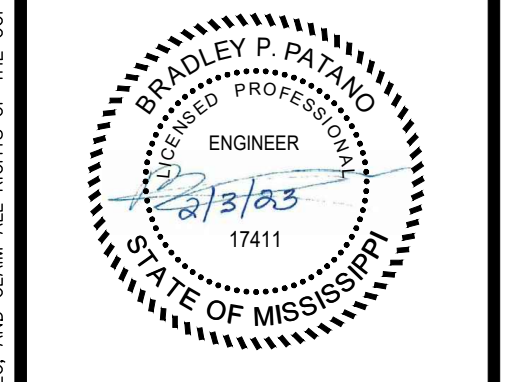**ELECTRICAL ONE-LINE DIAGRAM**  
**DEMOLITION PLAN- HIGH SHCOOL**

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**E602**

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**DRAWING E603 NOTES**


1. CONTRACTOR SHALL COORDINATE WITH OWNER PRIOR TO DISPOSING ALL DEMOLISHED EQUIPMENT.
2. CONTRACTOR SHALL FILED VERIFY EXISTING PANEL BOARD SCHEDULE.

**DRAWING E603 SPECIFIC NOTES**

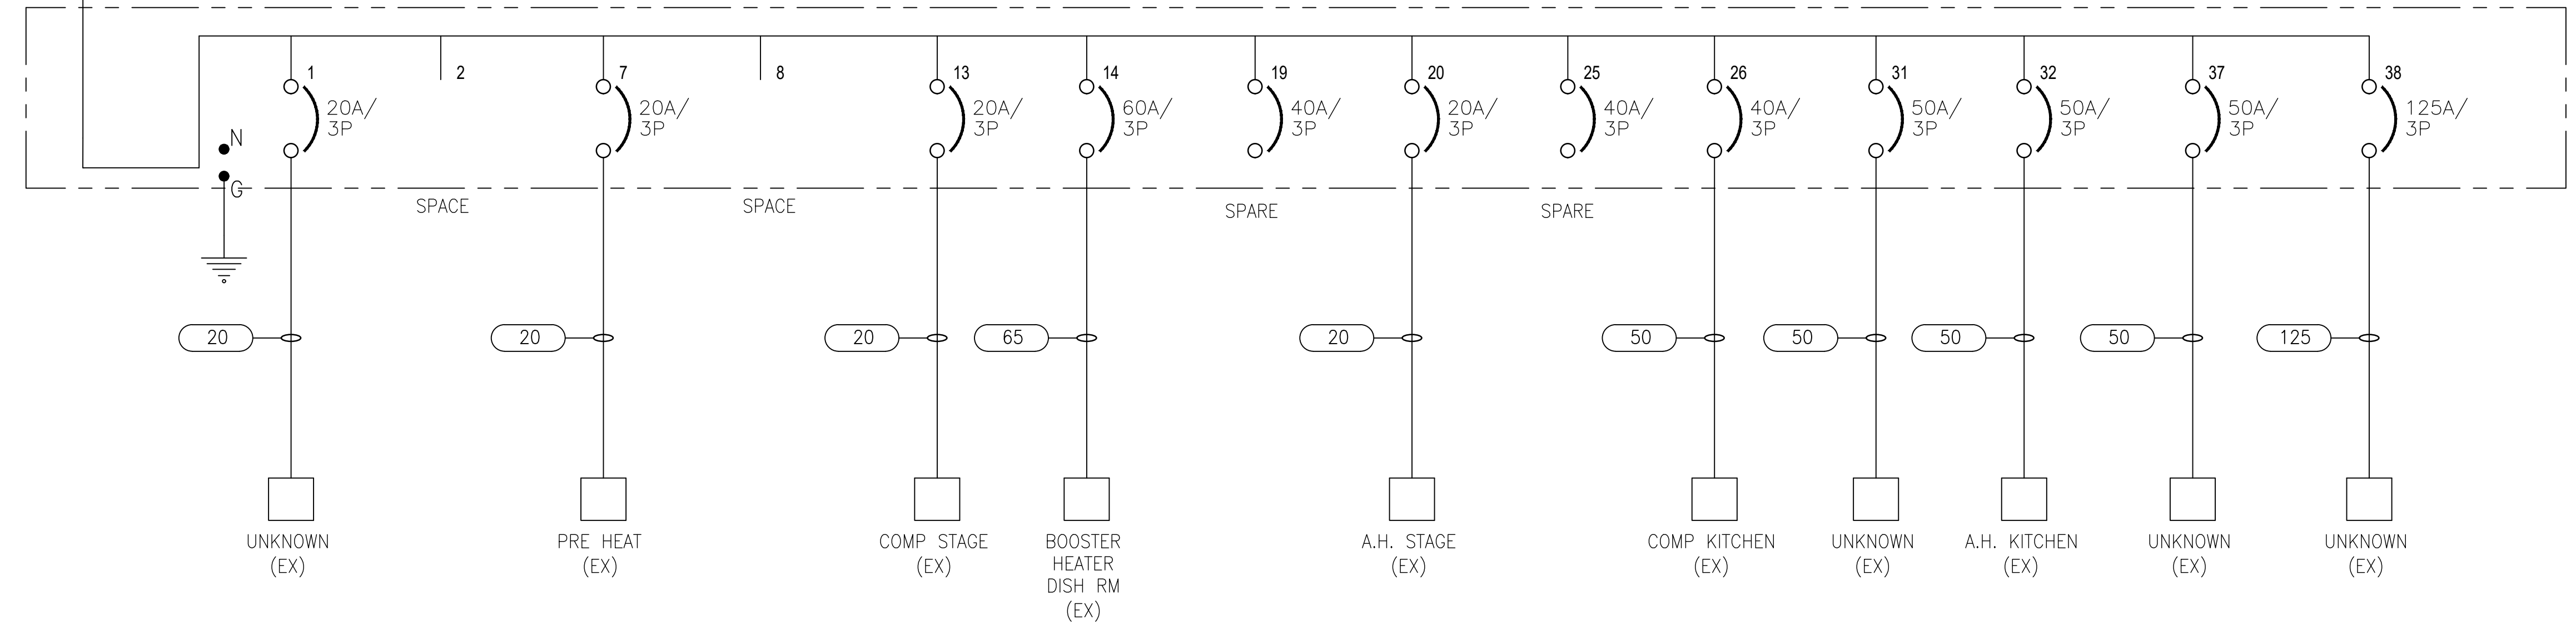1. CONTRACTOR SHALL DEMOLISH EXISTING SAFETY SWITCH AND CONTROLS, CONTRACTOR SHALL DEMOLISH FEED FROM SOURCE TO DISCONNECT. CONTRACTOR SHALL DEMOLISH ALL CONDUIT ABOVE GRADE. CONTRACTOR SHALL ABANDON CONDUIT 6" BELOW GRADE.



TO MAIN DISTRIBUTION PANEL

ACK (EX)  
 480/277V, 3 $\phi$ , 4W,  
 600A MLO, UNKNOWN AIC, NEMA 1  
 LOCATION: LOWER ELEMENTARY SCHOOL, TOTAL CONNECTED LOAD =XXX KVA,



TO TRANSFORMER

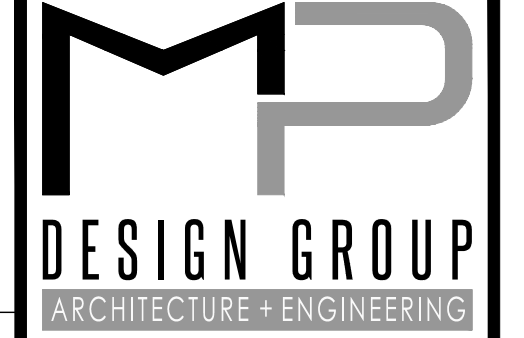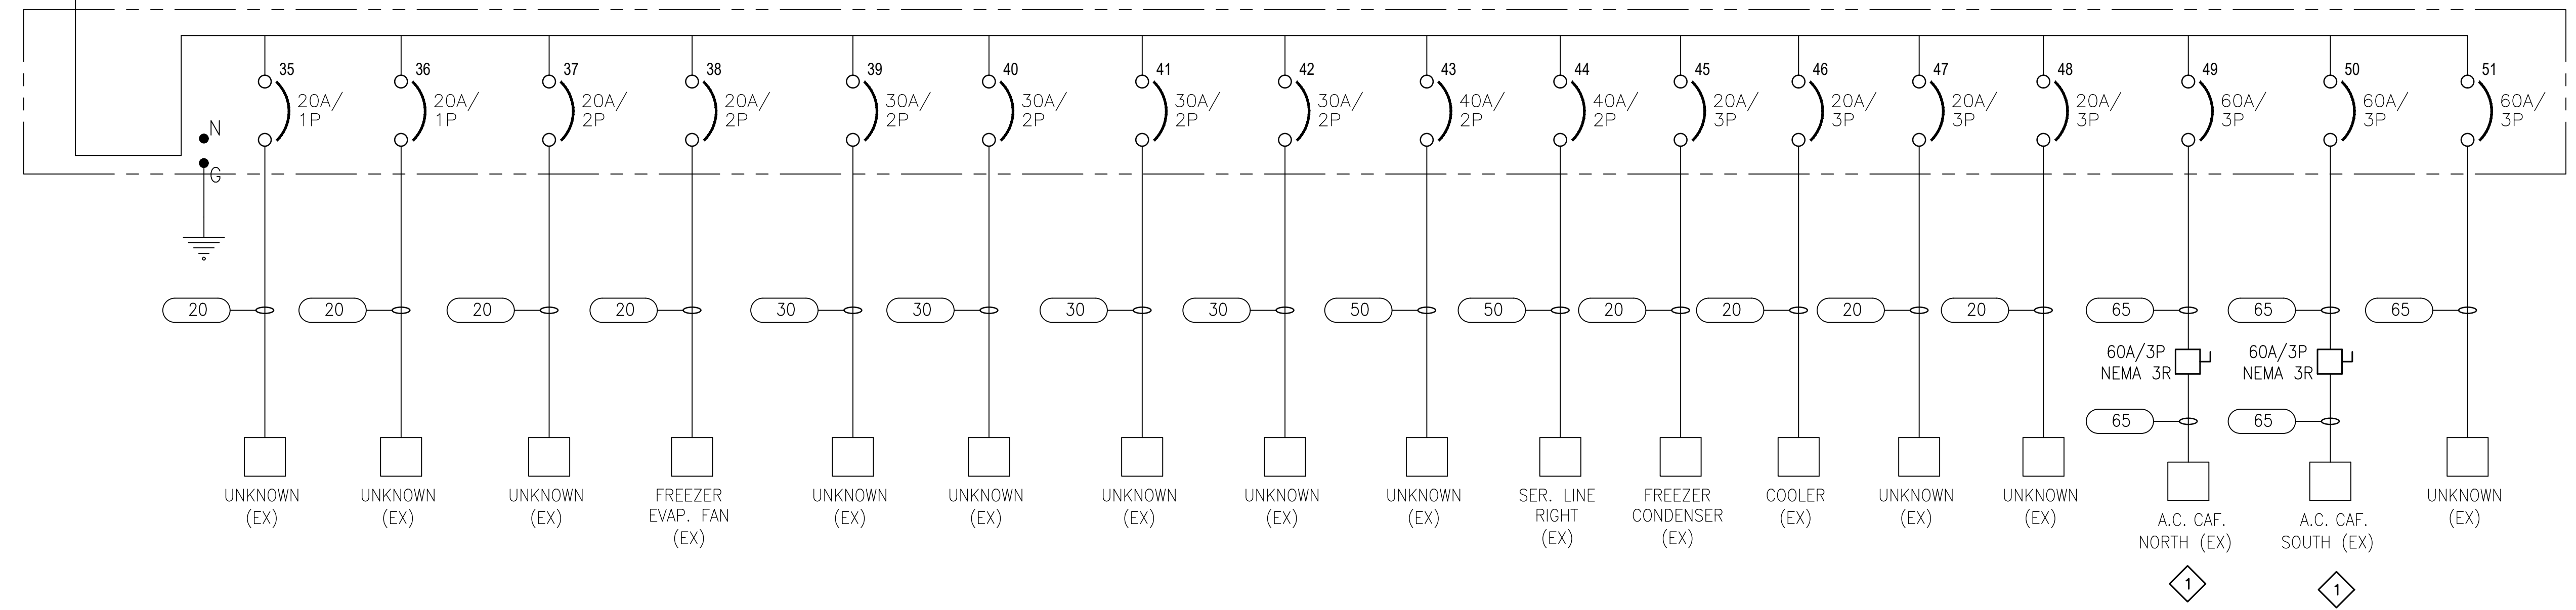KP2(SECTION 2)(EX)  
 208/120V, 3 $\phi$ , 4W,  
 400A MCB, UNKNOWN AIC, NEMA 1  
 LOCATION: LOWER ELEMENTARY SCHOOL, TOTAL CONNECTED LOAD =XXX KVA,



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 Fernanda A. Silva, AIA



**VANLEAVE SCHOOLS HVAC UPGRADES**  
**LOWER ELEMENTARY, MIDDLE, & HIGH SCHOOLS**  
 12602 HWY 57, 4725 BULLDOG LN,  
 & 12424 HWY 57  
 VANLEAVE, MISSISSIPPI 39565

SCALE: NTS  
 PROJECT NO: 0155.22.008  
 DRAWN BY: DLM  
 CHECKED BY: KDB

**ELECTRICAL ONE-LINE DIAGRAM**  
**DEMOLITION PLAN - LOWER ELEMENTARY SCHOOL**

NO.	DATE	REVISION / SUBMITTAL
REV 0	02.03.2023	ISSUED FOR CONSTRUCTION

E603

VERIFY SCALES  
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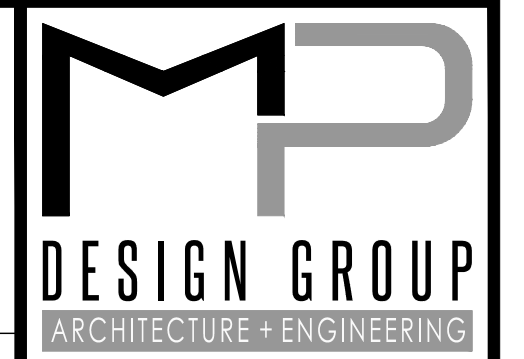
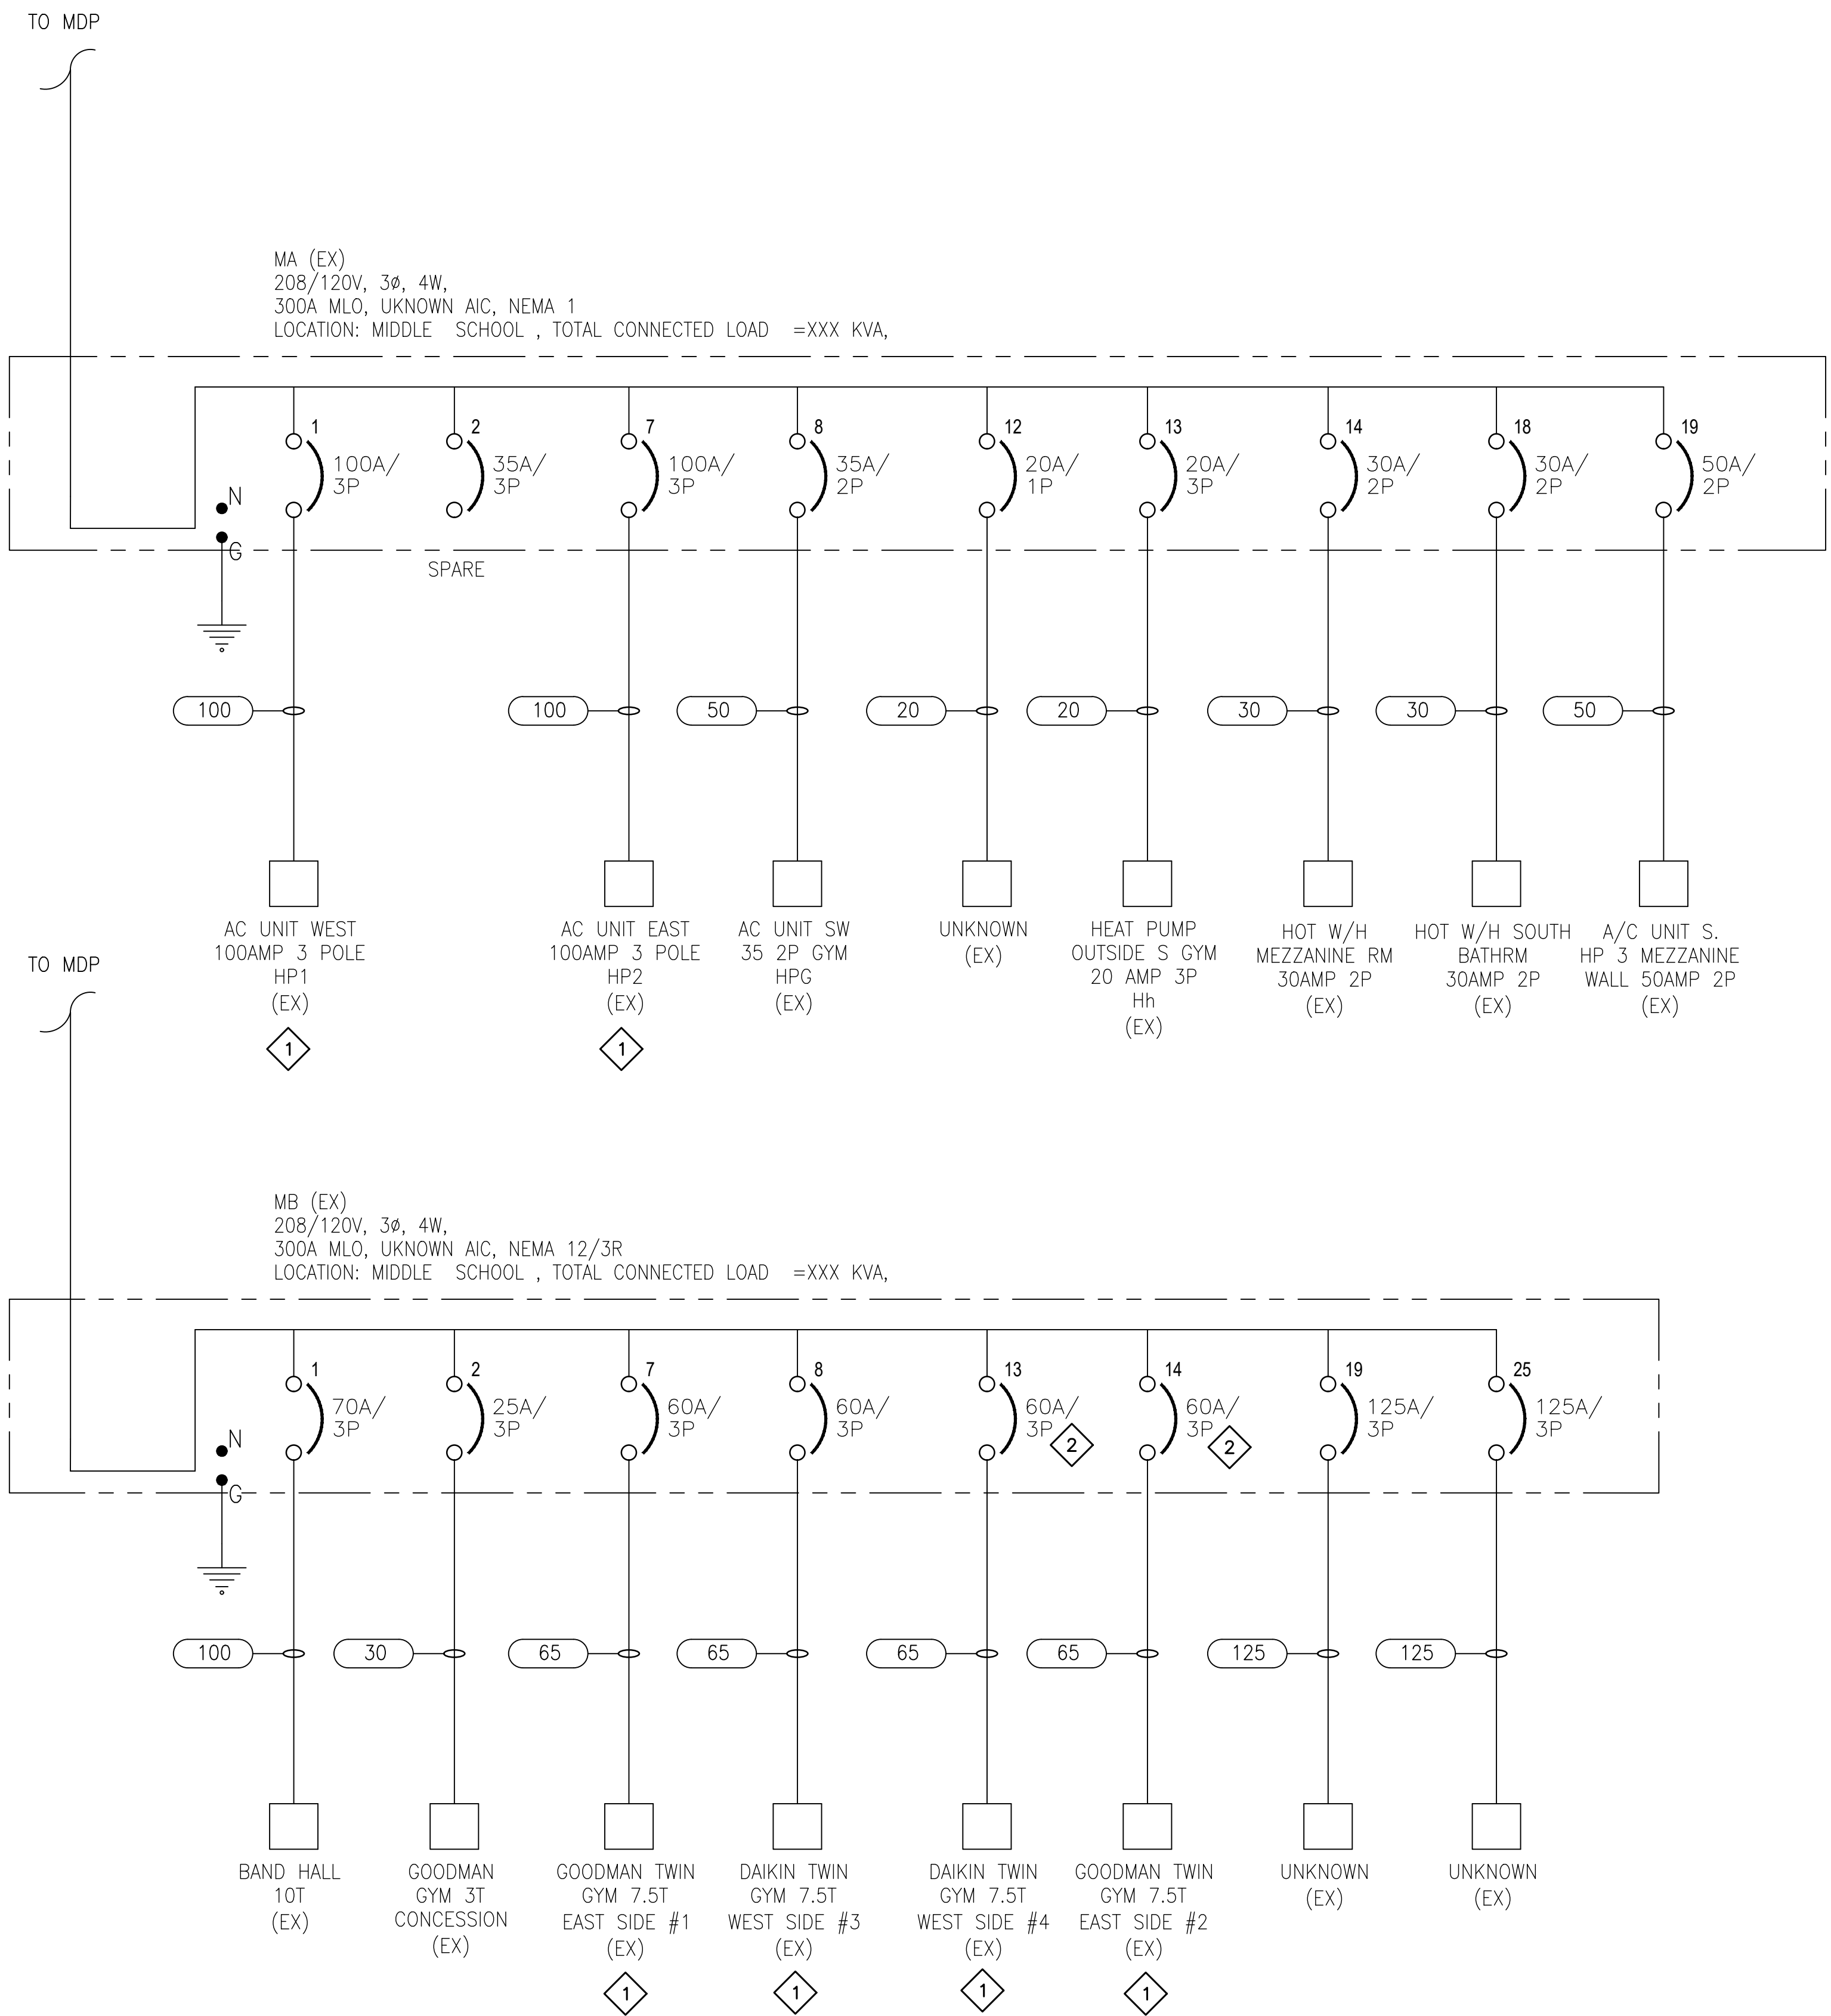
**DRAWING E604 NOTES**

1. CONTRACTOR SHALL COORDINATE WITH OWNER PRIOR TO DISPOSING ALL DEMOLISHED EQUIPMENT.
2. CONTRACTOR SHALL FILED VERIFY EXISTING PANEL BOARD SCHEDULE.

**DRAWING E604 SPECIFIC NOTES**

1. CONTRACTOR SHALL DEMOLISH EXISTING SAFETY SWITCH AND CONTROLS, CONTRACTOR SHALL DEMOLISH FEED FROM SOURCE TO DISCONNECT, CONTRACTOR SHALL DEMOLISH FEED AND CONDUIT FROM EQUIPMENT TO DISCONNECT, CONTRACTOR SHALL DEMOLISH ALL CONDUIT ABOVE GRADE, CONTRACTOR SHALL ABANDON CONDUIT 6" BELOW GRADE.

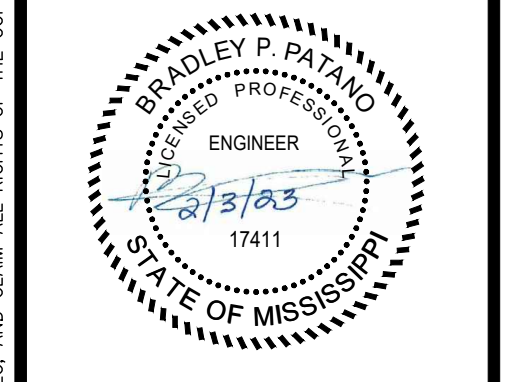
2. CONTRACTOR SHALL NOT DEMOLISH BREAKER.



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**VANCLEAVE SCHOOLS HVAC UPGRADES**

**LOWER ELEMENTARY, MIDDLE, & HIGH SCHOOLS**

12602 HWY 57, 4725 BULLDOG LN,  
 & 12424 HWY 57  
 VANCLEAVE, MISSISSIPPI 39565

SCALE: NTS  
 PROJECT NO: 0155.22.008  
 DRAWN BY: DLM  
 CHECKED BY: KDB

**ELECTRICAL ONE-LINE DIAGRAM**

**DEMOLITION PLAN- MIDDLE SCHOOL**

NO.	DATE	REVISION / SUBMITTAL
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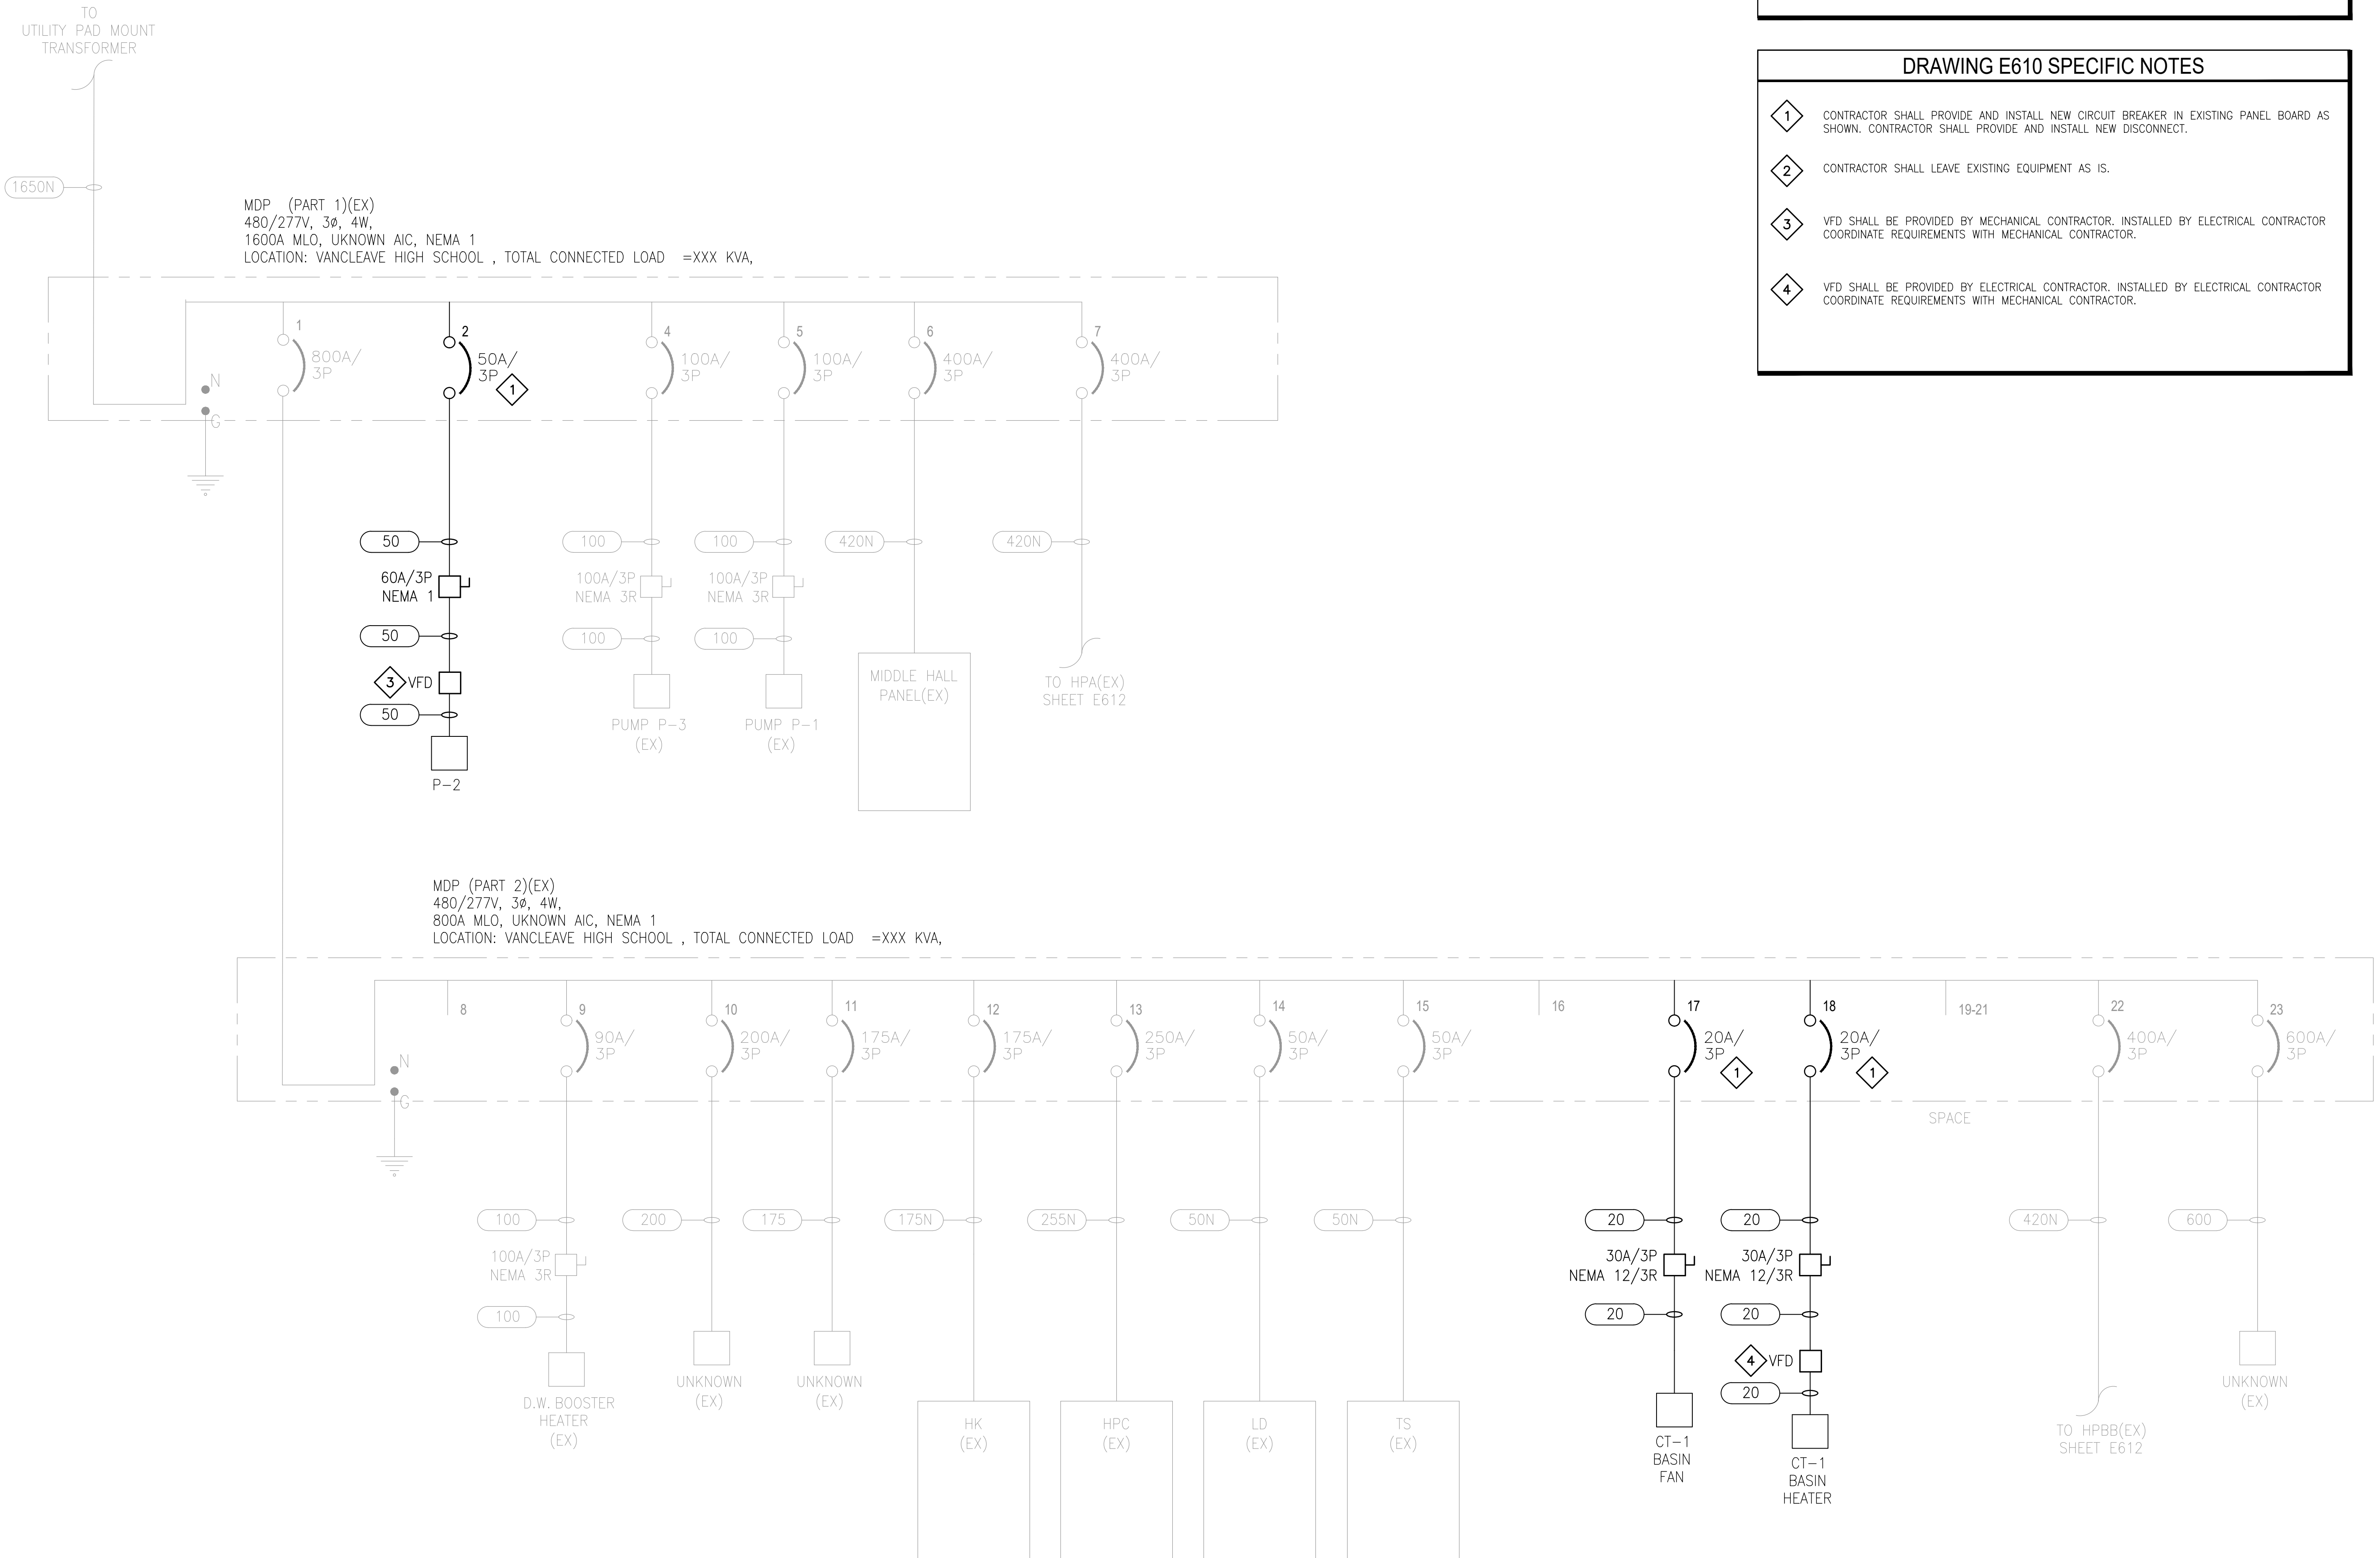
**E604**

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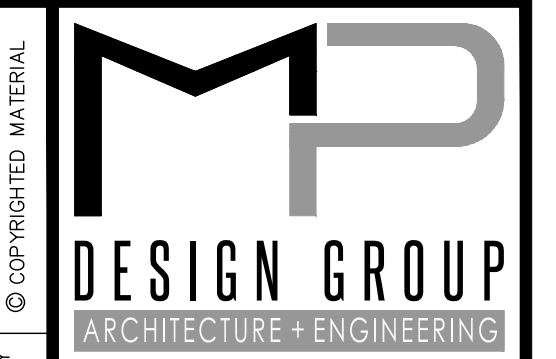


### DRAWING E610 NOTES

1. CONTRACTOR SHALL FIELD COORDINATE EXISTING MOUNTING SPACE FOR EXISTING PANELBOARD. CONTRACTOR SHALL MODIFY EXISTING PANEL BOARD FOR NEW EQUIPMENT.

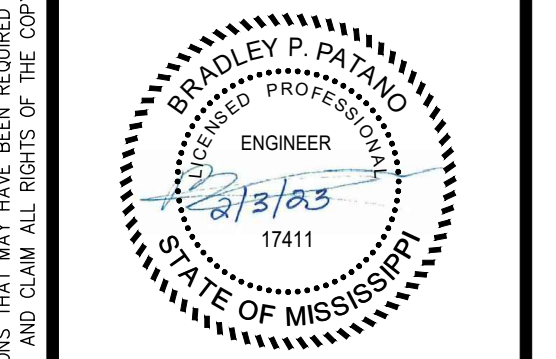
### DRAWING E610 SPECIFIC NOTES

- 1. CONTRACTOR SHALL PROVIDE AND INSTALL NEW CIRCUIT BREAKER IN EXISTING PANEL BOARD AS SHOWN. CONTRACTOR SHALL PROVIDE AND INSTALL NEW DISCONNECT.
- 2. CONTRACTOR SHALL LEAVE EXISTING EQUIPMENT AS IS.
- 3. VFD SHALL BE PROVIDED BY MECHANICAL CONTRACTOR. INSTALLED BY ELECTRICAL CONTRACTOR COORDINATE REQUIREMENTS WITH MECHANICAL CONTRACTOR.
- 4. VFD SHALL BE PROVIDED BY ELECTRICAL CONTRACTOR. INSTALLED BY ELECTRICAL CONTRACTOR COORDINATE REQUIREMENTS WITH MECHANICAL CONTRACTOR.



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**ELECTRICAL ONE-LINE DIAGRAM**  
**PLAN- HIGH SCHOOL**

NO.	DATE	REVISION / SUBMITTAL
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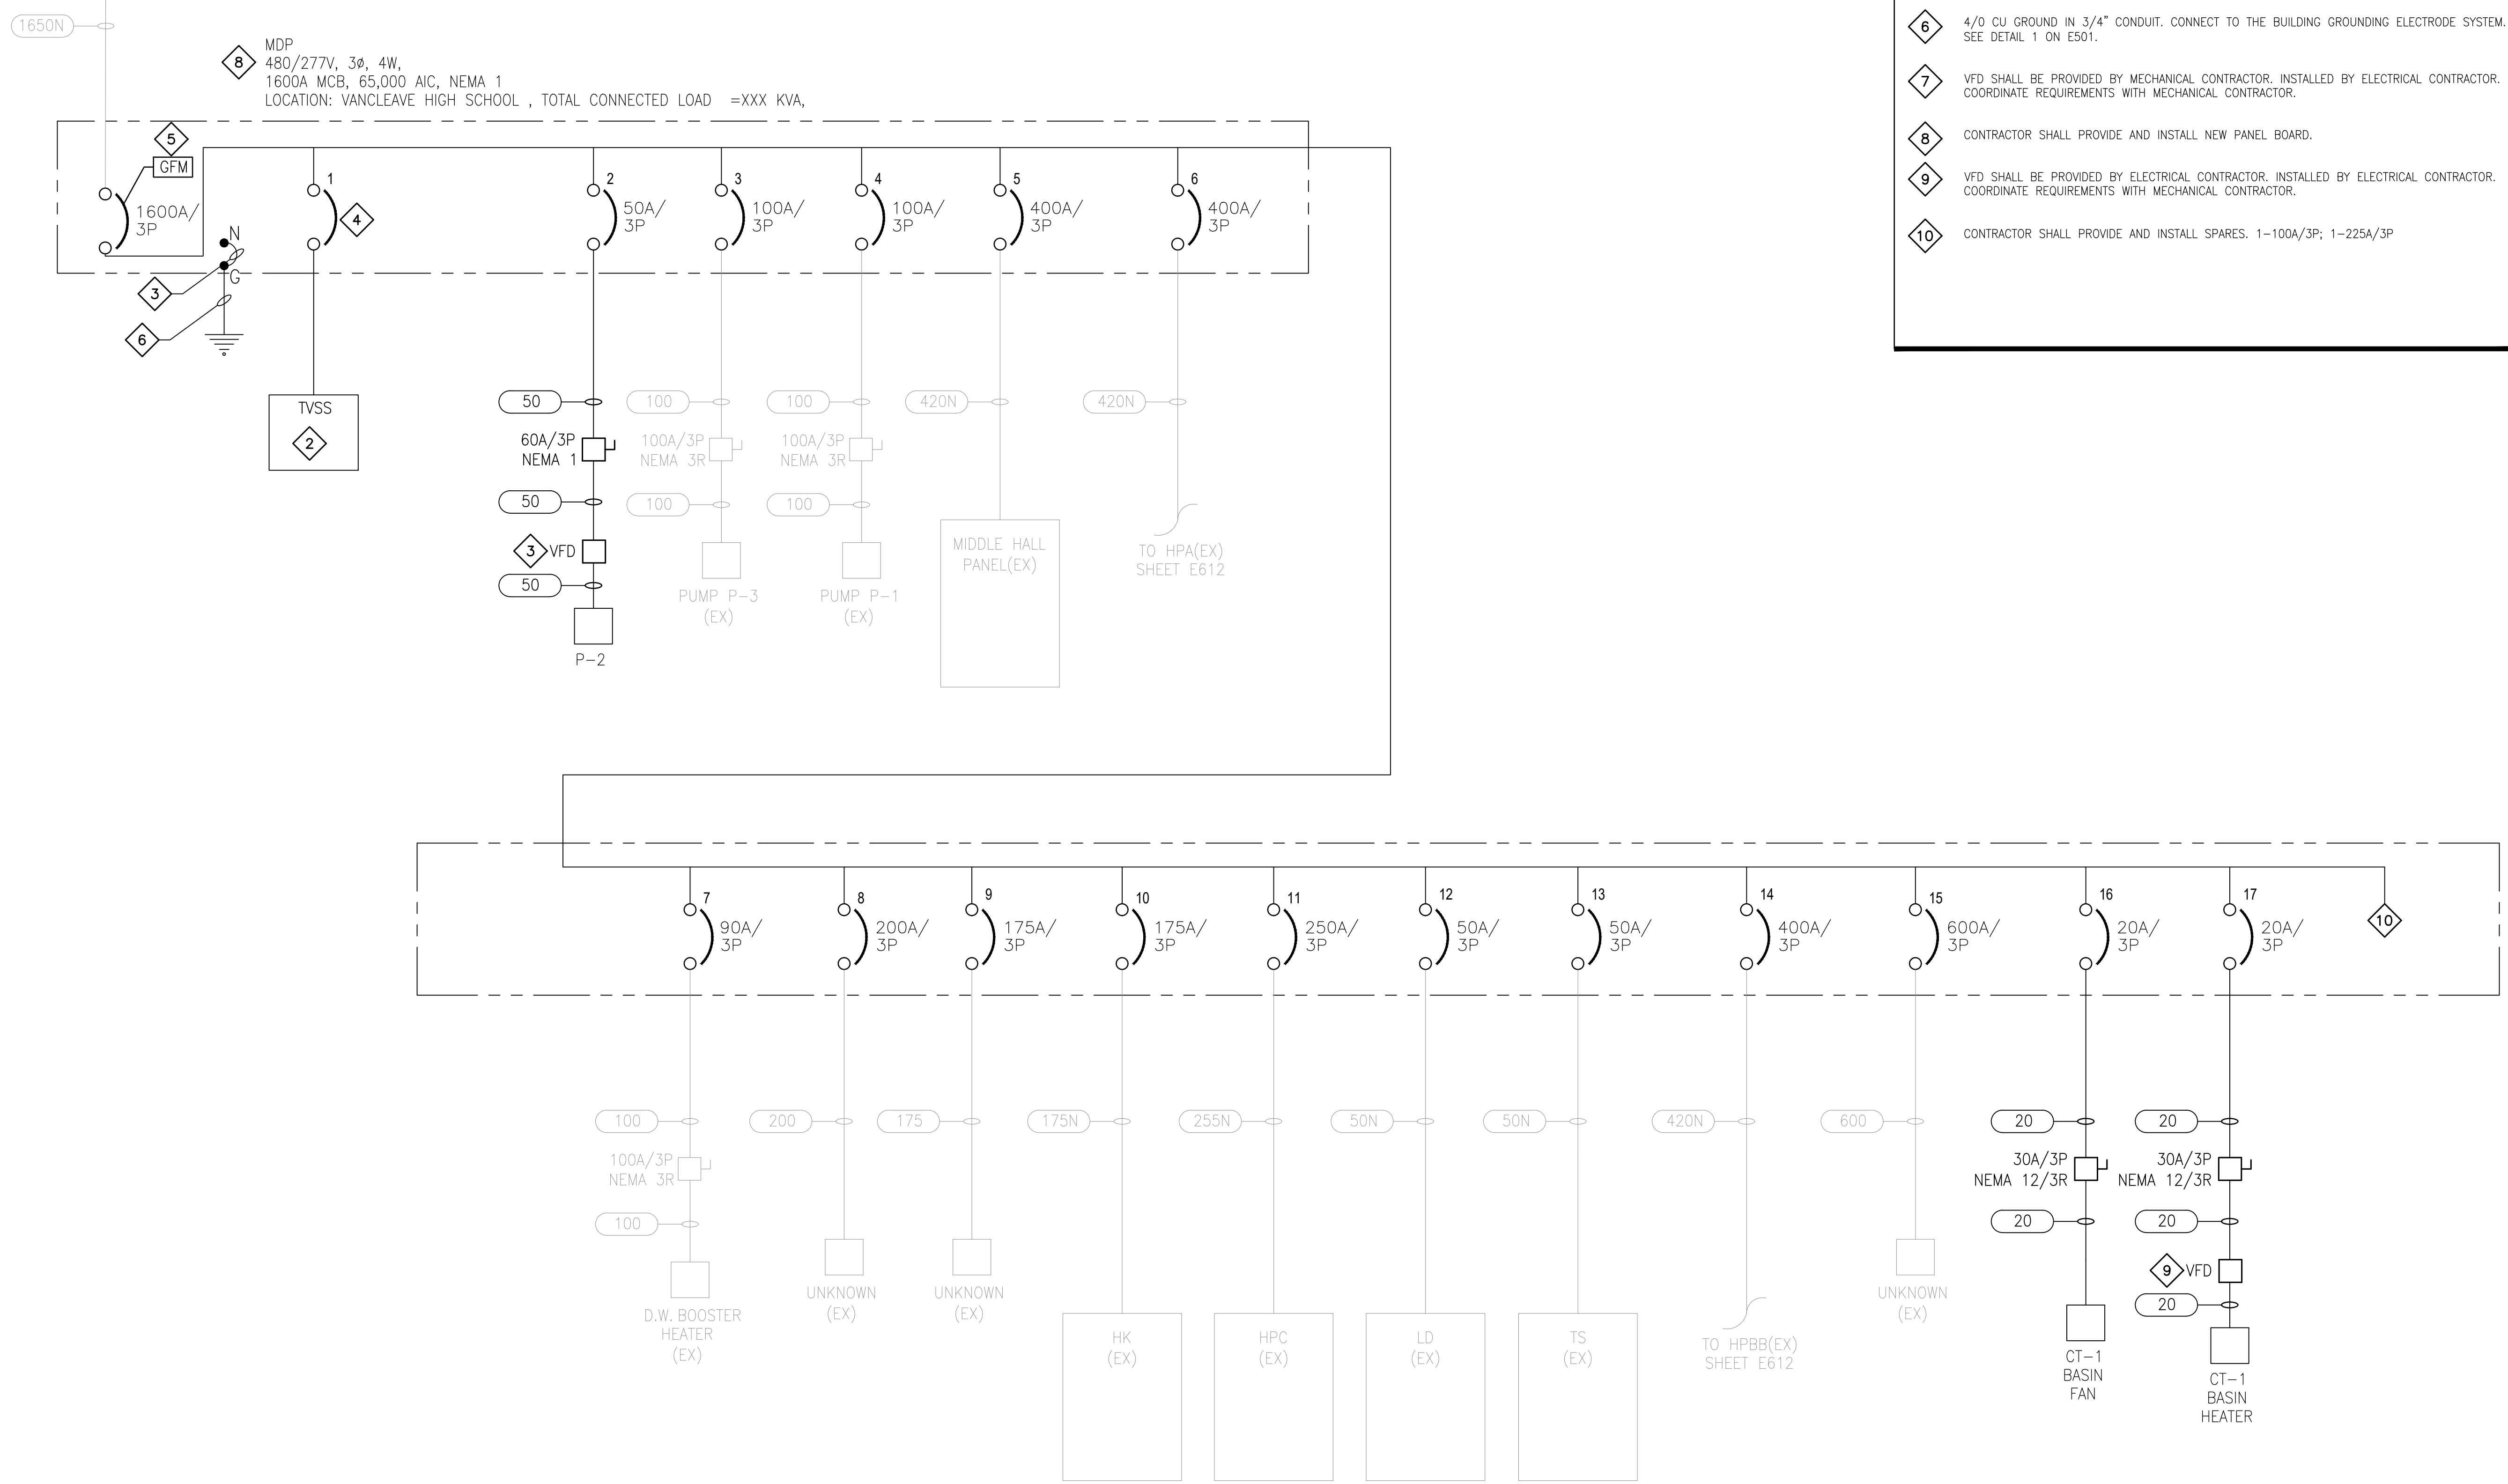
**E610**  
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TO  
UTILITY PAD MOUNT  
TRANSFORMER




**DRAWING E611 NOTES**


1. CONTRACTOR SHALL FIELD COORDINATE EXISTING MOUNTING SPACE FOR EXISTING PANEL BOARD. CONTRACTOR SHALL MODIFY EXISTING PANEL BOARD FOR NEW EQUIPMENT.
2. CONTRACTOR SHALL FIELD COORDINATE EXISTING MOUNTING SPACE FOR EXISTING PANEL BOARD. CONTRACTOR SHALL MODIFY EXISTING PANEL BOARD FOR NEW EQUIPMENT.

**DRAWING E611 SPECIFIC NOTES**

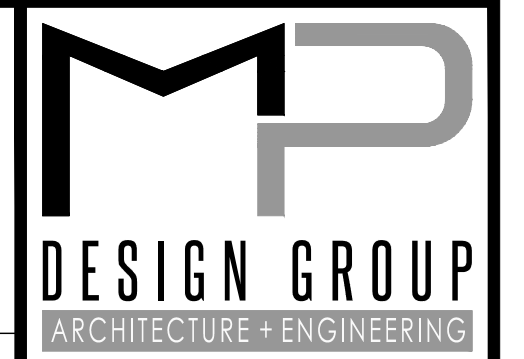- 1 NOT USED.
- 2 120KA SERVICE ENTRANCE RATED, INTERNALLY MOUNTED TVSS UNIT WITH AUDIBLE ALARM, ENABLE/DISABLE SWITCH AND (2) N.O./N.C. CONTACTS.
- 3 MAIN BONDING JUMPER SHALL BE #4/0 OR COPPER BAR EQUIVALENT.
- 4 BREAKER SHALL BE SIZED BY PANEL MANUFACTURER.
- 5 CONTRACTOR SHALL PROVIDE AND INSTALL ENERGY-REDUCTION MAINTENANCE SWITCH.
- 6 4/0 CU GROUND IN 3/4" CONDUIT. CONNECT TO THE BUILDING GROUNDING ELECTRODE SYSTEM. SEE DETAIL 1 ON E501.
- 7 VFD SHALL BE PROVIDED BY MECHANICAL CONTRACTOR. INSTALLED BY ELECTRICAL CONTRACTOR. COORDINATE REQUIREMENTS WITH MECHANICAL CONTRACTOR.
- 8 CONTRACTOR SHALL PROVIDE AND INSTALL NEW PANEL BOARD.
- 9 VFD SHALL BE PROVIDED BY ELECTRICAL CONTRACTOR. INSTALLED BY ELECTRICAL CONTRACTOR. COORDINATE REQUIREMENTS WITH MECHANICAL CONTRACTOR.
- 10 CONTRACTOR SHALL PROVIDE AND INSTALL SPARES. 1-100A/3P; 1-225A/3P



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**LOWER ELEMENTARY, MIDDLE, & HIGH SCHOOLS**  
 12602 HWY 57, 4725 BULLDOG LN,  
 & 12424 HWY 57  
 VANCLEAVE, MISSISSIPPI 39565

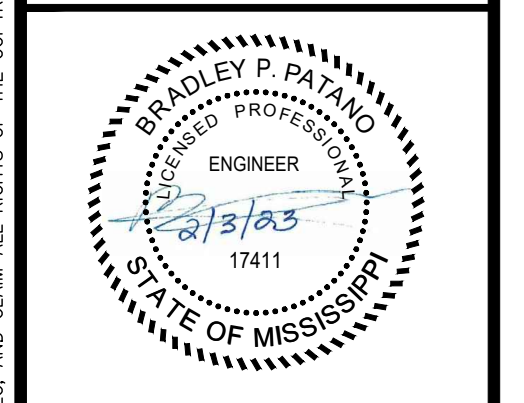SCALE: NTS  
 PROJECT NO: 0155.22.008  
 DRAWN BY: DLM  
 CHECKED BY: KDB

**ELECTRICAL ONE-LINE DIAGRAM**  
**PLAN- HIGH SCHOOL-**  
**ALTERNATE #1**

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**E611**  
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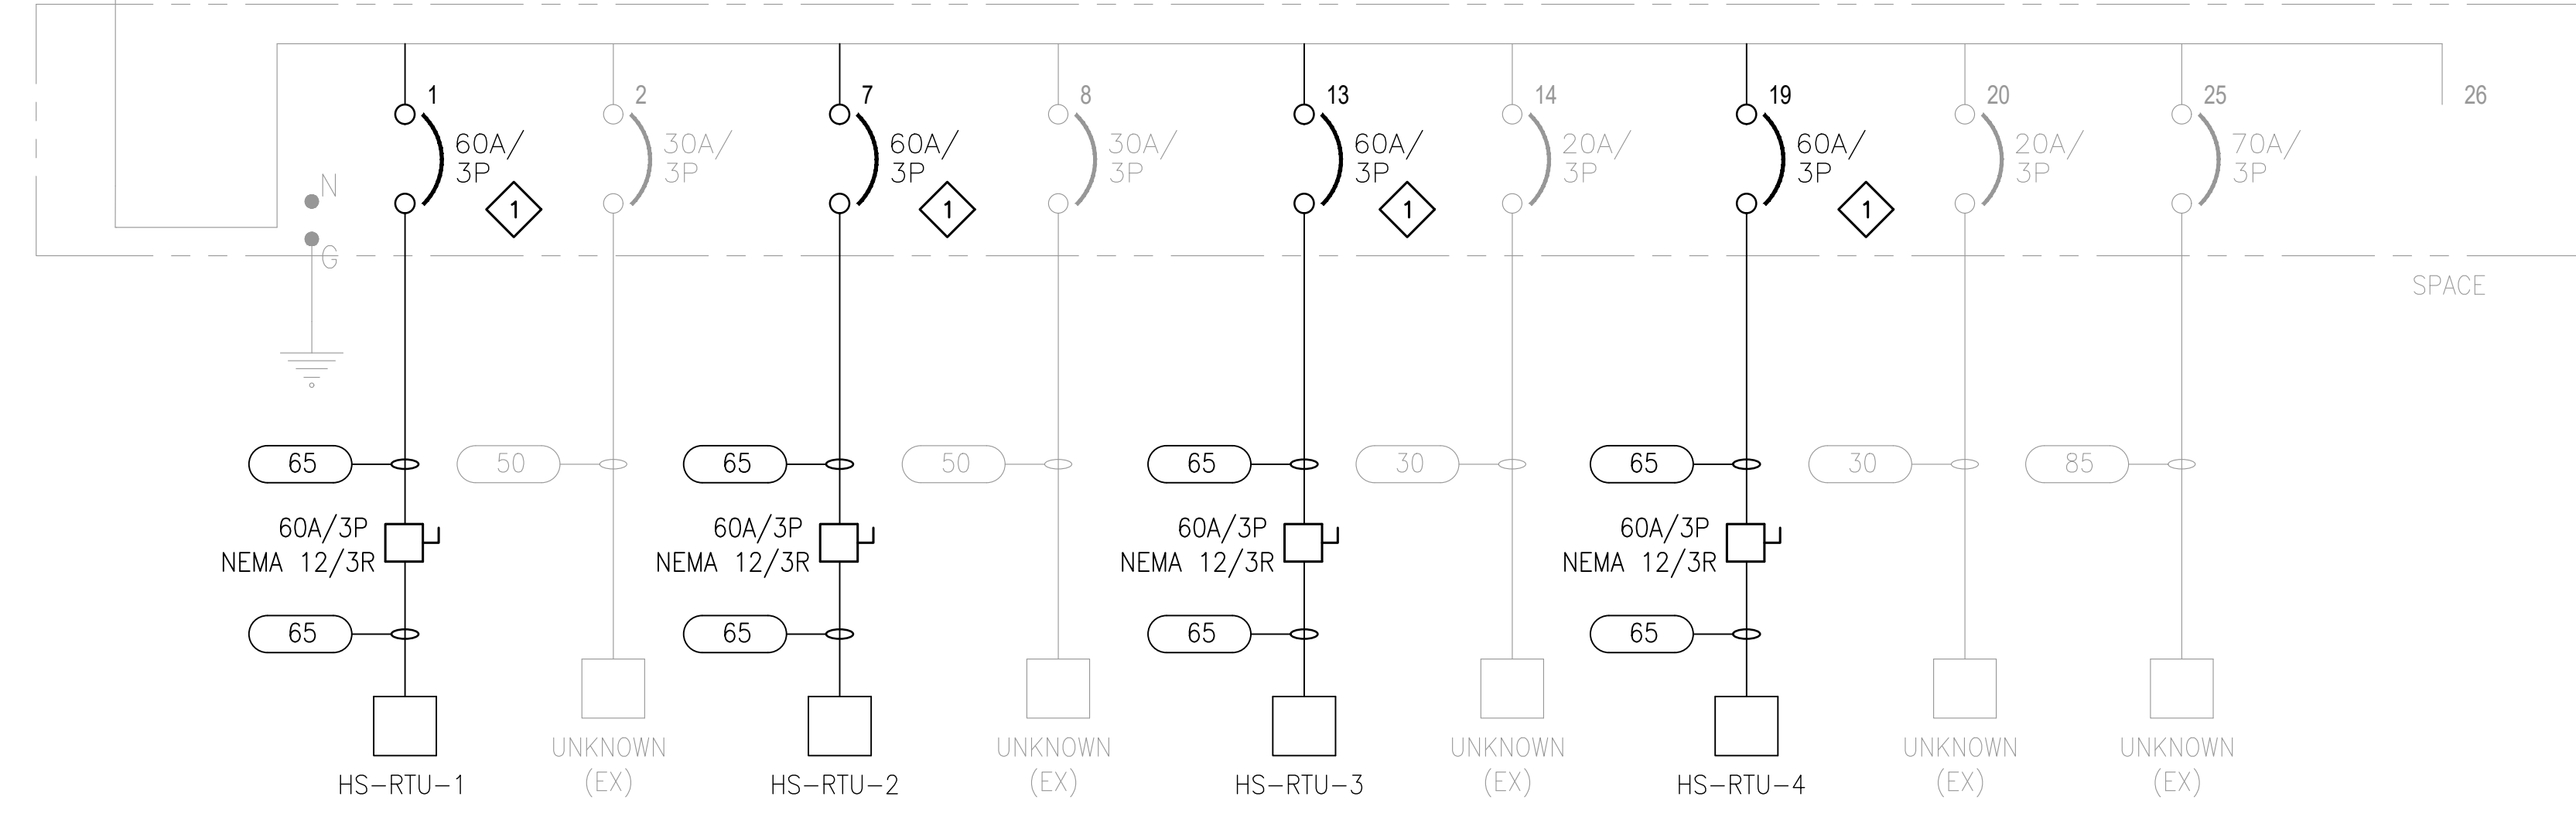
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TO MDP  
SHEET E601


HPBB (EX)  
480/277V, 3Ø, 4W,  
400A MLO, UNKNOWN AIC, NEMA 1  
LOCATION: VANCLEAVE HIGH SCHOOL , TOTAL CONNECTED LOAD =XXX KVA,



TO MDP  
SHEET E601

420N

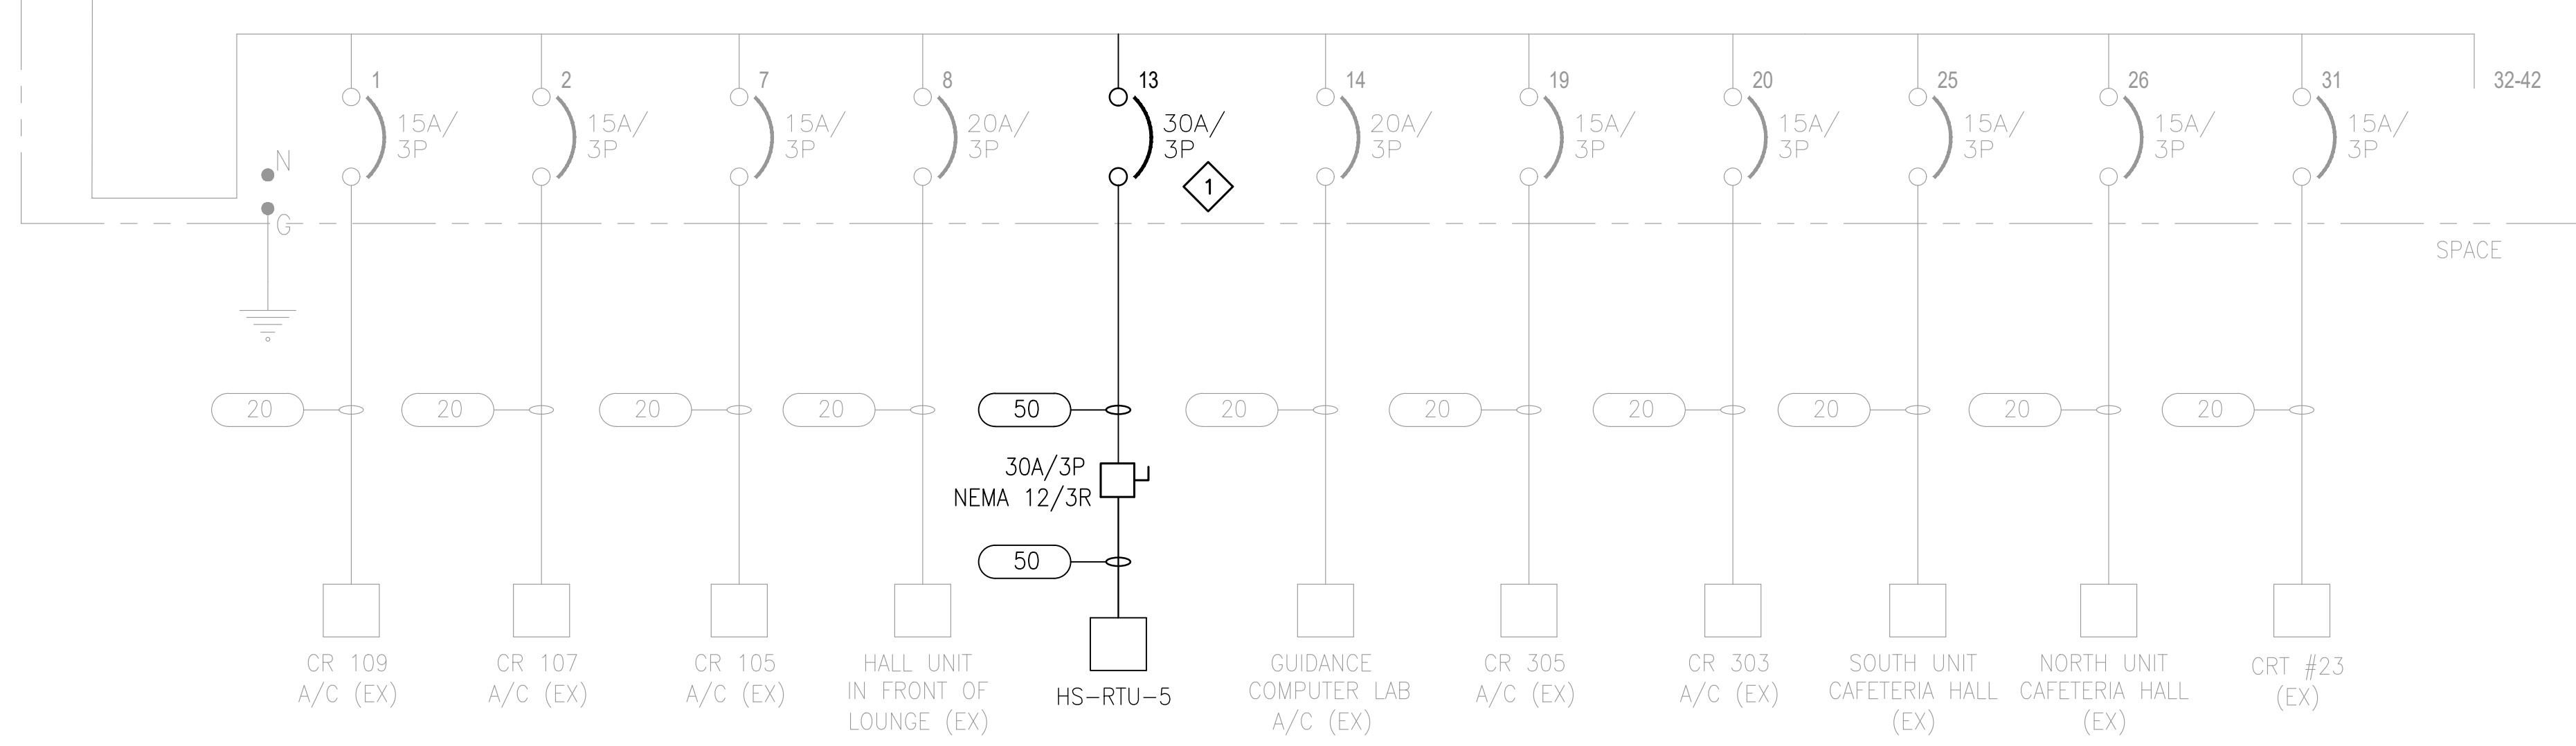HPA (PART 1)(EX)  
480/277V, 3Ø, 4W,  
400A MLO, UNKNOWN AIC, NEMA 1  
LOCATION: VANCLEAVE HIGH SCHOOL , TOTAL CONNECTED LOAD =XXX KVA,




DRAWING E612 NOTES

- CONTRACTOR SHALL FIELD COORDINATE EXISTING MOUNTING SPACE FOR EXISTING PANELBOARD. CONTRACTOR SHALL MODIFY EXISTING PANEL BOARD FOR NEW EQUIPMENT.

DRAWING E612 SPECIFIC NOTES

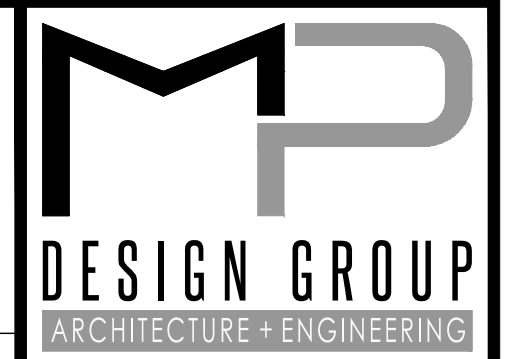- CONTRACTOR SHALL PROVIDE AND INSTALL NEW CIRCUIT BREAKER IN EXISTING PANEL BOARD AS SHOWN. CONTRACTOR SHALL PROVIDE AND INSTALL NEW DISCONNECT.



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& 12424 HWY 57  
VANCLEAVE, MISSISSIPPI 39566

SCALE: NTS  
PROJECT NO: 0155.22.008  
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**ELECTRICAL ONE-LINE DIAGRAM**  
**PLAN- HIGH SCHOOL**

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**E612**

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**DRAWING E613 NOTES**

1. CONTRACTOR SHALL FIELD COORDINATE EXISTING MOUNTING SPACE FOR EXISTING PANELBOARD.  
 CONTRACTOR SHALL MODIFY EXISTING PANEL BOARD FOR NEW EQUIPMENT.

**DRAWING E613 SPECIFIC NOTES**

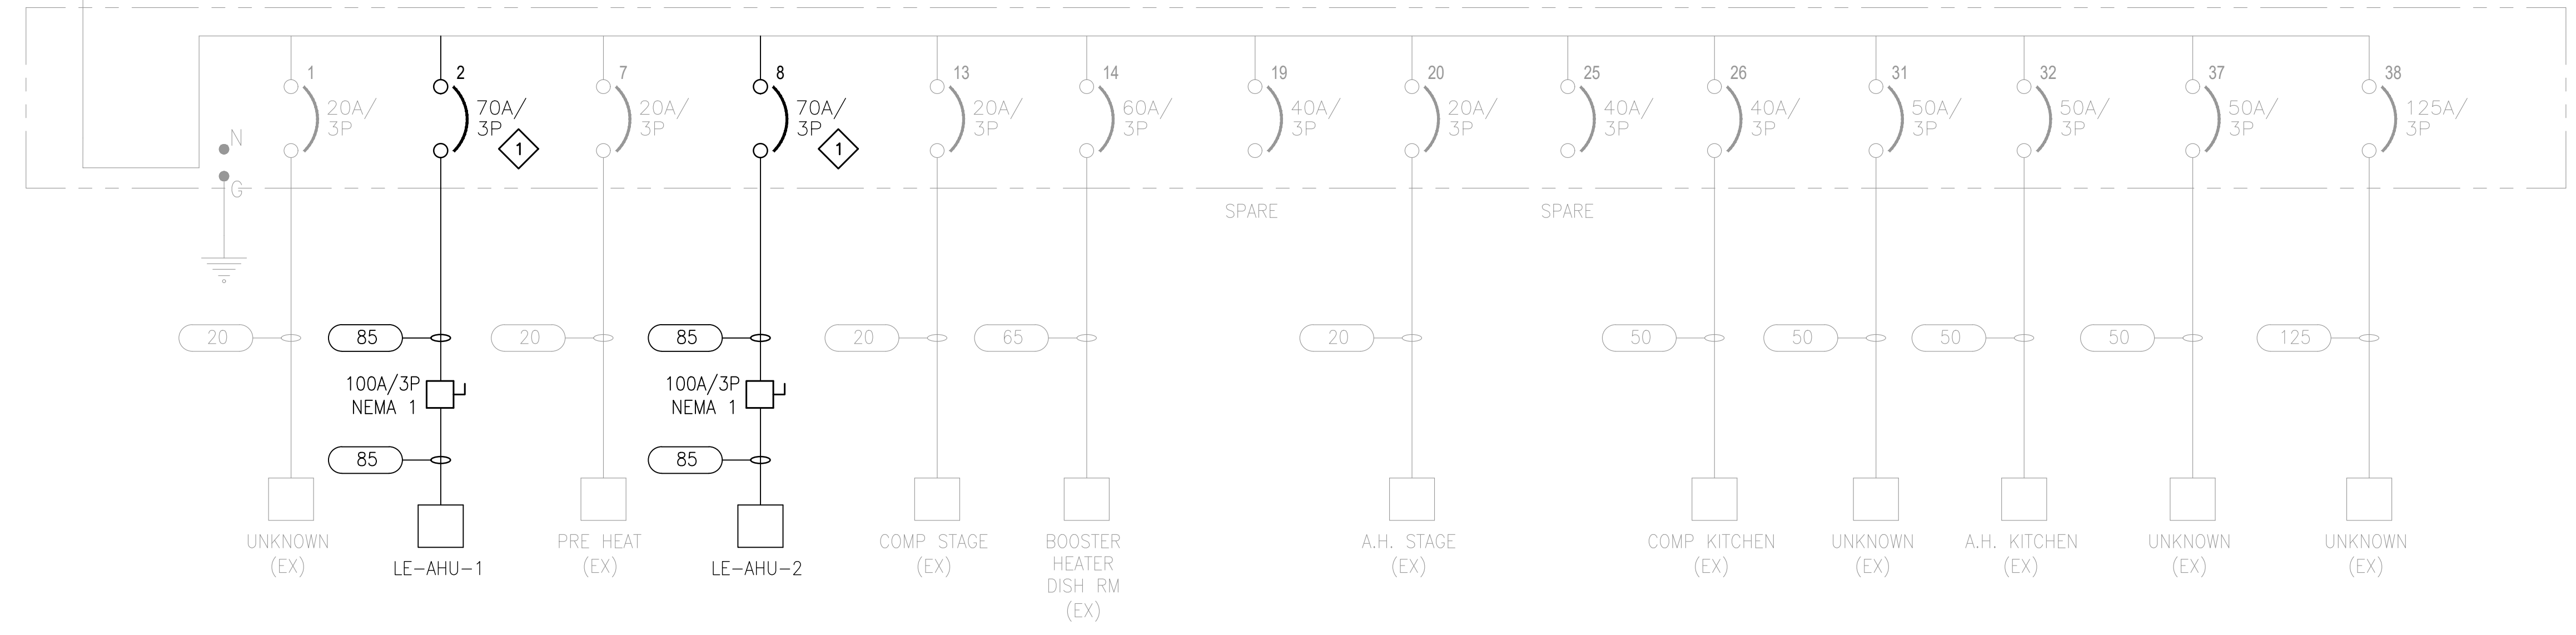
1. CONTRACTOR SHALL PROVIDE AND INSTALL NEW CIRCUIT BREAKER IN EXISTING PANEL BOARD AS SHOWN.

2. NOT NEEDED.

3. CONTRACTOR SHALL REFERENCE SHEET E151 FOR LOCATION OF RECEPTACLE.


TO MAIN DISTRIBUTION PANEL

ACK (EX)  
 480/277V, 3Ø, 4W,  
 600A MLO, UNKNOWN AIC, NEMA 1  
 LOCATION: LOWER ELEMENTARY SCHOOL, TOTAL CONNECTED LOAD =XXX KVA,




TO TRANSFORMER

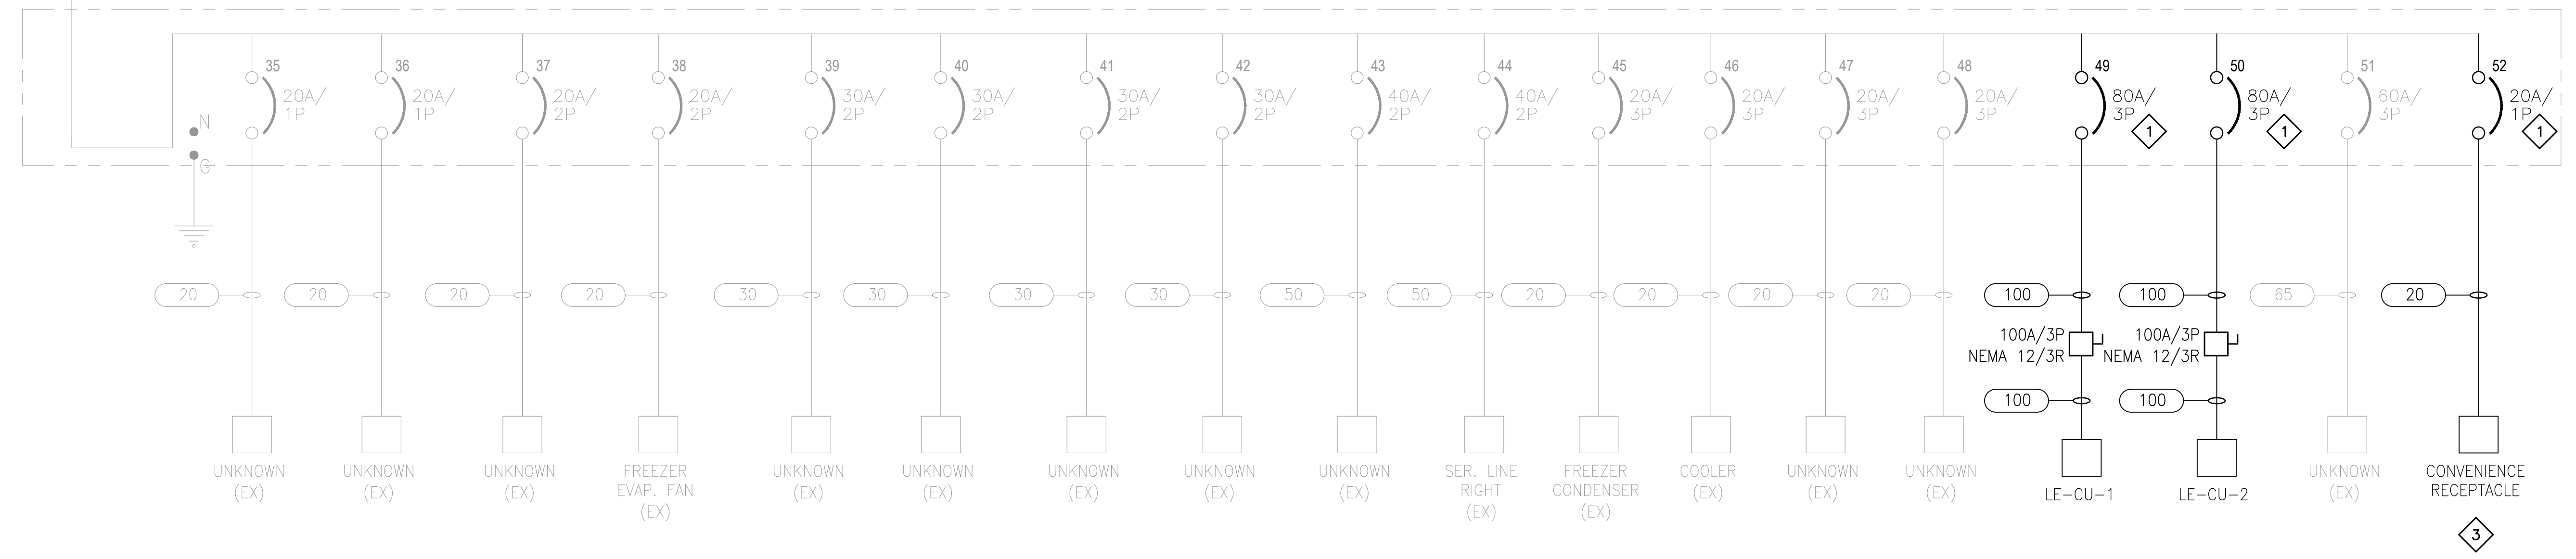KP2(SECTION 2)(EX)  
 208/120V, 3Ø, 4W,  
 400A MCB, UNKNOWN AIC, NEMA 1  
 LOCATION: LOWER ELEMENTARY SCHOOL, TOTAL CONNECTED LOAD =XXX KVA,



3

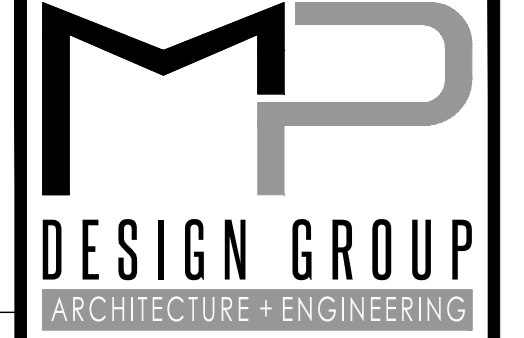

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SCALE: NTS  
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**ELECTRICAL ONE-LINE DIAGRAM**  
**PLAN- LOWER ELEMENTARY SCHOOL**

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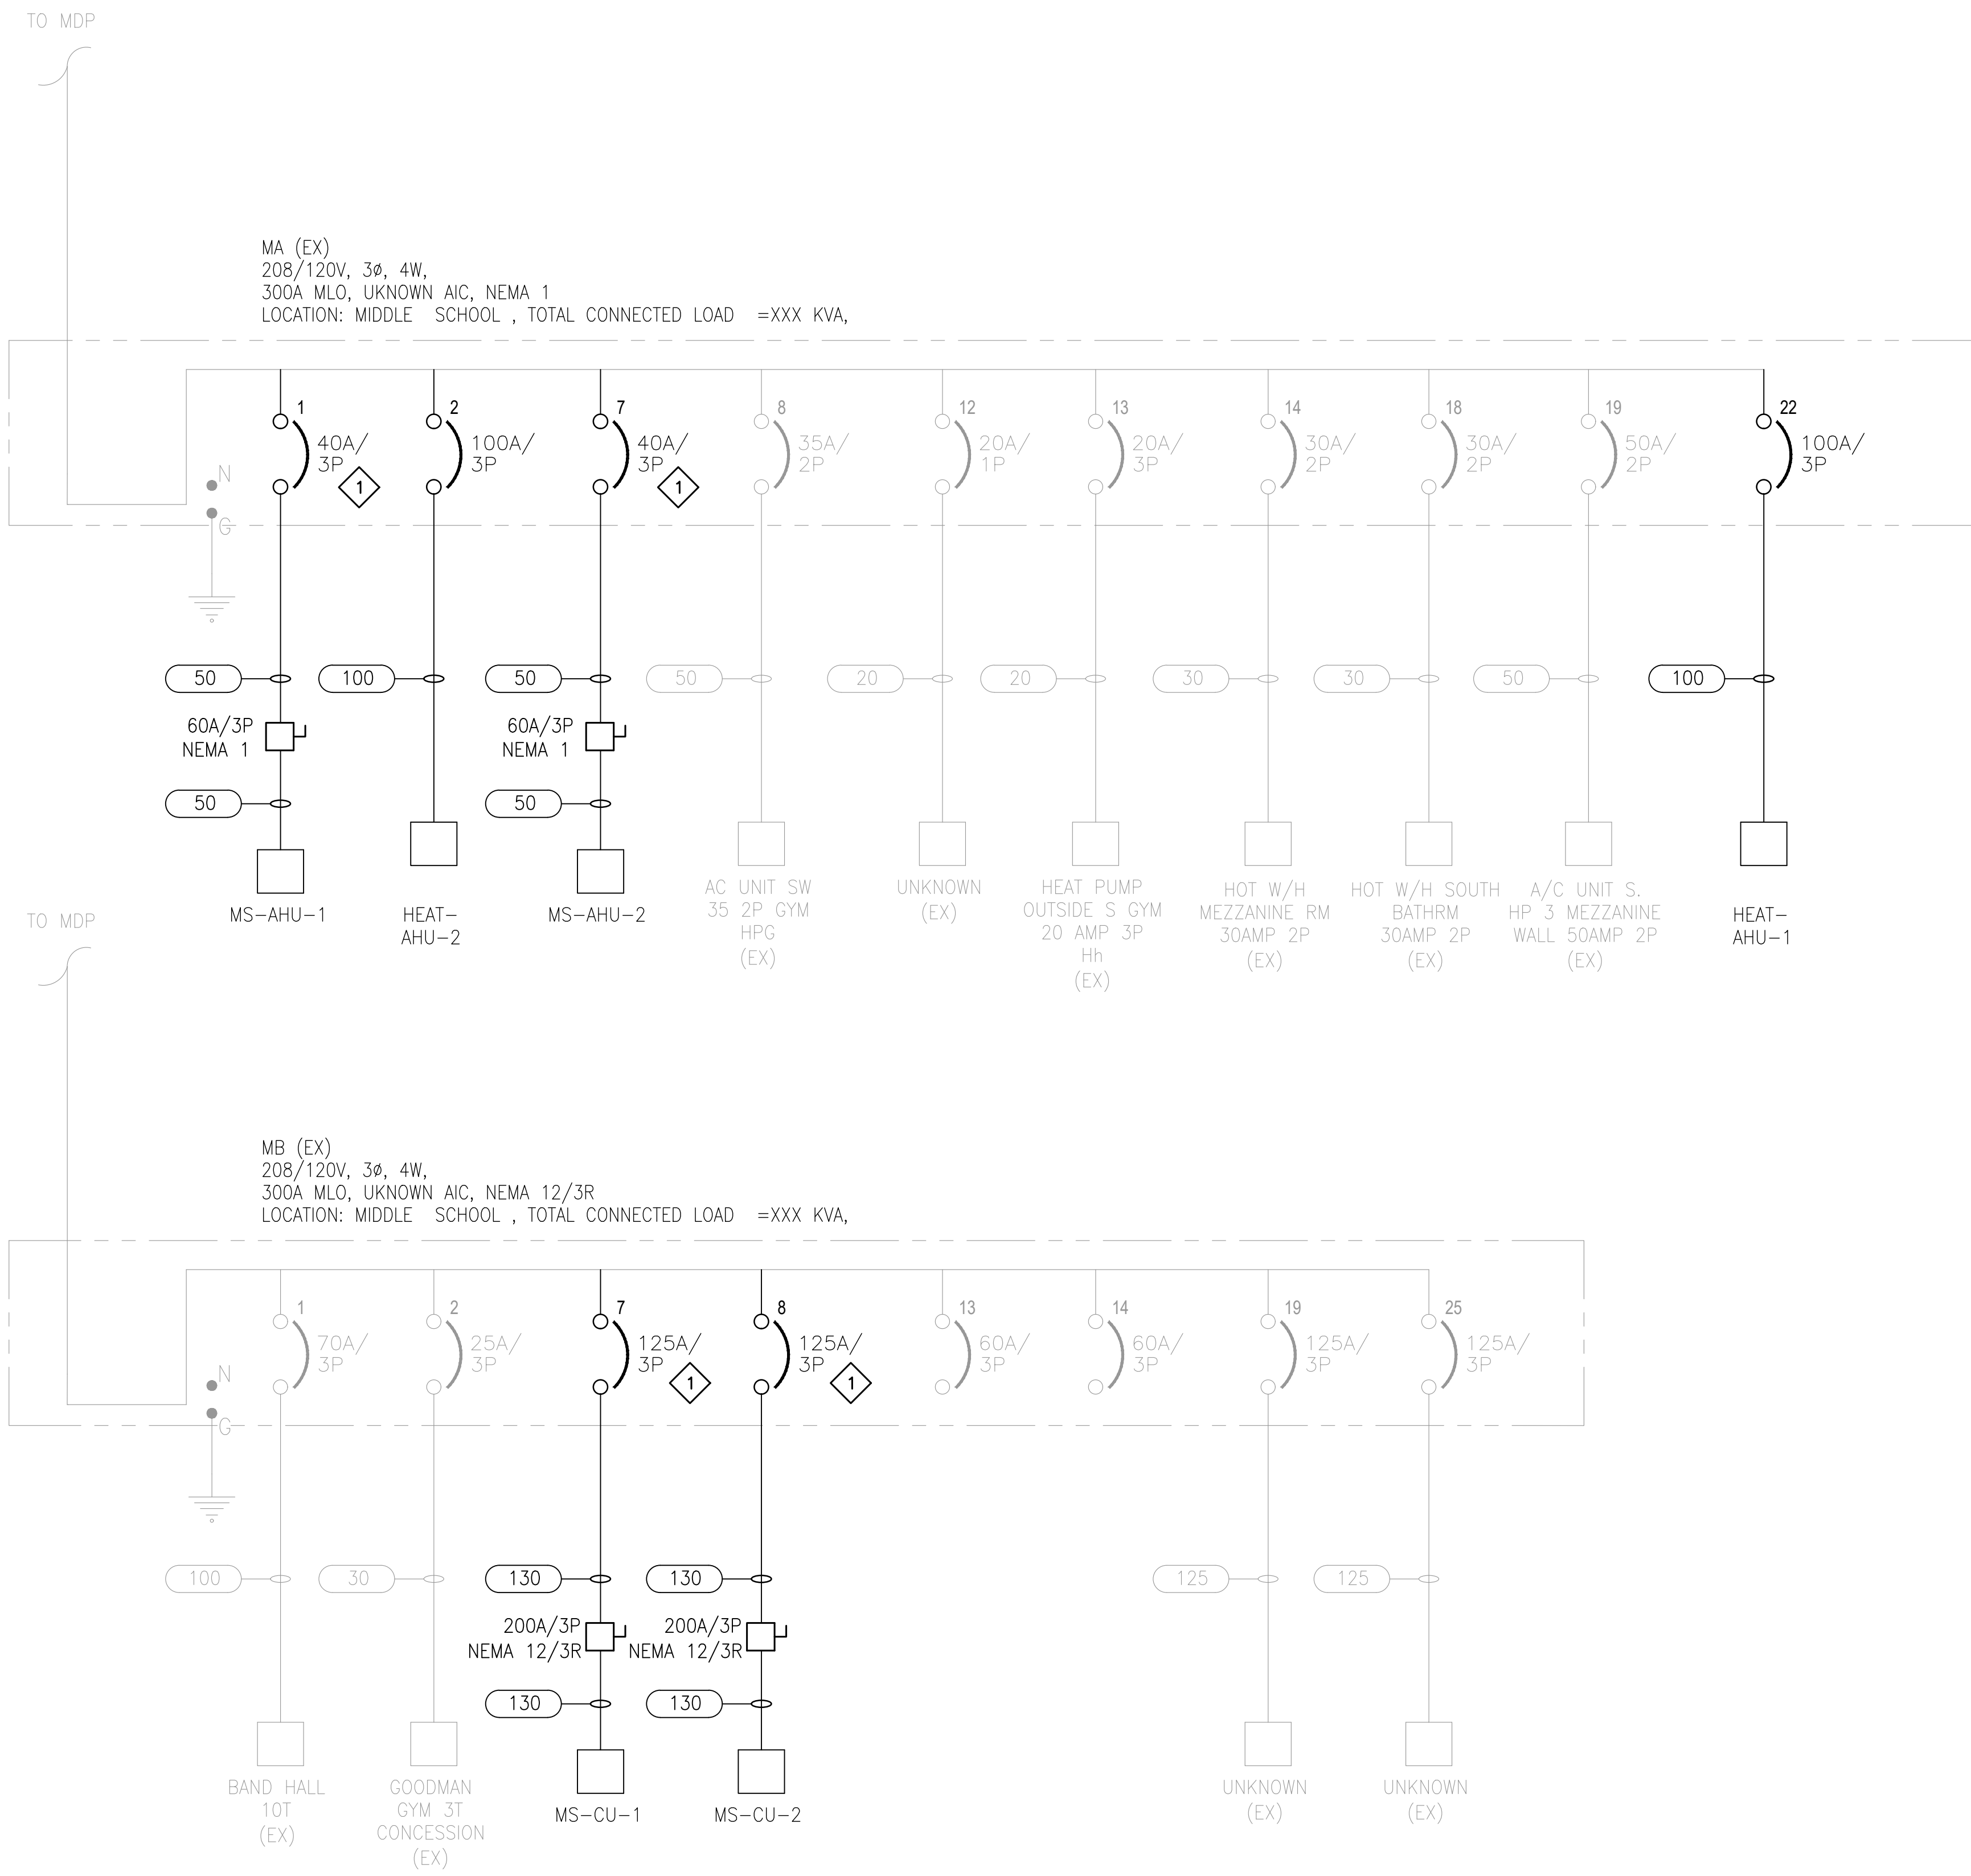
**E613**

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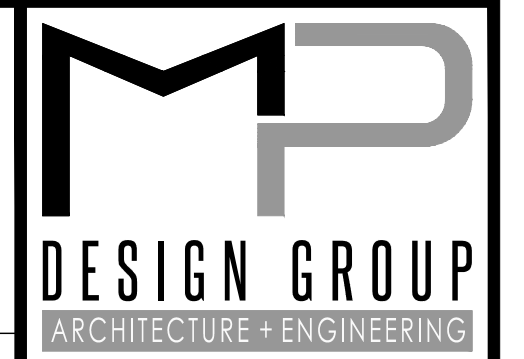


**DRAWING E614 NOTES**

- CONTRACTOR SHALL FIELD COORDINATE EXISTING MOUNTING SPACE FOR EXISTING PANELBOARD. CONTRACTOR SHALL MODIFY EXISTING PANEL BOARD FOR NEW EQUIPMENT.

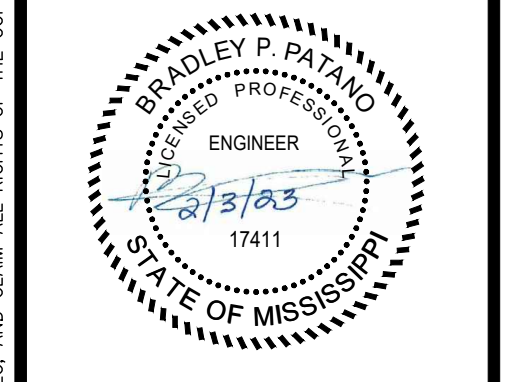
**DRAWING E614 SPECIFIC NOTES**

- CONTRACTOR SHALL PROVIDE AND INSTALL NEW CIRCUIT BREAKER IN EXISTING PANEL BOARD AS SHOWN. CONTRACTOR SHALL PROVIDE AND INSTALL NEW DISCONNECT.
- NOT NEEDED.



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**PLAN- MIDDLE SCHOOL**

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